

No PID
C No. 780059

STATE OF OHIO

DEPARTMENT OF TRANSPORTATION

I-480-3 (4) 153

FED. RD. DIVISION	STATE	PROJECT	
5	OHIO	I-480-3(4)153	1 375

LORAIN COUNTY
LOR. - 480-0.00

NOTE: Project Designation LOR-80-18.62 appearing thru-out this plan shall be understood to read LOR-480-0.00

"LIMITED ACCESS"

This improvement is especially designed for thru traffic and has been declared a Limited Access Highway or Freeway by action of the Director of Transportation, in accordance with the provisions of Sec. 5511.02 of The Revised Code of Ohio.

1977 SPECIFICATIONS

The Standard Specifications of the State of Ohio, Department of Transportation, including changes and supplemental specifications listed in the proposal, shall govern this improvement.

The Right of Way for this improvement will be provided by the State of Ohio.

I hereby approve these plans and declare that the making of this improvement will not require the closing of the highway to traffic and that provisions for maintenance and safety of traffic will be as set forth on the plans and estimates.

Approved A. D. Reader
Date 1-30-76 District Deputy Director of Transportation
Approved Robert B. Pfeiffer
Date 12-21-77 Engineer, Bureau of Bridges and Structures
Approved R. E. Guthrie
Date 12-22-77 Chief Engineer, Planning and Design
Approved David L. Wein
Date 12-22-77 Director, Department of Transportation

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Sheets 274 & 275 revised 5.11.78 EBL

LINE DATA

Begin Project ~ Sta. 975+50.00 to Sta. 998+03.01 (Bk) @ I-480 E.B. = 2,253.01 L.F.
Sta. 0+301.74(h) to Sta. 32+31.00 (Toll Plaza) @ I-480 E.B. = 3,200.83 L.F.
Sta. 37+31.00 (Toll Plaza) to Sta. 74+11.39 @ I-480 E.B. = 3,680.39 L.F.
Sta. 74+11.39 to Sta. 100+00.00 @ I-480 End Project = 2,588.61 L.F.


LENGTH OF PROJECT = 11,722.84 LF or 2.220 MILES

ADD FOR WORK
Lorain Rd. (S.R.10)
Sta. 1137+30.00 to Sta. 1153+80.00 = 1,650.00 L.F.

I-480
Sta. 973+35.00 to Sta. 975+50.00 = 215.00 L.F.
Sta. 100+25.34 to Sta. 105+37.00 = 511.66 L.F.
LENGTH OF ADDITIONAL WORK = 2,376.66 L.F.
ADD PROJECT LENGTH = 11,722.84 L.F.

LENGTH OF WORK = 14,099.50 L.F. or 2.670 MILES

SUPPLEMENTAL SPECIFICATIONS	
NUMBER	DATE
801	4-25-77
808	1-1-77
814	1-1-69
836	3-12-76
838	1-13-77
839	11-25-70
844	11-8-74
846	4-25-77
948	2-19-74
950	4-25-77
951	4-25-77
5625	1-11-74
5713	1-11-74
10001	1-3-77

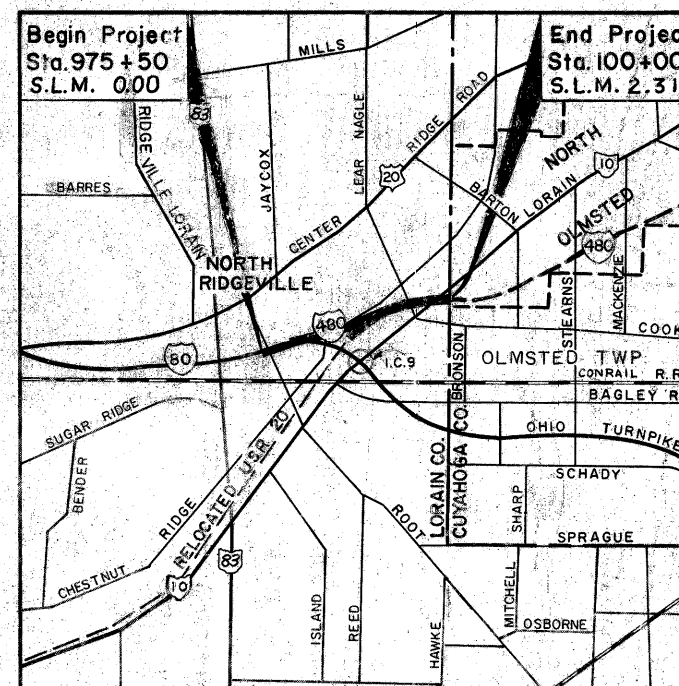


LOCATION MAP

SCALE OF MILES

Portion To Be Improved
State Routes
U.S. Routes
Interstate Routes
City Streets
To Be Improved Under Separate Contract

PLAN
PROFILE: HORIZ.
VERT.
CROSS SECTIONS
PAVEMENT DETAILS

SCALES

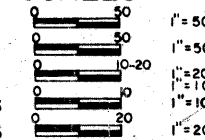

STANDARD DRAWINGS	
Number	Date
BP-1	6-1-69
BP-2	12-6-76
BP-3	12-6-76
BP-4	12-6-76
BP-5	8-11-73
BP-7	12-6-76
BP-9	12-6-76
BP-10	1-3-75
CB-3	1-1-76
CB-3A	1-1-76
CB-5	9-1-69
CB-6	6-1-69
F-1	5-1-76
BP-6	6-1-6
F-3	5-1-76
F-5	5-1-76
F-6	5-1-76
GR-1	12-6-76
GR-2B	12-6-76
GR-3	12-6-76
GR-4	12-6-76
GR-4A	7-26-76
GR-5	1-1-71
GR-6	1-1-71
HW-4	1-1-70
MC-1	6-13-69
MC-3	6-1-73
MC-4	7-26-76
MC-6	6-1-65
MC-7	10-15-76
MC-8	6-12-75
MC-10	5-1-76
MH-1	6-12-75
MH-3	6-12-75
MH-5	6-12-75
L-1	6-1-73
AS-1-72	6-30-71
BR-1-67	10-15-7
RB-1-55	2-2-5
SD-1-69	6-12-6
SP-53	6-30-6
HL-1	9-6-73
HL-2	7-27-73
HL-3	7-27-73
HL-4	1-21-76
HL-5	9-6-73
HL-6	3-22-7
HL-7	1-21-76
HL-8	1-21-76
HL-9	3-22-7
HL-10	1-21-76
HL-11	4-6-73
HL-12	4-6-73
HL-15	1-21-76
HL-16	4-6-73
HL-19	3-22-7

PLANS PREPARED BY
ALDEN E. STILSON & ASSOCIATES
CONSULTING ENGINEERS
75 PUBLIC SQUARE
CLEVELAND OHIO

DESIGN DESIGNATION	
1970 A.D.T. =	18.00
1987 A.D.T. =	40.00
D.H.V. =	2.00
D. (directional distribution)	6
T. (percent B&C trucks)	5
V. (design speed)	60 M.P.H.

DEPARTMENT OF TRANSPORTATION
FEDERAL HIGHWAY ADMINISTRATION

APPROVED:

DIVISION ADMINISTRATOR

DATE: _____

FILE NUMBER	LORAIN COUNTY	LOR- 480-000
	DATE OF LETTING	_____
	CONTRACT NUMBER	_____


SCHEMATIC PLAN

FED. RD. DIVISION	STATE	PROJECT
5	OHIO	

2
375

LORAIN COUNTY
LOR-480-0.00

CITY OF NORTH RIDGEVILLE

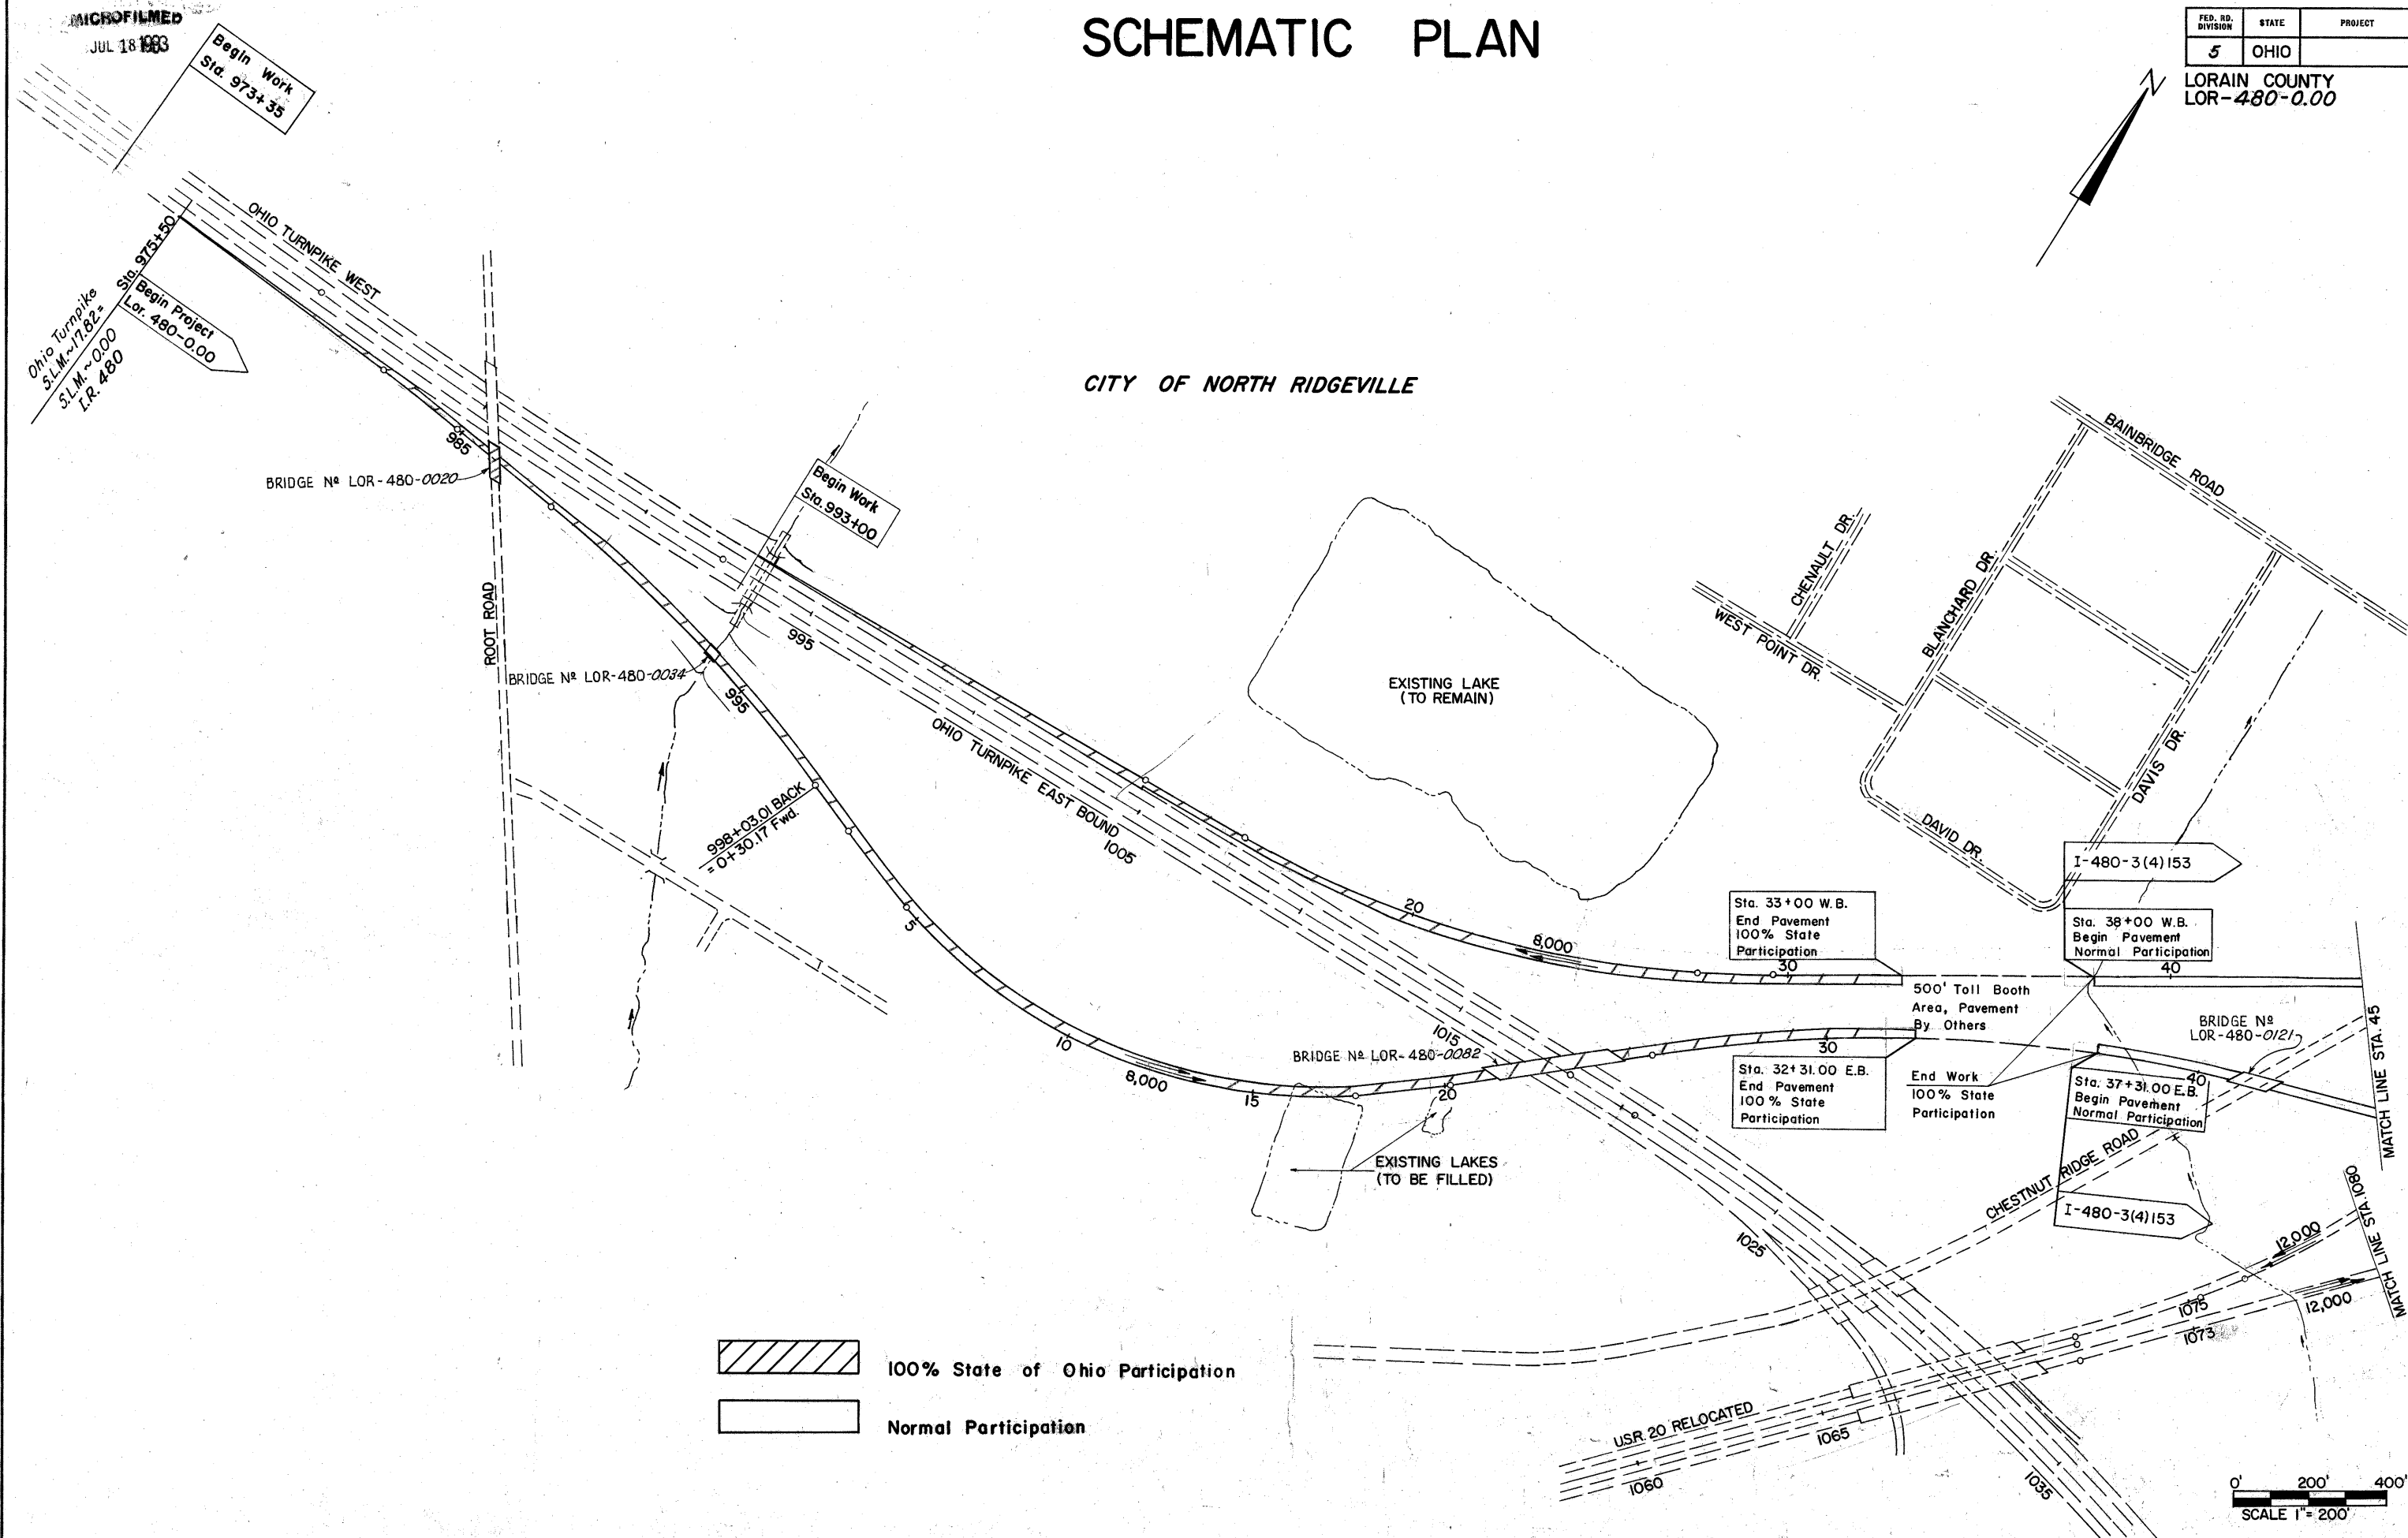


MICROFILMED
JUL 18 1983

SCHEMATIC PLAN

FED. RD. DIVISION	STATE	PROJECT
5	OHIO	

3
375

LORAIN COUNTY
LOR-480-0.00

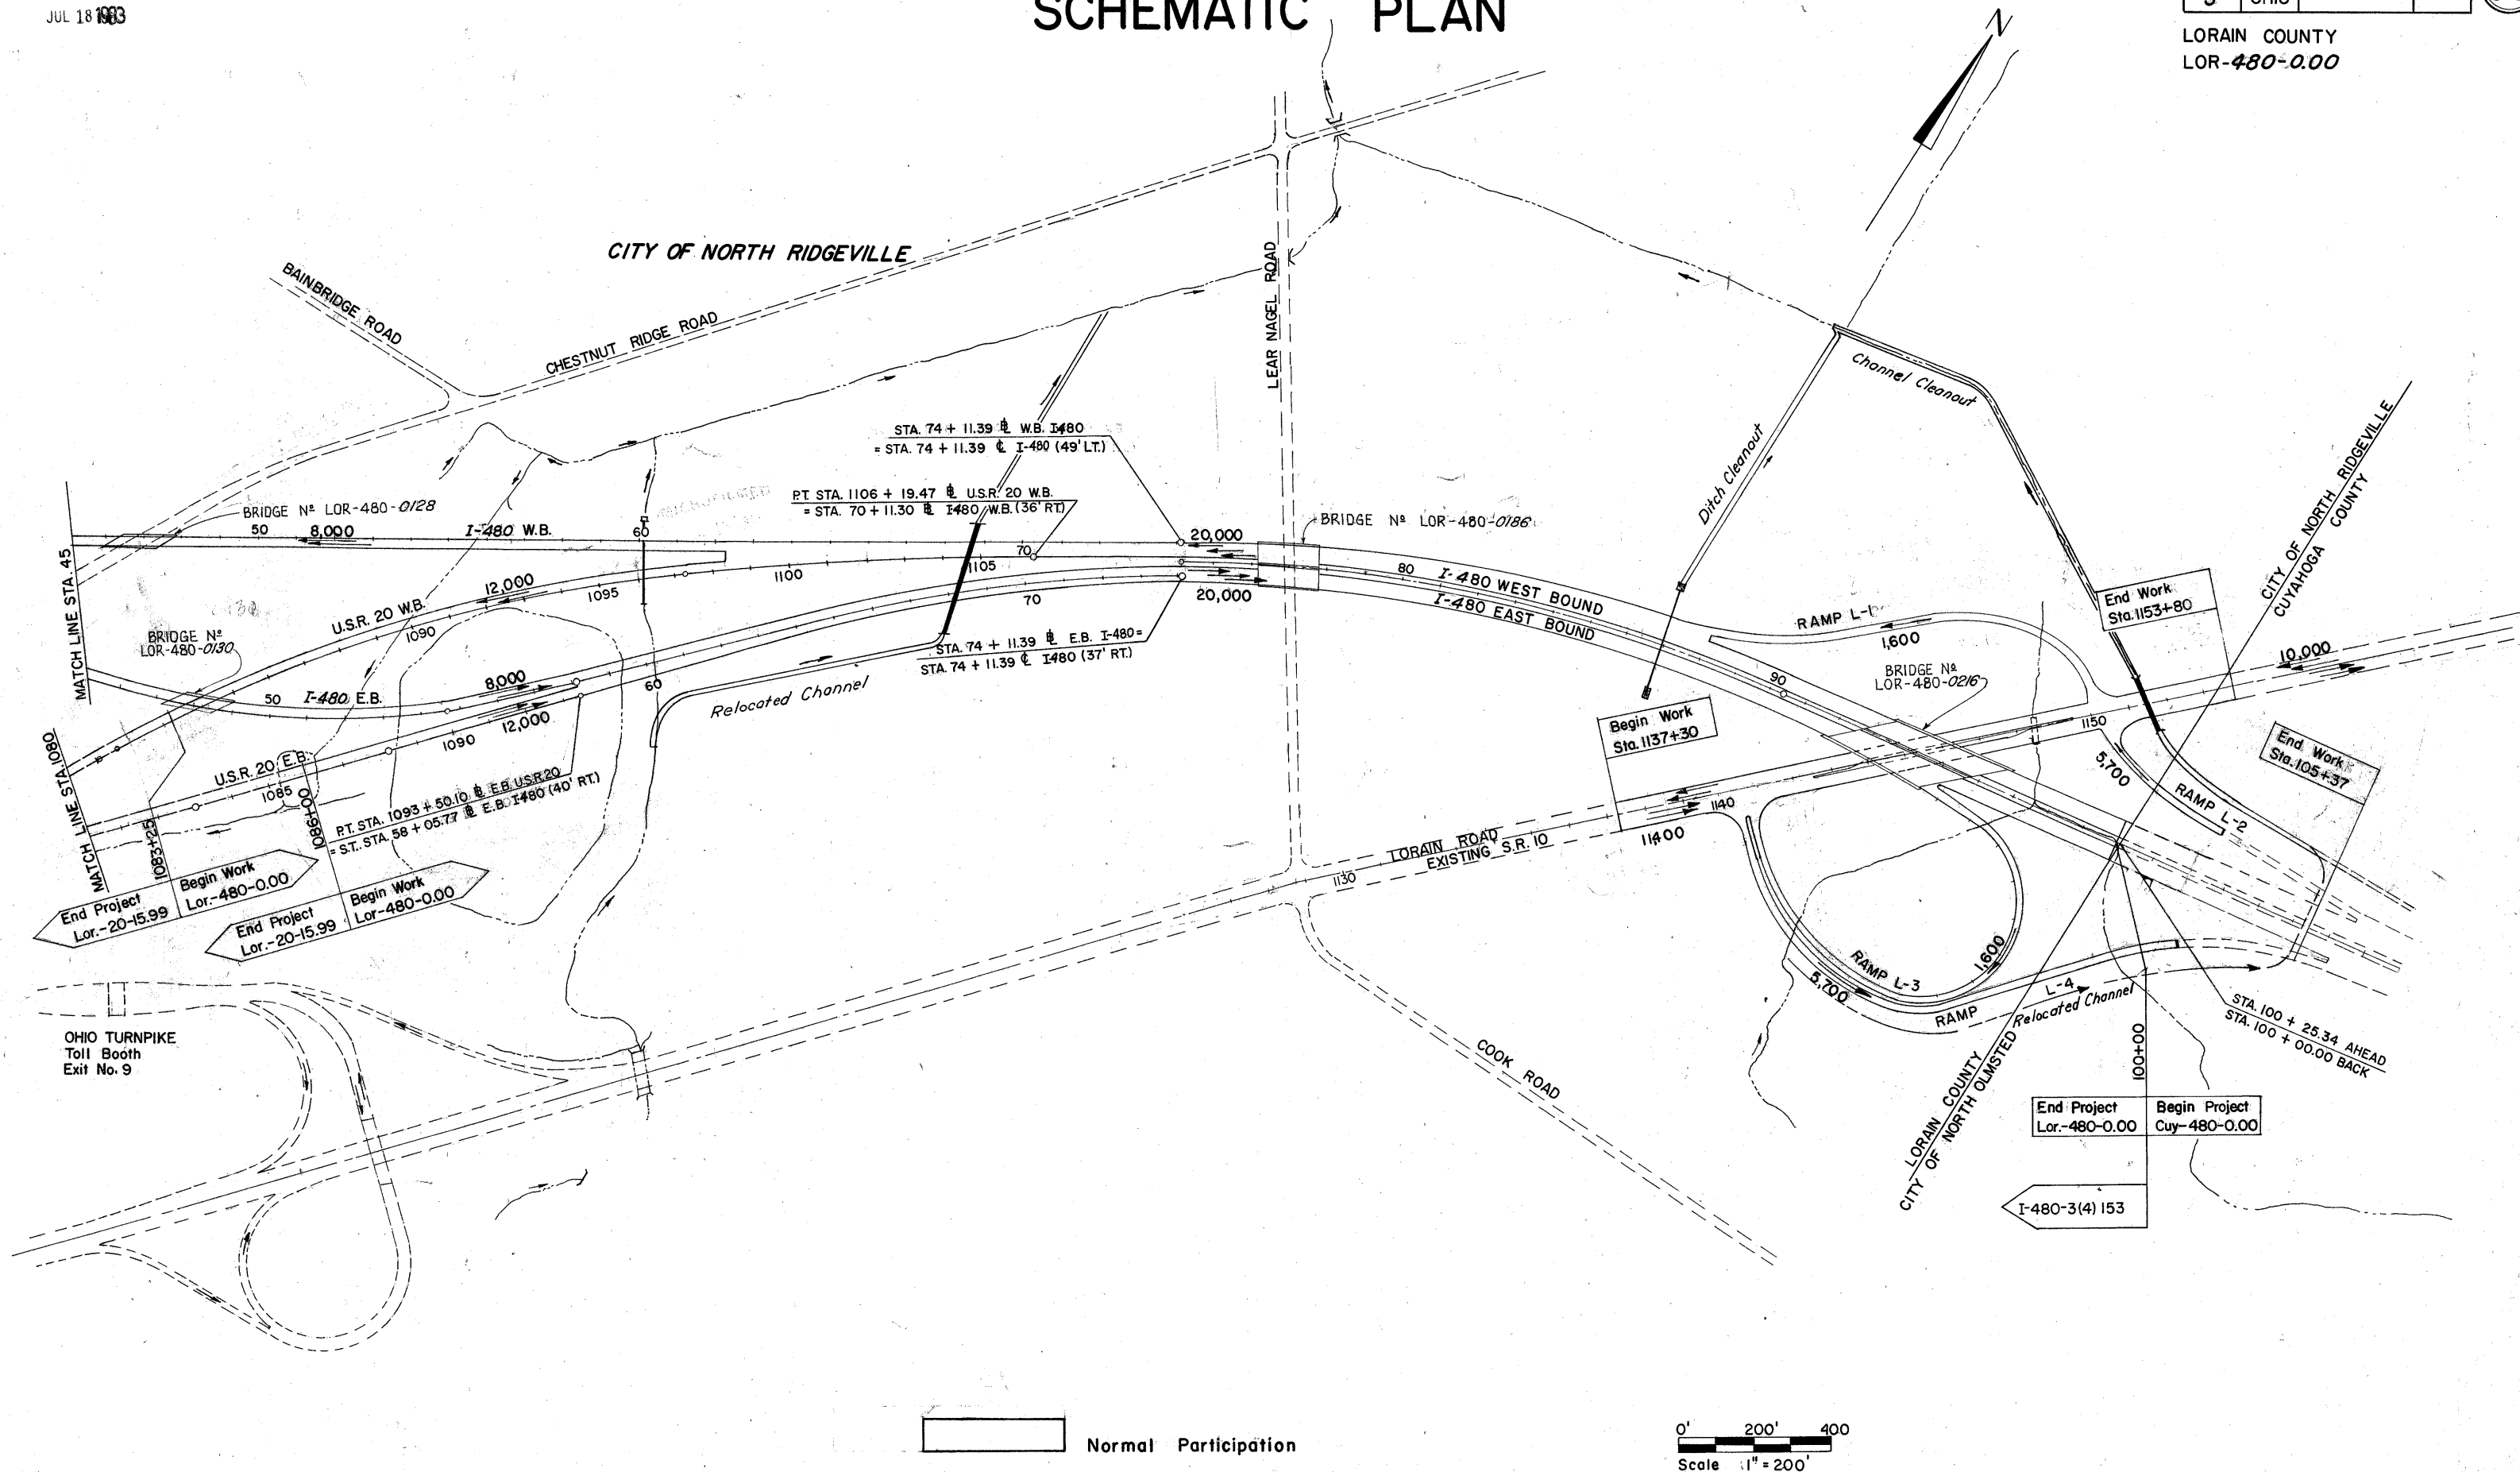


MICROFILMED
JUL 19 1983

FED. RD. DIVISION	STATE	PROJECT	TYPE FUNDS
2	OHIO		

LORAIN COUNTY
LOR-480-0.00

330
375

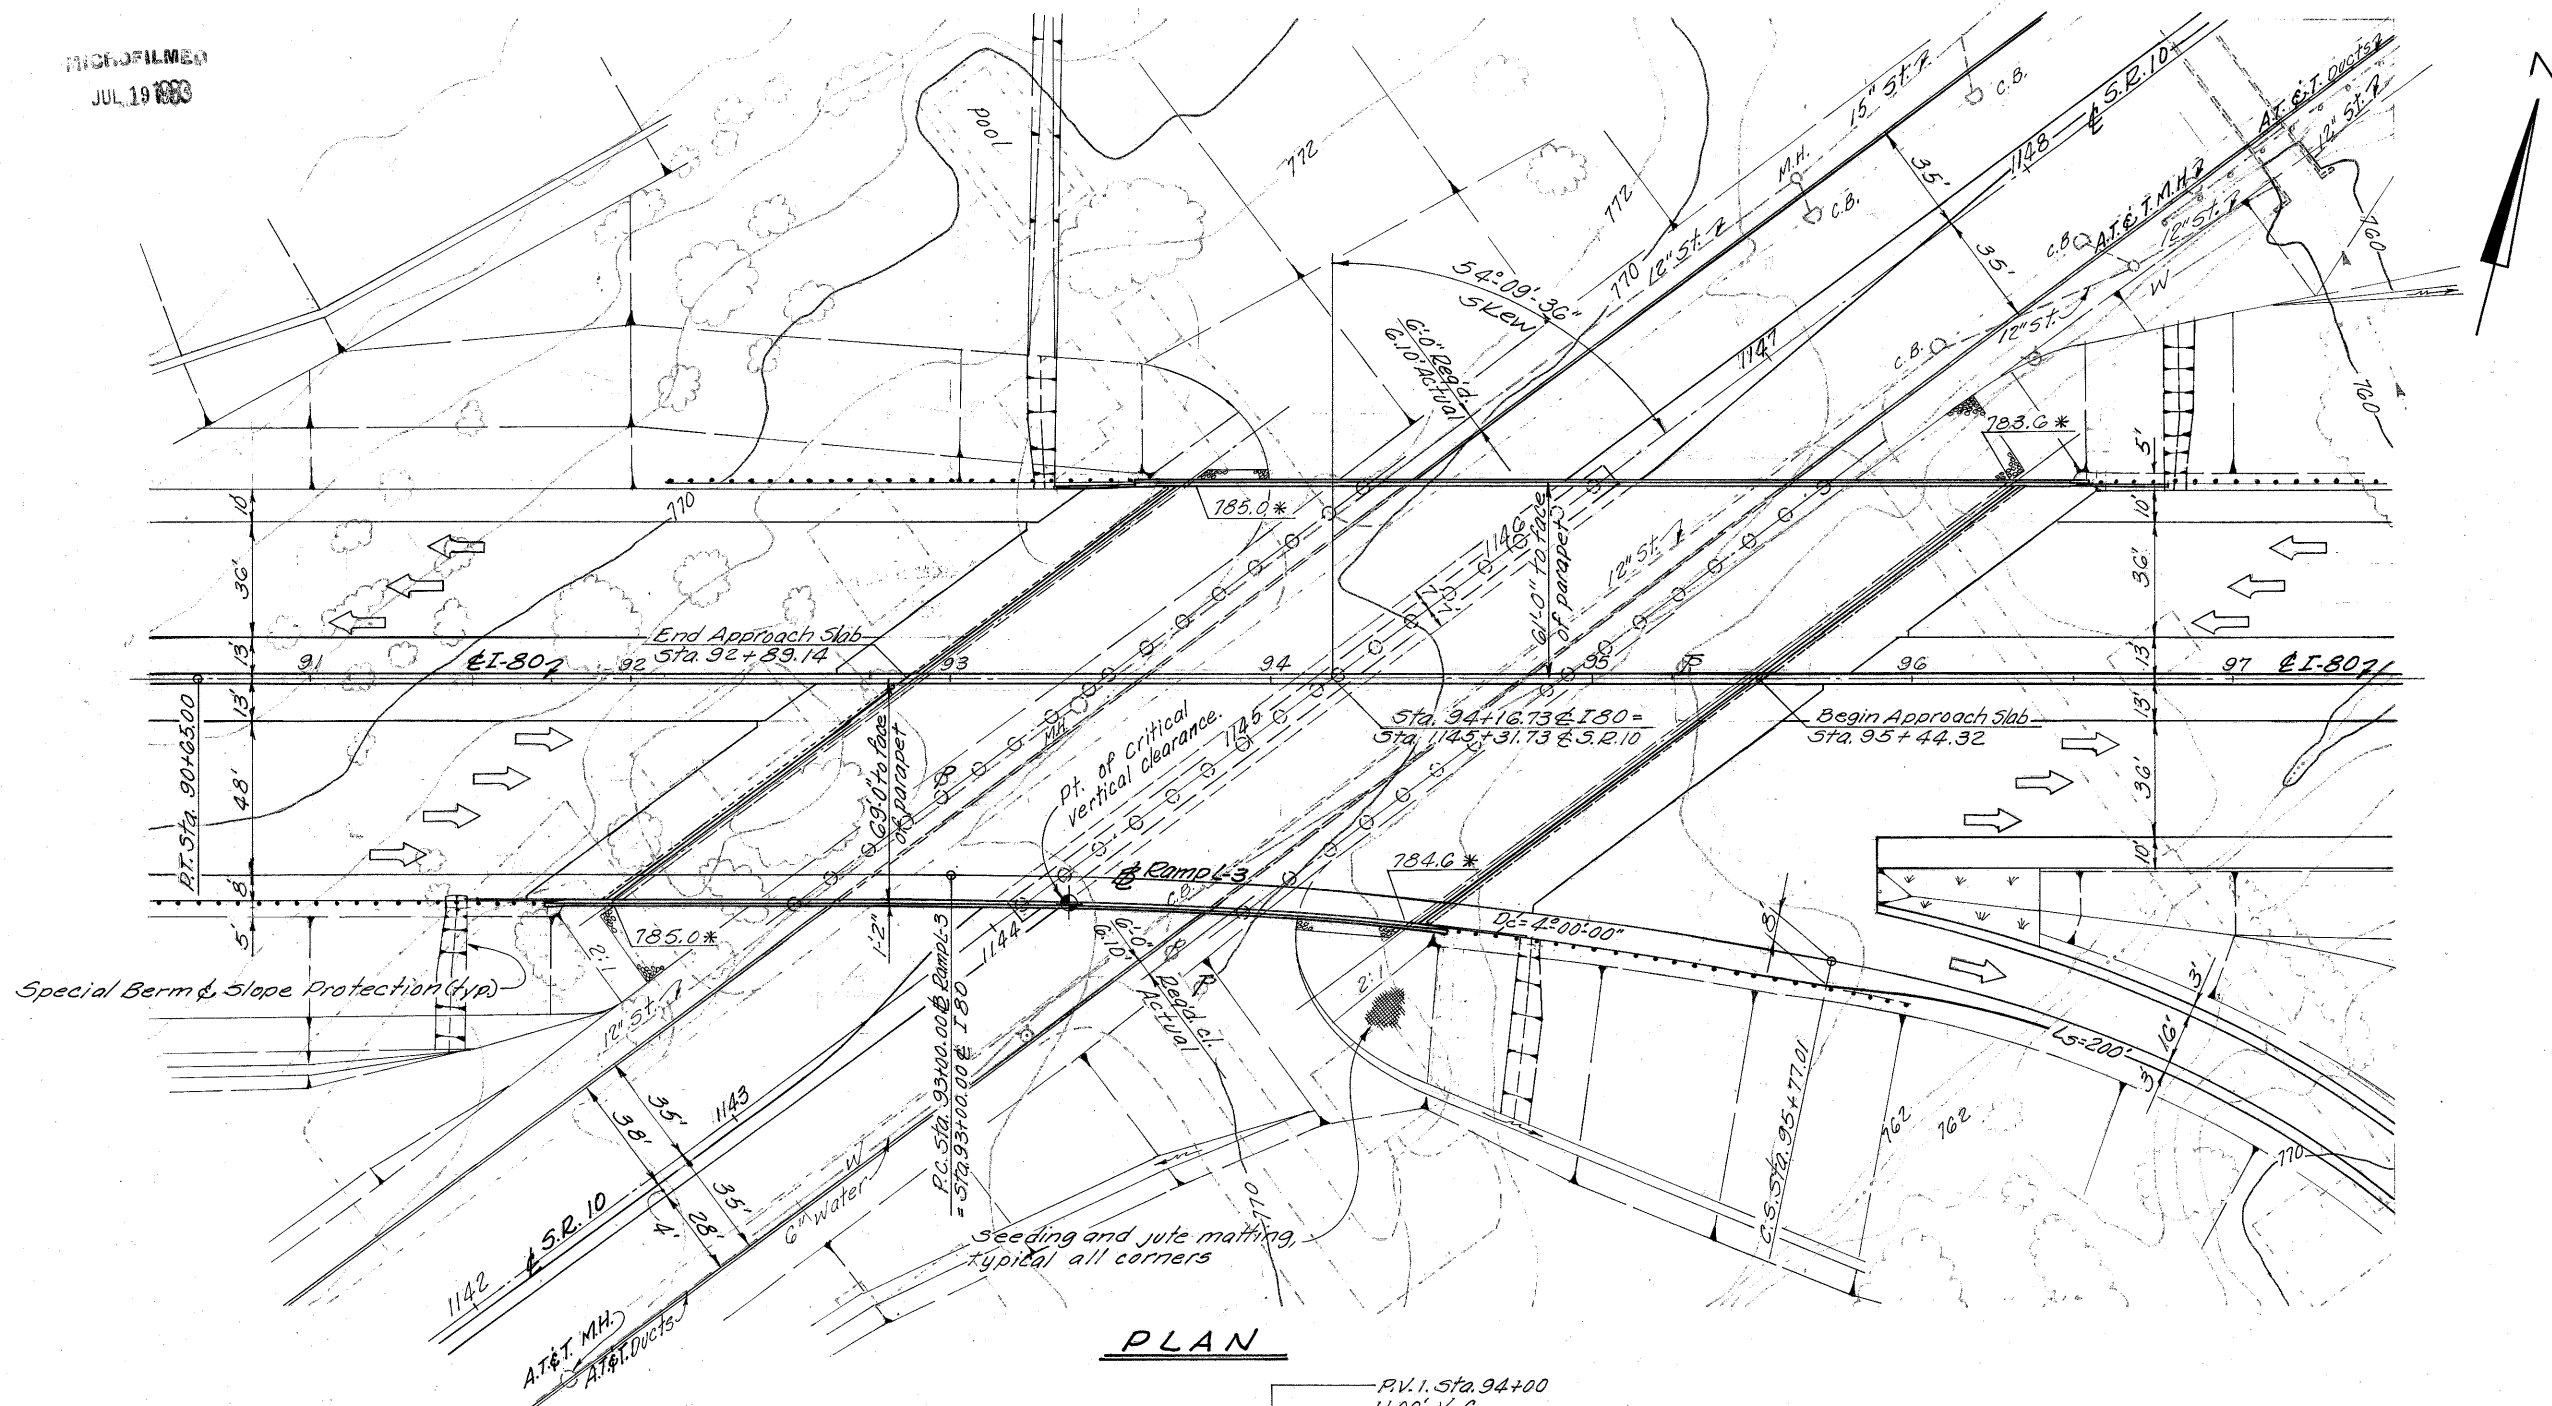

NOTE:
* Elevation indicated thus are top of slope at face of abutment.

Earthwork limits shown are schematic. Actual slopes shall conform to plan cross sections.

The vertical curve data does not apply to bridge or graphic grade elevations. The bridge elevations were obtained by adding 0.12 feet to the elevations obtained from vertical curve data.

BRIDGE NO. LOR-80-1998 APPEARING THROUGH-OUT THIS BRIDGE PLAN SHALL BE CONSIDERED TO READ BRIDGE NO. LOR-480-0216.

PROPOSED STRUCTURE

TYPE: Continuous steel beam with reinforced concrete deck and substructure.

SPANS: 51'-0", 72'-9", 72'-9", 51'-0" 9/16" bearings.

ROADWAY: Variable width (see plan), with Concrete Barrier Type Median & Railing.

LOADING: HS20-44 plus Interstate alternate.

WEARING SURFACE: Monolithic Conc.

SKREW: 54°09'36" Lt. forward.

ALIGNMENT: Tangent

APPROACH SLABS: AS-1-72(30'lg.) modified.

SUPERELEVATION: None

TRAFFIC ESTIMATE

Design Year - 1987
Total A.D.T. - 40,000

ALDEN E. STILSON & ASSOCIATES, LIMITED
CONSULTING ENGINEERS
CLEVELAND, OHIO COLUMBUS, OHIO WHEELING, W. VA.

SITE PLAN

BRIDGE NO. LOR-80-1998


1-80 OVER SR. NO. 10 (LORAIN ROAD)

LORAIN COUNTY STA. 92+89.14

STA. 95+44.32

SCALE 1"=30'-0"

DESIGNED	DRAWN	TRACED	CHECKED	REVIEWED	DATE	REVIS
G.W.M.	G.W.M.	R.T.	B.I.P.	G.W.M.	9/10	

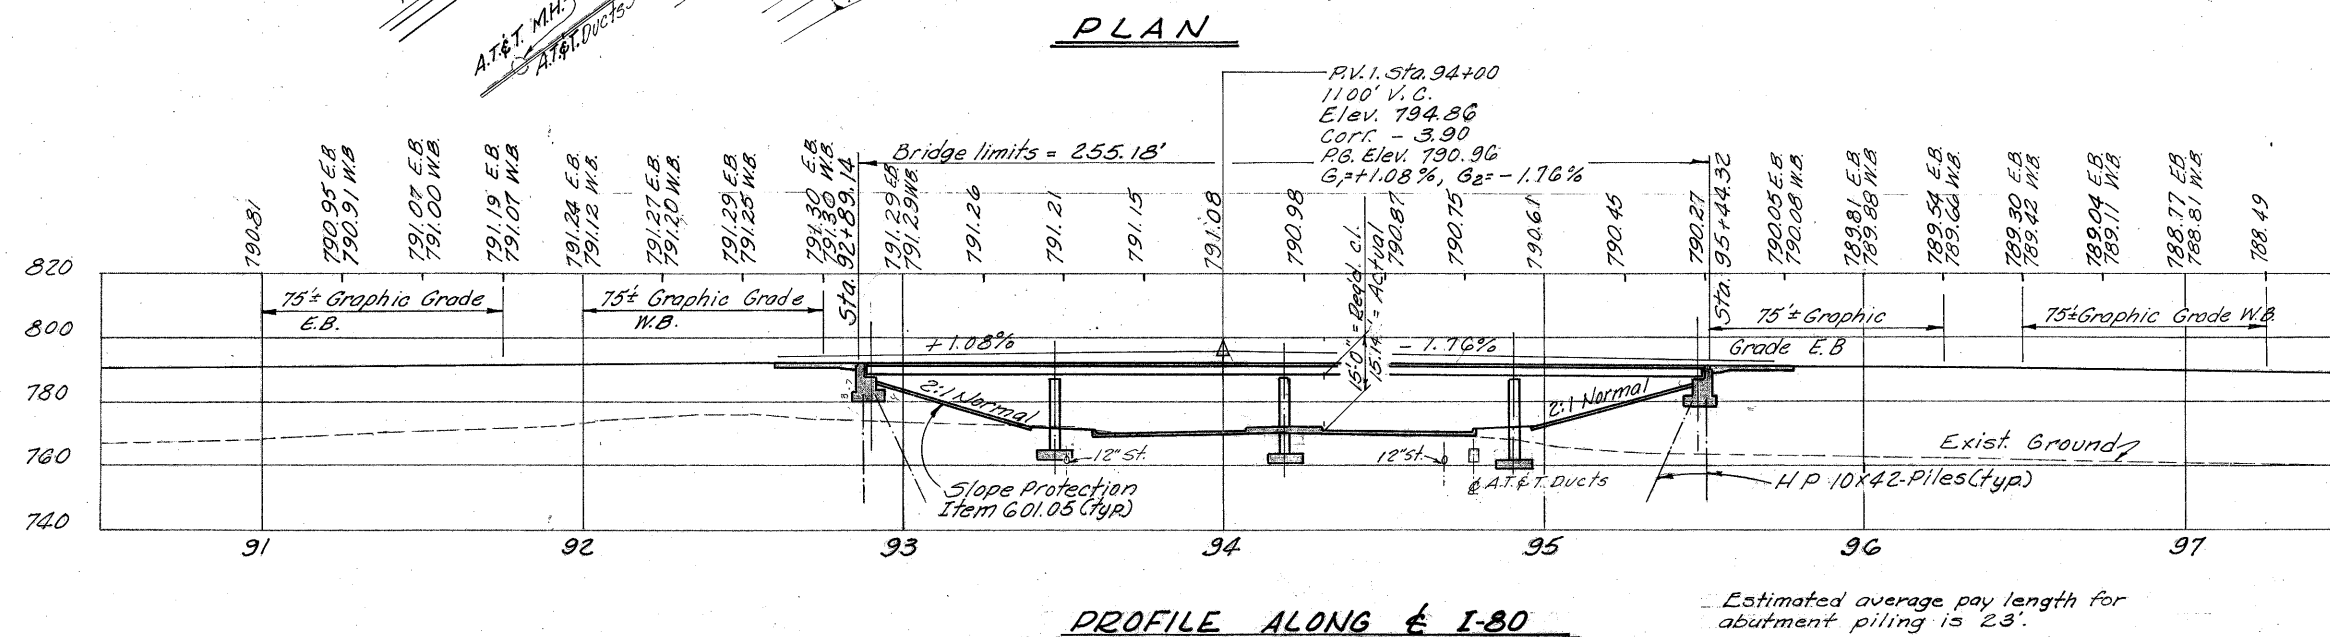

Estimated average pay length for abutment piling is 23'.

STANDARD DRAWING REFERENCES

DESCRIPTION	DWG. NO.	SHT.	DATE
END DAM AND END CROSSFRAME	SD-1-69	1-2	6-12-69
CURB PLATES	SD-1-69	2	6-12-69
SCUPPERS	SD-1-69	3	6-12-69
MOMENT PLATES	SD-1-69	3	6-12-69
BOLTED SPLICES	SD-1-69	4	6-12-69
BRIDGE ROADWAY RAILING	BR-1-67	1	10-15-71 R
ROCKERS AND BOLSTERS	RB-1-55		2- 2-59 R
APPROACH SLABS	AS-1-72		6-30-72
STRUCTURE GROUNDING	HL-7		1-26-72

(R INDICATES REVISED DATE)

SUPPLEMENTAL SPECIFICATION REFERENCES

DESCRIPTION	NO.	DATE
CHEMICAL ADMIXTURE FOR CONCRETE, TYPE A, B OR D	808	1- 1-71
CONCRETE CURING AND PROTECTIVE MEMBRANE	836	3-12-75

COMMON DETAIL REFERENCES

CONTRACTION JOINTS & END DAMS	SHEET 354
EXPANSION JOINTS	SHEET 354
DECK DRAINAGE DETAILS	SHEET 355

DESIGN SPECIFICATIONS

THIS STRUCTURE CONFORMS TO THE 'STANDARD SPECIFICATIONS FOR HIGHWAY BRIDGES' ADOPTED BY THE AMERICAN ASSOCIATION OF STATE HIGHWAY OFFICIALS, 1969, INCLUDING THE OHIO 'SUPPLEMENT' TO THESE SPECIFICATIONS.

DESIGN DATA

DESIGN LOADING - HS20-44 AND THE INTERSTATE ALTERNATE LOADING
CONCRETE CLASS C - UNIT STRESS 1200 PSI FOR SUPERSTRUCTURE
UNIT STRESS 1333 PSI FOR SUBSTRUCTURE
STRUCTURAL STEEL - ASTM A36 - UNIT STRESS 20000 PSI
REINFORCING STEEL - ASTM A615, A616 OR A617 - UNIT STRESS 20000 PSI.
SPIRAL REINFORCEMENT MAY BE PLAIN BARS ASTM A82, OR A615.

EMBANKMENT CONSTRUCTION

THE EMBANKMENTS SHALL BE CONSTRUCTED TO THE LEVEL OF THE SUBGRADE FOR A MINIMUM DISTANCE OF 200 FEET BACK OF THE ABUTMENTS. EXCAVATION SHALL THEN BE MADE FOR THE ABUTMENTS AND FOR PIER NO.3

PILES

PILES SHALL BE DRIVEN TO A MINIMUM BEARING CAPACITY OF-
35 TONS PER PILE FOR THE ABUTMENTS

FOUNDATION BEARING PRESSURE

PIER FOOTINGS ARE DESIGNED FOR A MAXIMUM BEARING PRESSURE OF 2.5 TONS PER SQ. FT.

LAPS

MINIMUM BAR LAPS SHALL BE 30 DIAMETERS.

UTILITY LINES

ALL EXPENSE INVOLVED IN RELOCATING THE AFFECTED UTILITY LINES SHALL BE BORNE BY THE OWNERS. THE CONTRACTOR AND OWNERS ARE REQUESTED TO COOPERATE BY ARRANGING THEIR WORK IN SUCH A MANNER THAT INCONVENIENCE TO EITHER WOULD BE HELD TO A MINIMUM.

MAINTENANCE OF TRAFFIC

TWO LANES OF TRAFFIC WITH A MINIMUM HORIZONTAL WIDTH OF 26'-0 AND A MINIMUM VERTICAL CLEARANCE OF 13'-6 SHALL BE MAINTAINED ON S.R. 10 AT ALL TIMES.

SUPPLEMENTAL SPECIFICATION REFERENCES-CONT

DESCRIPTION	NO.	DATE
PAINTING FOR NEW STRUCTURAL STEEL	846	4-25-77
INORGANIC ZINC SILICATE PAINT	950	4-25-77
BLUE-GREEN VINYL PAINT	951	4-25-77

ITEM	TOTAL	UNIT	DESCRIPTION	ABUTS	PIERS	SUPER	GENERAL			
503	LUMP	SUM	COFFERDAMS, CRIBS AND SHEETING				LUMP			
503	3180	C.Y.	UNCLASSIFIED EXCAVATION	1055	2125					
505	LUMP	SUM	TEST PILE				LUMP			
507	2185	L.F.	STEEL PILES, HP10X42	2185						
509	305311	LB	REINFORCING STEEL	57,132	113591	134,588				
511	1066	C.Y.	CLASS C CONCRETE, SUPERSTRUCTURE(SEE PROPOSAL NOTE)			1066				
511	300	C.Y.	CLASS C CONCRETE, PIERS ABOVE FOOTINGS		300					
511	466	C.Y.	CLASS C CONCRETE, ABUTMENTS ABOVE FOOTINGS	466						
511	758	C.Y.	CLASS C CONCRETE, FOOTINGS	348	410					
512	100	L.F.	PREMOLDED SEALING STRIP	100						
513	836000	LB	STRUCTURAL STEEL,PRIMER PER 846(SEE PROPOSAL NOTE)			836000				
846	836000	LB	FIELD PAINTING OF STRUCTURAL STEEL			836000				
516	110	S.F.	1 INCH PREFORMED EXPANSION JOINT FILLER	110						
518	262	C.Y.	POROUS BACKFILL	262						
518	12	EA	STANDARD SCUPPERS INCLUDING SUPPORTS			12				
518	12	EA	TYPE 3 SCUPPERS INCLUDING SUPPORTS, AS PER PLAN			12				
518	436	L.F.	6 INCH PERFORATED, HELICAL CSP, 707.01	436						
518	112	L.F.	6 INCH NON-PERFORATED, HELICAL CSP, INCLUDING SPECIALS, 707.01	112						
601	1720	S.Y.	CRUSHED AGGREGATE SLOPE PROTECTION				1720			
5625			SEE SHEET222 FOR LIGHTING SUMMARY							
808	1066	UNIT	CHEMICAL ADMIXTURE FOR CONCRETE, TYPE A, B OR D			1066				
SPEC	138582	LB	EPOXY COATED REINFORCING STEEL(SEE PROPOSAL NOTE)	2074		136508				



MONOLITHIC WEARING SURFACE THICKNESS IS ASSUMED TO BE 1" DECK PROJECTION METHOD: EPOXY COATED REINFORCING STEEL, TOP MAT ONLY.

*Std. Dwg. AS-1-72 shall be modified to provide 3" clearance to the top re-bars instead of the 2" shown and jacking holes shall be omitted.

ATTACHMENT OF GUARDRAIL TO CONCRETE PARAPETS: CONCRETE INSERT ANCHOR ASSEMBLIES PER STANDARD CONSTRUCTION DRAWINGS GR-3 AND GR-1 SHALL BE PLACED DURING PARAPET CONSTRUCTION.

EBL

ALDEN E. STILSON & ASSOCIATES, LIMITED CONSULTING ENGINEERS CLEVELAND, OHIO COLUMBUS, OHIO WHEELING, W. VA.						
GENERAL NOTES AND ESTIMATED QUANTITIES BRIDGE NO LOR-80-1998 I-80 OVER S.R. 10 (LORAIN ROAD) LORAIN COUNTY STA. 92 + 89.14 STA. 95 + 44.32						
DESIGNED	DRAWN	TRACED	CHECKED	REVIEWED	DATE	REVISED
ASS.			B.D. 4-17-70	G.W.M. 5/26/70		

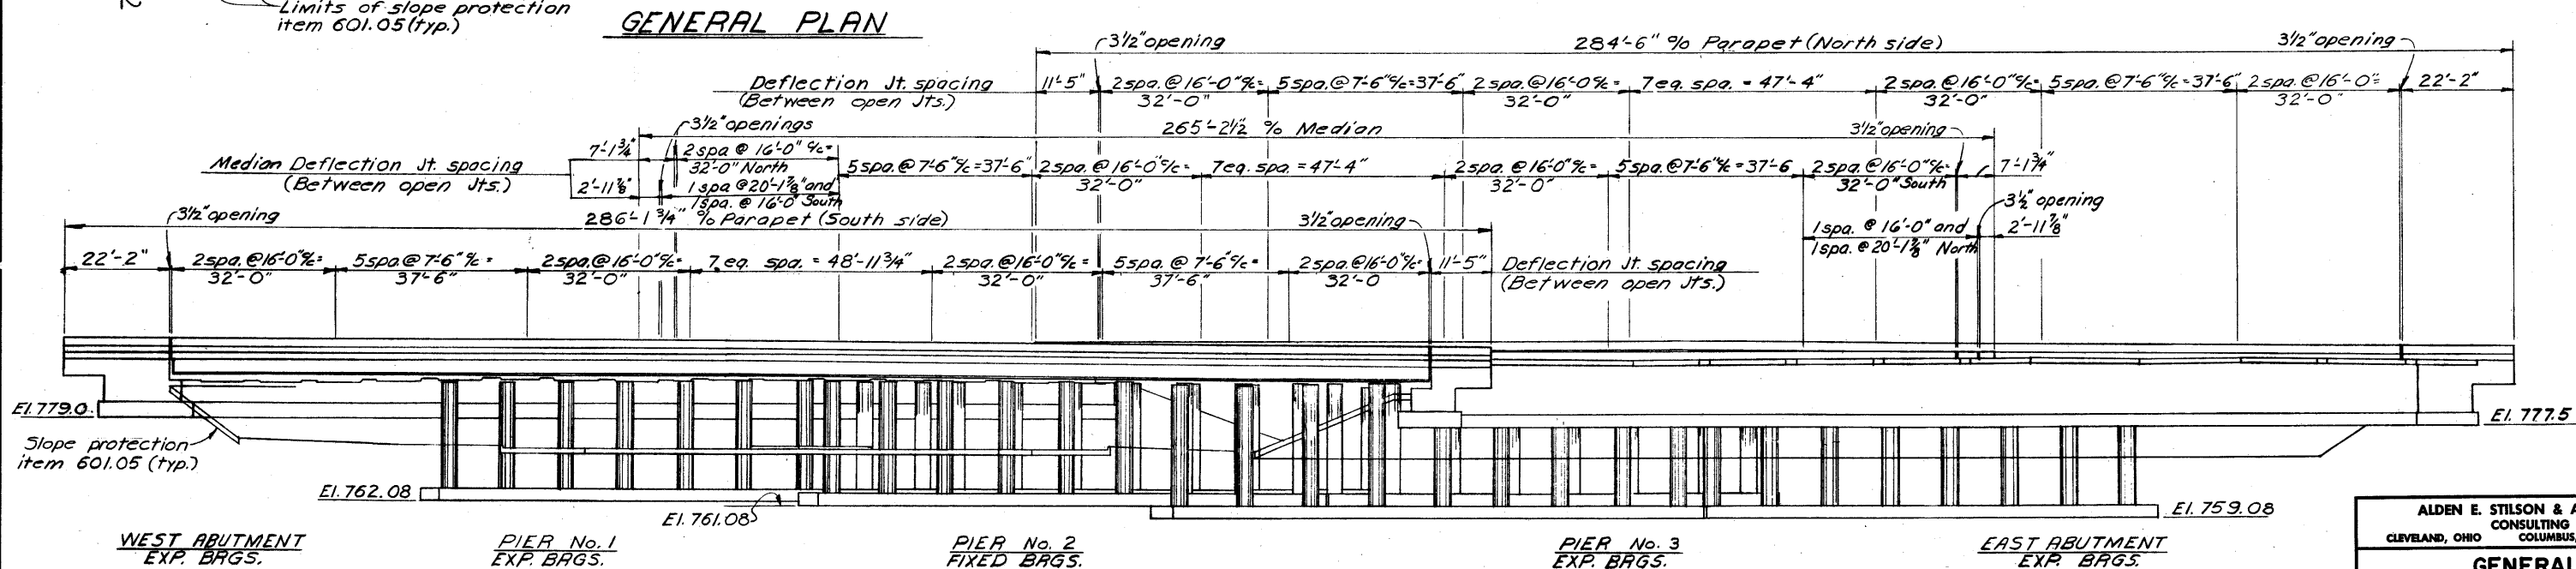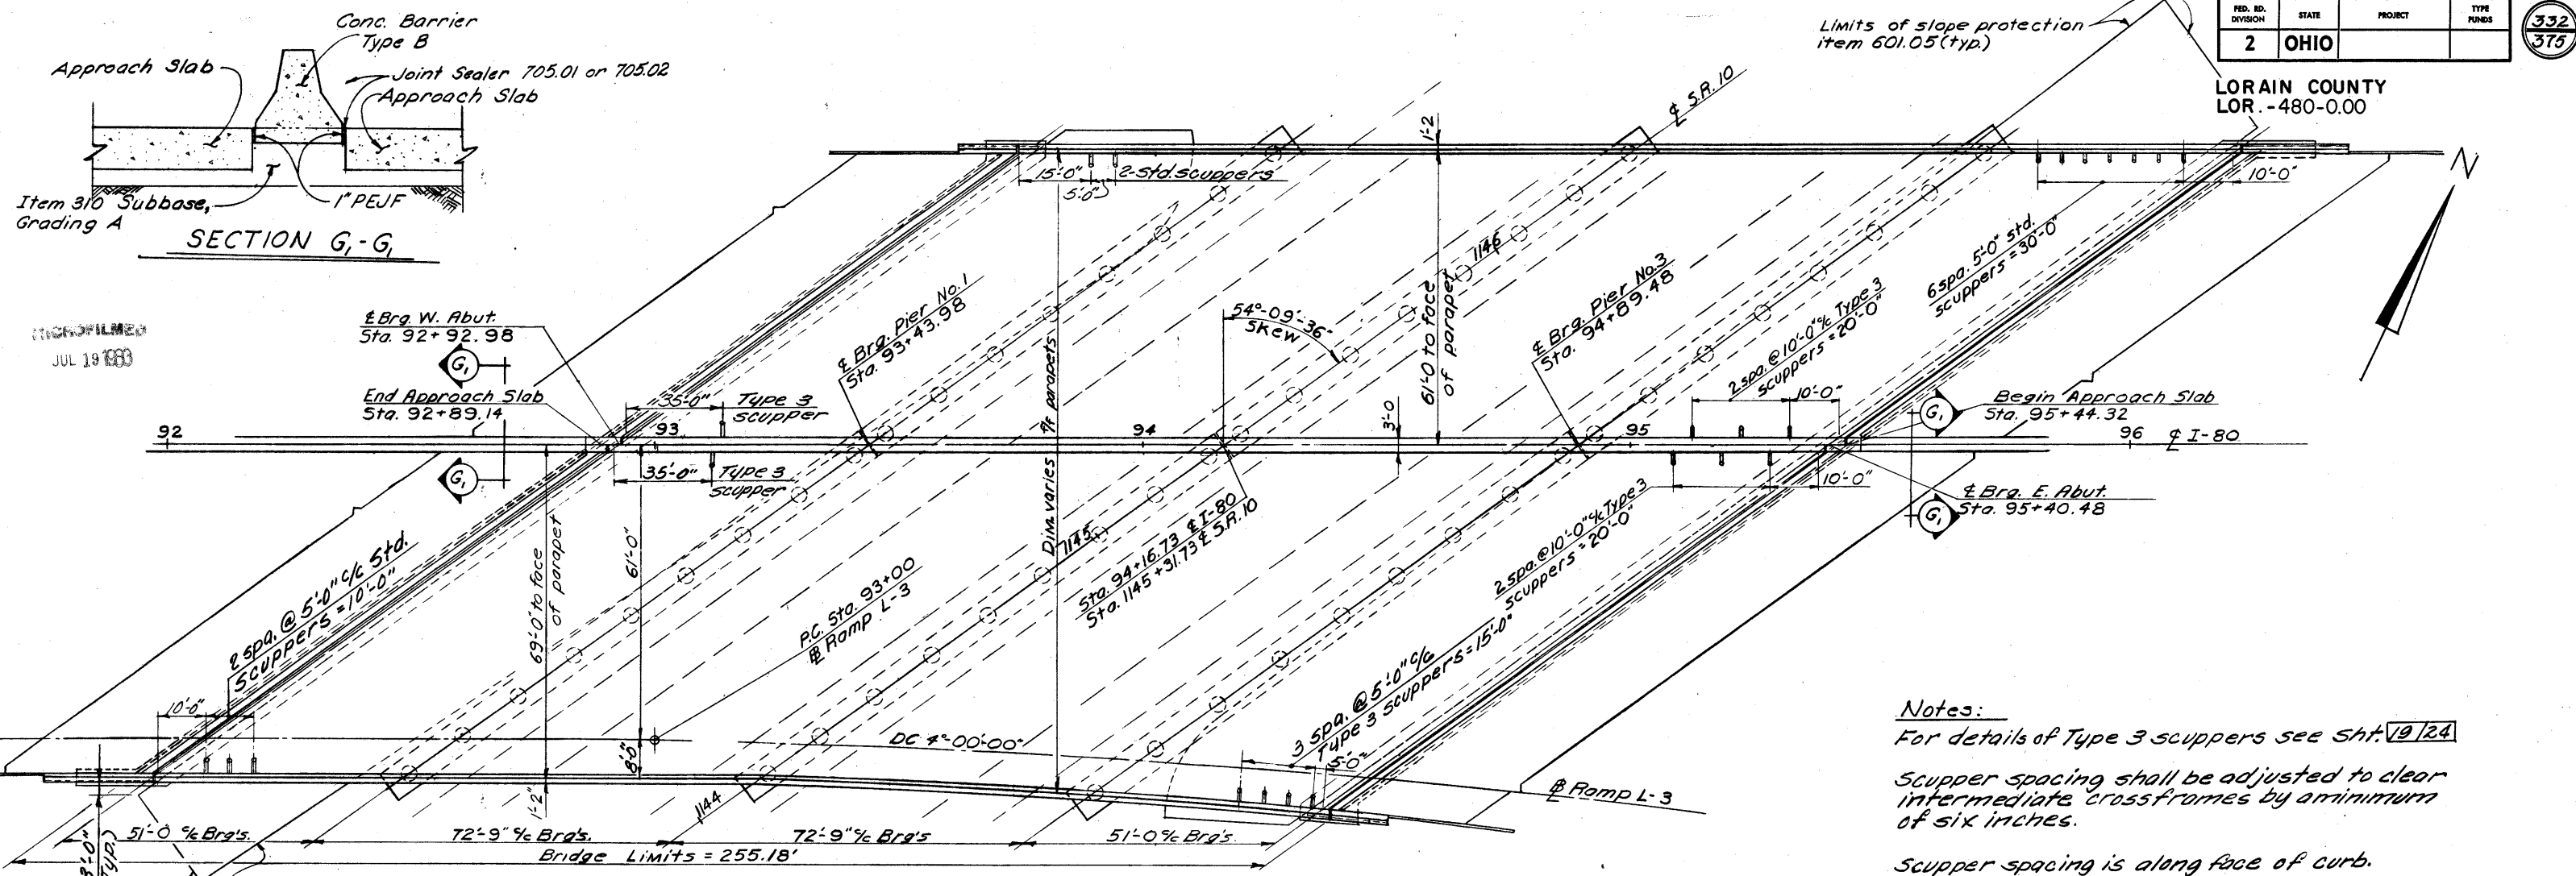

FED. RD. DIVISION	STATE	PROJECT	TYPE FUNDS
2	OHIO		

LORAIN COUNTY
LOR.-480-0.00


ALDEN E. STILSON & ASSOCIATES, LIMITED CONSULTING ENGINEERS CLEVELAND, OHIO COLUMBUS, OHIO WHEELING, W. VA.							
GENERAL PLAN BRIDGE NO LOR-80-1998 I-80 OVER S.R. 10 (LORAIN ROAD)							
STA. 92+89.14				STA. 95+44.32			
LORAIN COUNTY							
DESIGNED	DRAWN	TRACED	CHECKED	REVIEWED	DATE	REVISED	
R.S.S.	D.L.		B.I.P.	G.W.M.	7/24/70		

DESIGNED
JUL 19 1998

FED. RD. DIVISION	STATE	PROJECT	TYPE FUNDS
2	OHIO		

LORAIN COUNTY
LOR. - 480-0.00

333
375

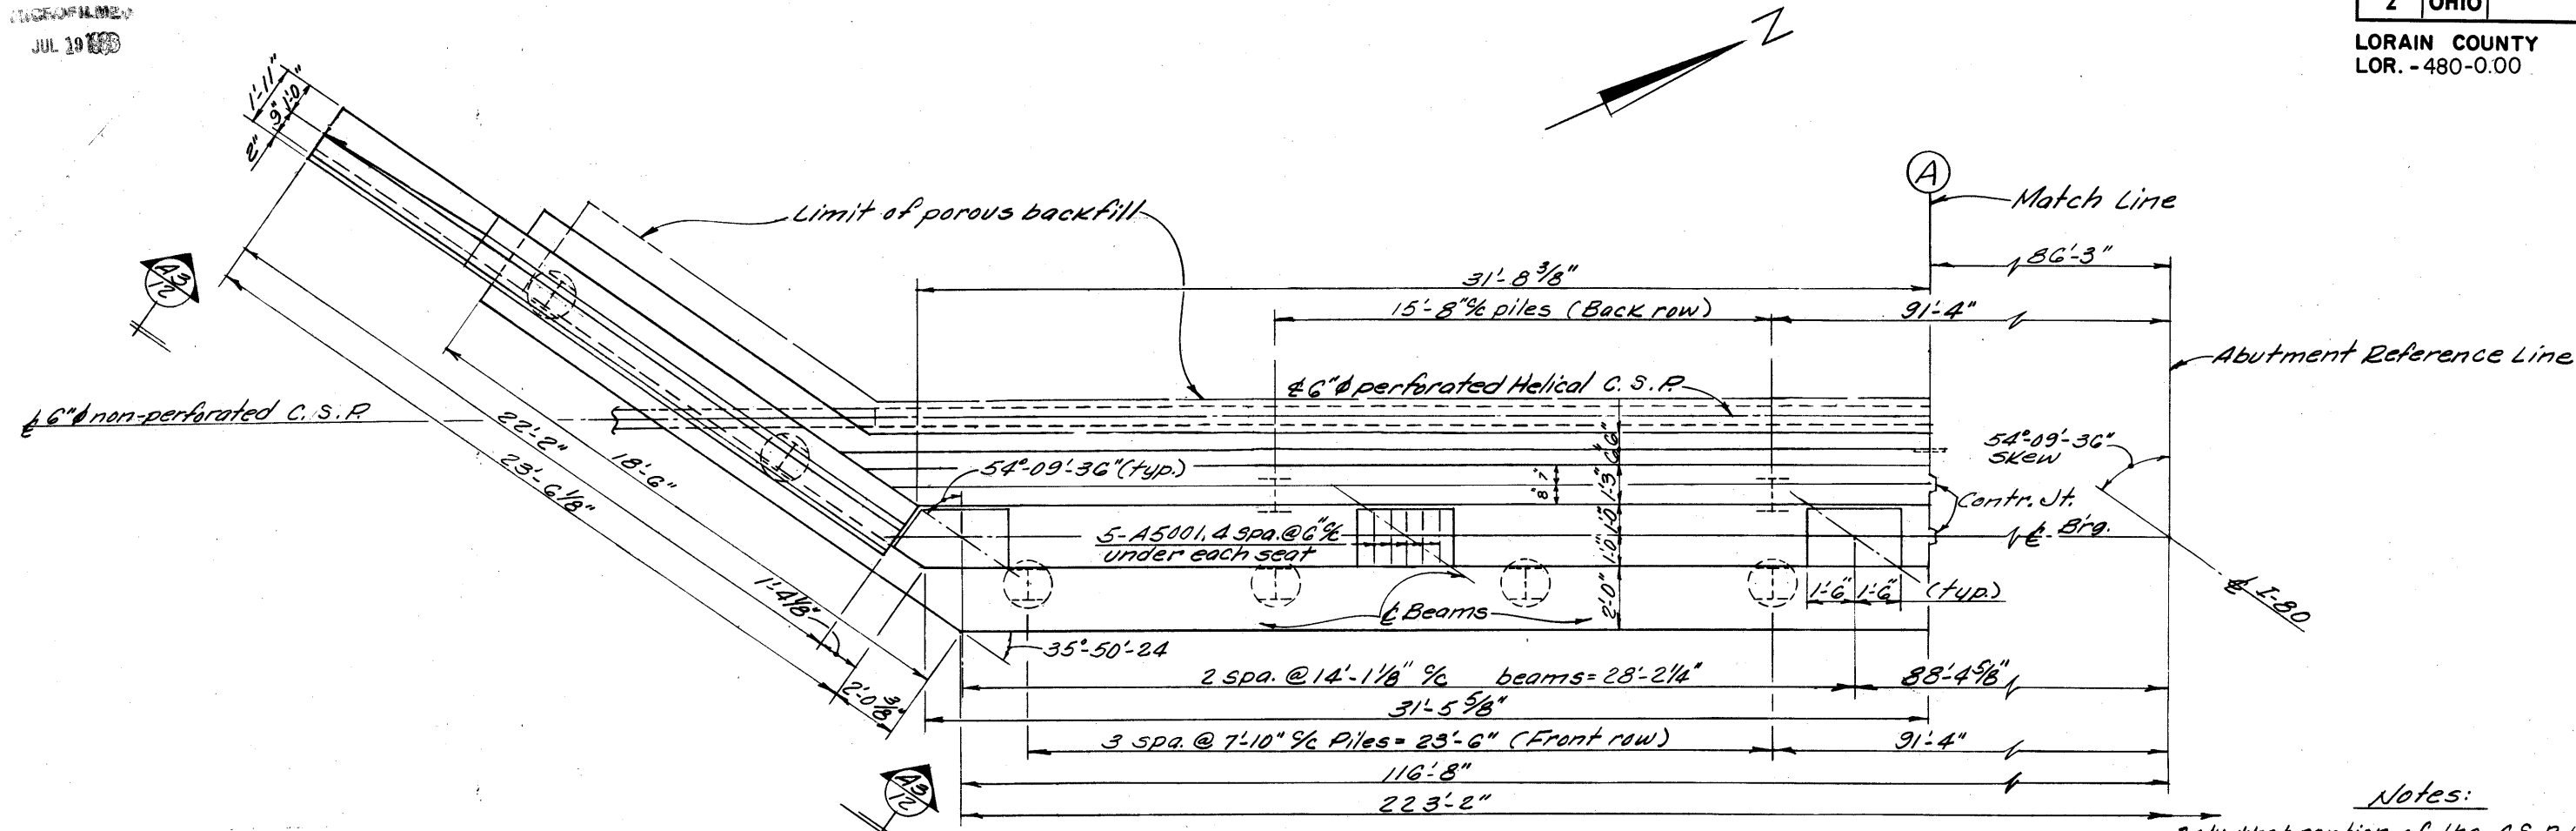

PLAN

Notes:

Only that portion of the C.S.P. located in porous backfill shall be perforated. The 6" C.S.P. porous backfill drain shall be extended out into the side slopes & terminated near the surface as shown by detail on Sht.

All piles are H.P. 10x42. Piles indicates vertical piles. indicates piles battered 1:4.


In reinforcing bar callouts N.S. indicates near side. F.S. indicates far side.

* Elevations shown thus are pavement elevations at the face of backwall and the point indicated.

Porous Backfill 1'-6" thick, full length of abutment and 2'-0" thick, full length of wings as shown, shall extend up to the subgrade or underside of approach slab.

For details of contraction joint and expansion joint see Common Details Sht.


BACKWALL CONCRETE: No backwall concrete shall be placed above the level of the optional construction joint at the approach slab seat until after the deck concrete in the span adjacent to the abutment has been placed.

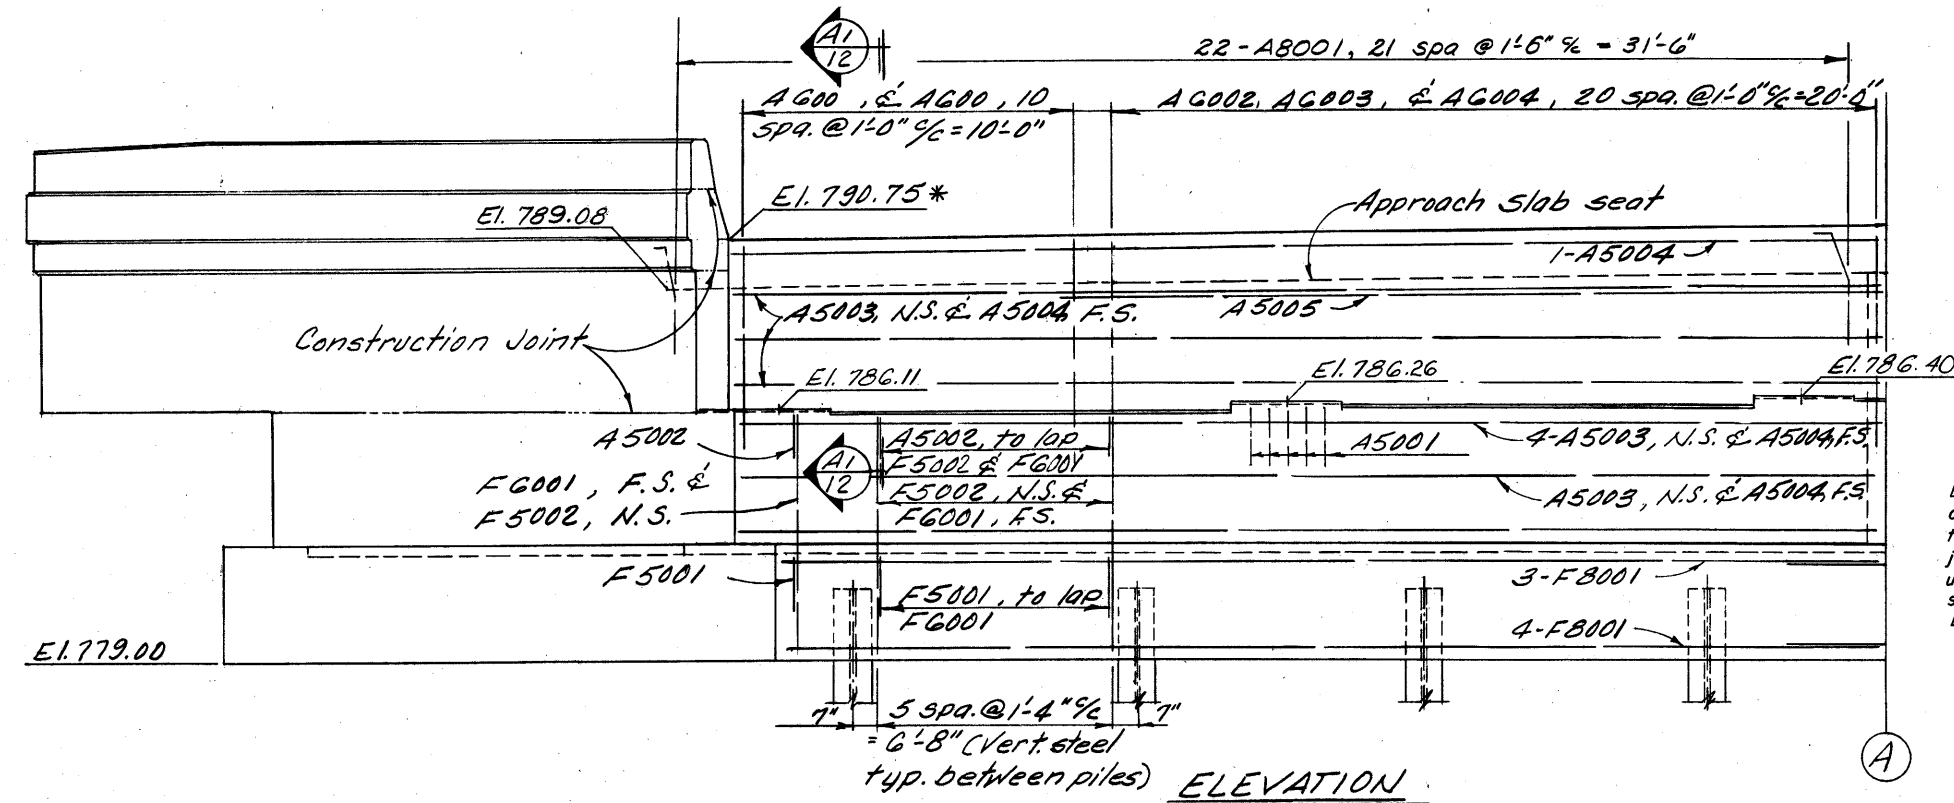


ELEVATION

ALDEN E. STILSON & ASSOCIATES, LIMITED			
CLEVELAND, OHIO	CONSULTING ENGINEERS	COLUMBUS, OHIO	WHEELING, W. VA.
WEST ABUTMENT DETAILS			
BRIDGE NO. LOR-80-1998			
I-80 OVER S.R. 10 (LORAIN ROAD)			
LORAIN COUNTY		STA. 92+89.14	
		STA. 95+44.32	
DESIGNED	DRAWN	TRACED	CHECKED
R.S.S.	R.T.		B.I.P.
			G.W.M. 7/24/98


LORAIN COUNTY
LOR. - 480.0.00

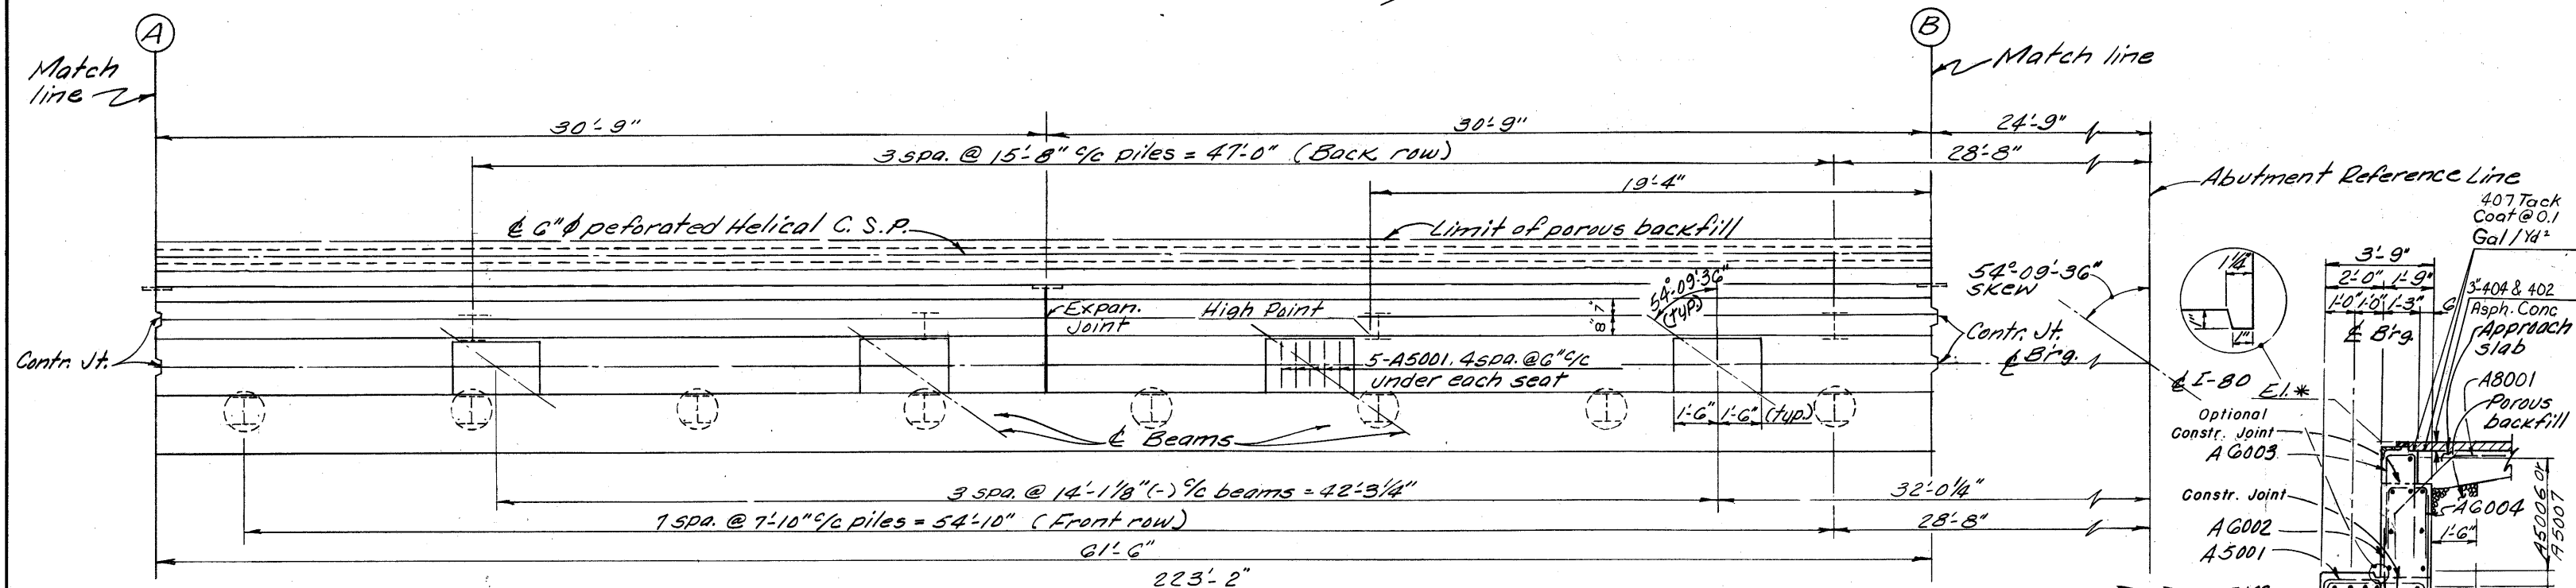

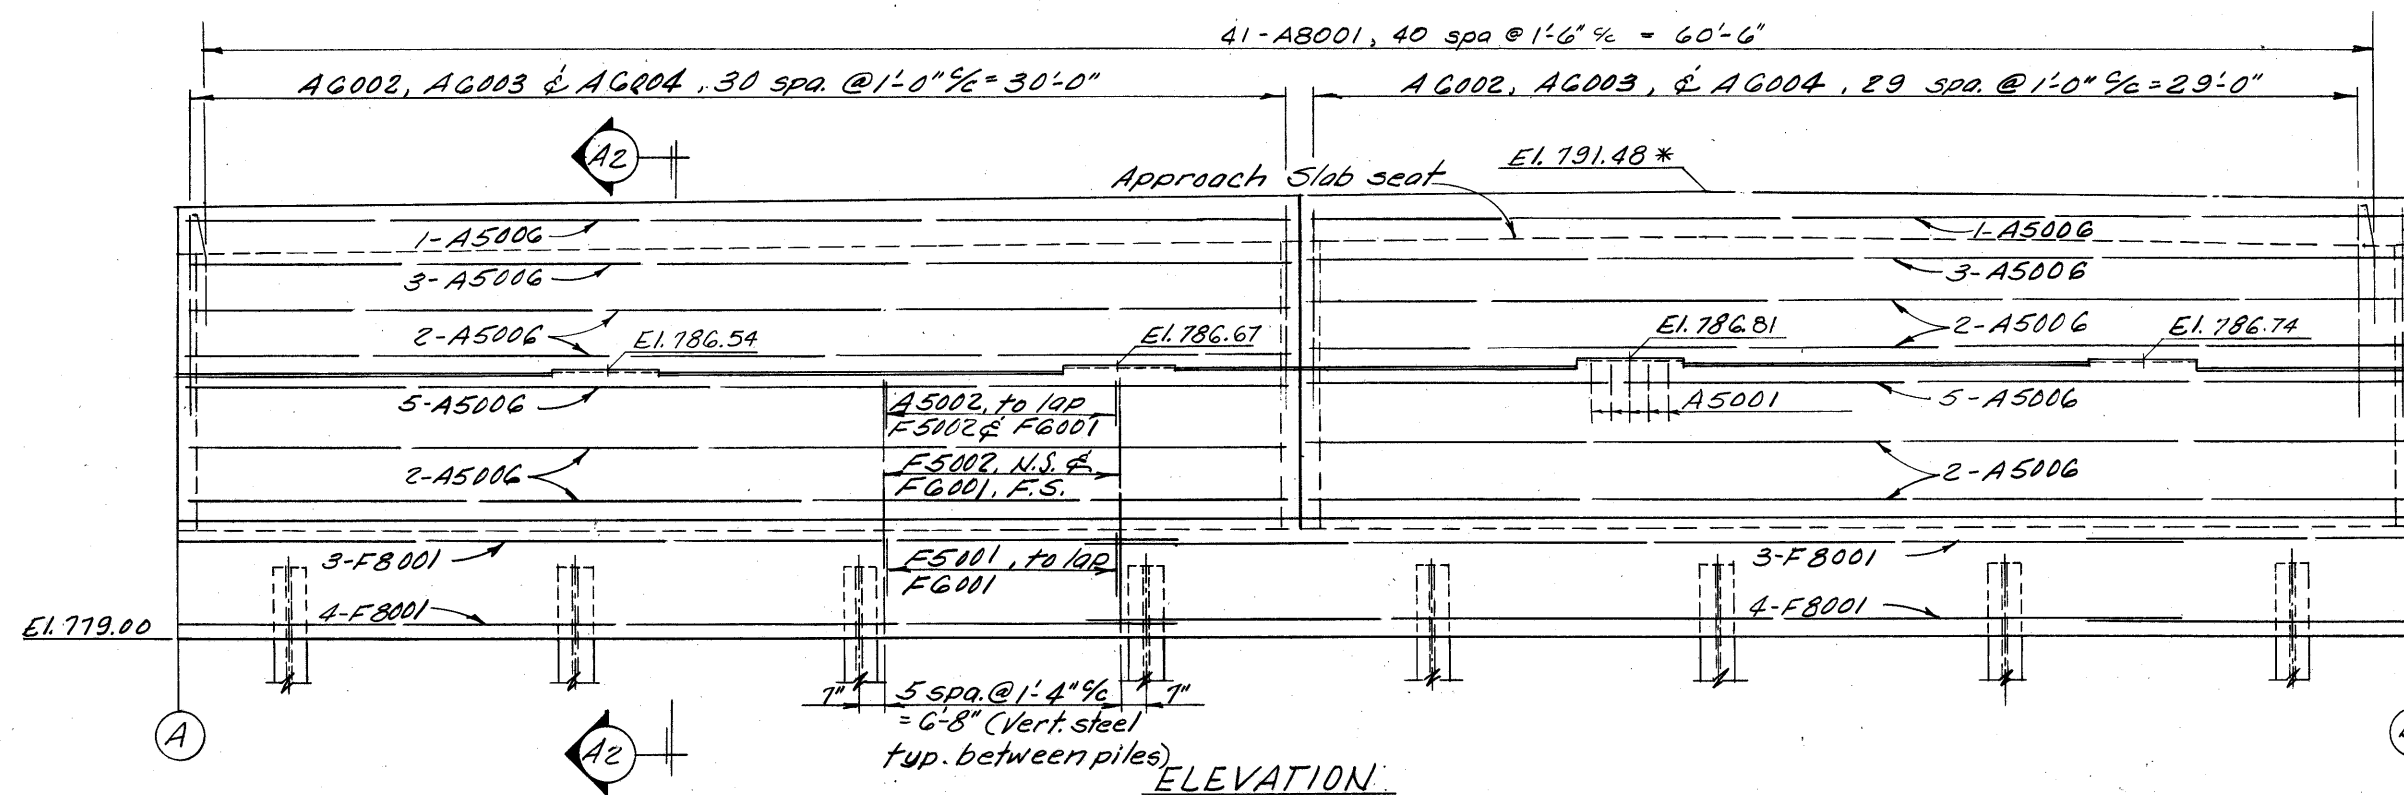

PLAN

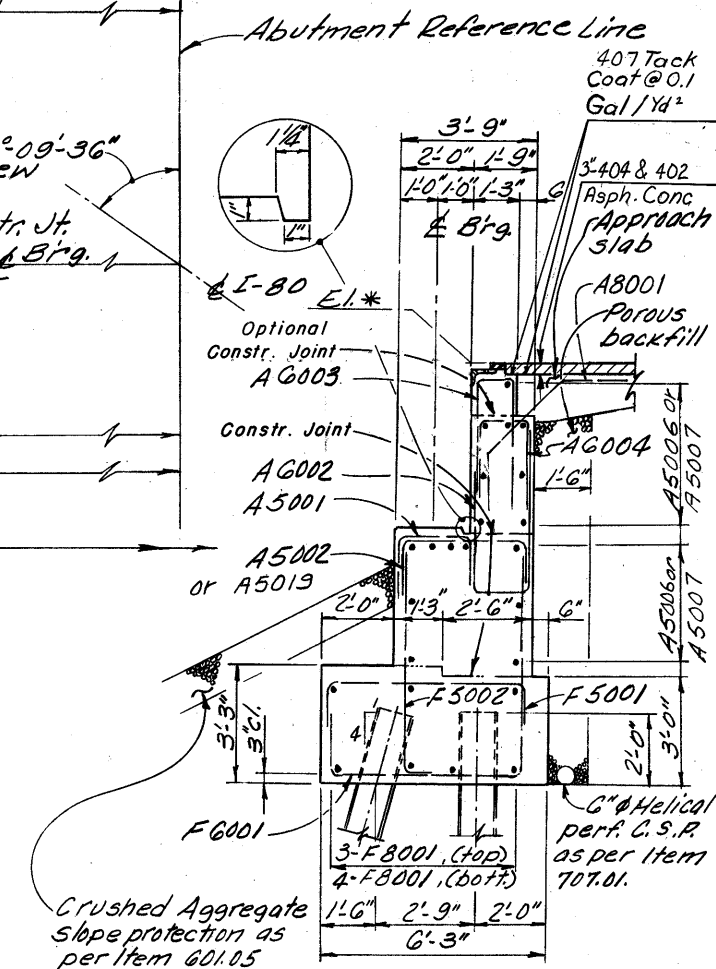

25) ELEVATION



SECTION A2-A2

Note: All piles are HP 10x42-Piles
 indicates vertical piles
 indicates piles battered 1:4


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* Elevations shown thus are pavement elevations at the face of back wall and the point indicated.


5/24

For additional notes
see Sht. 4/24

ALDEN E. STILSON & ASSOCIATES, LIMITED CONSULTING ENGINEERS CLEVELAND, OHIO COLUMBUS, OHIO WHEELING, W. VA.						
WEST ABUTMENT DETAILS BRIDGE NO. LOR-80-1998 I-80 OVER S.R. 10 (LORAIN ROAD) LORAIN COUNTY STA. 92 + 89.14 STA. 95 + 44.32						
DESIGNED	DRAWN	TRACED	CHECKED	REVIEWED	DATE	REVISED
R.S.S.	R.T.		B.I.P.	G.W.M.	5/26/70	

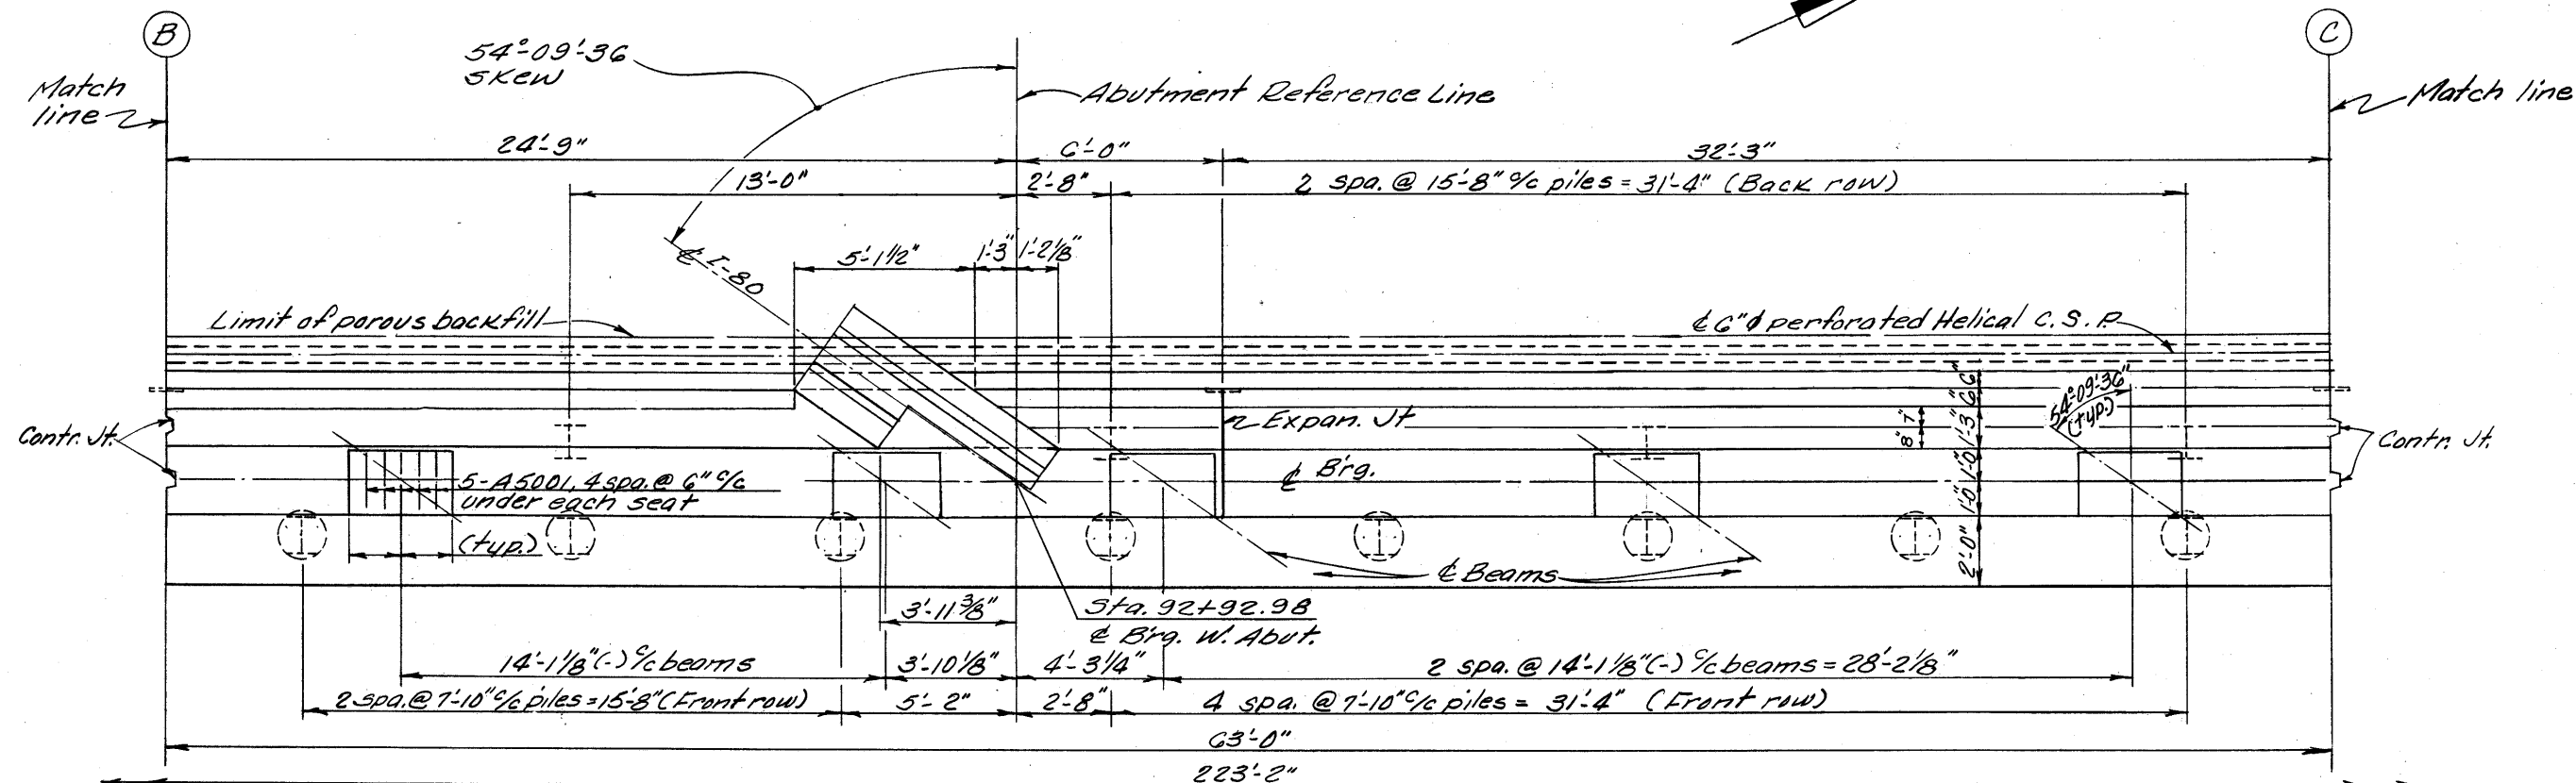

PLAN

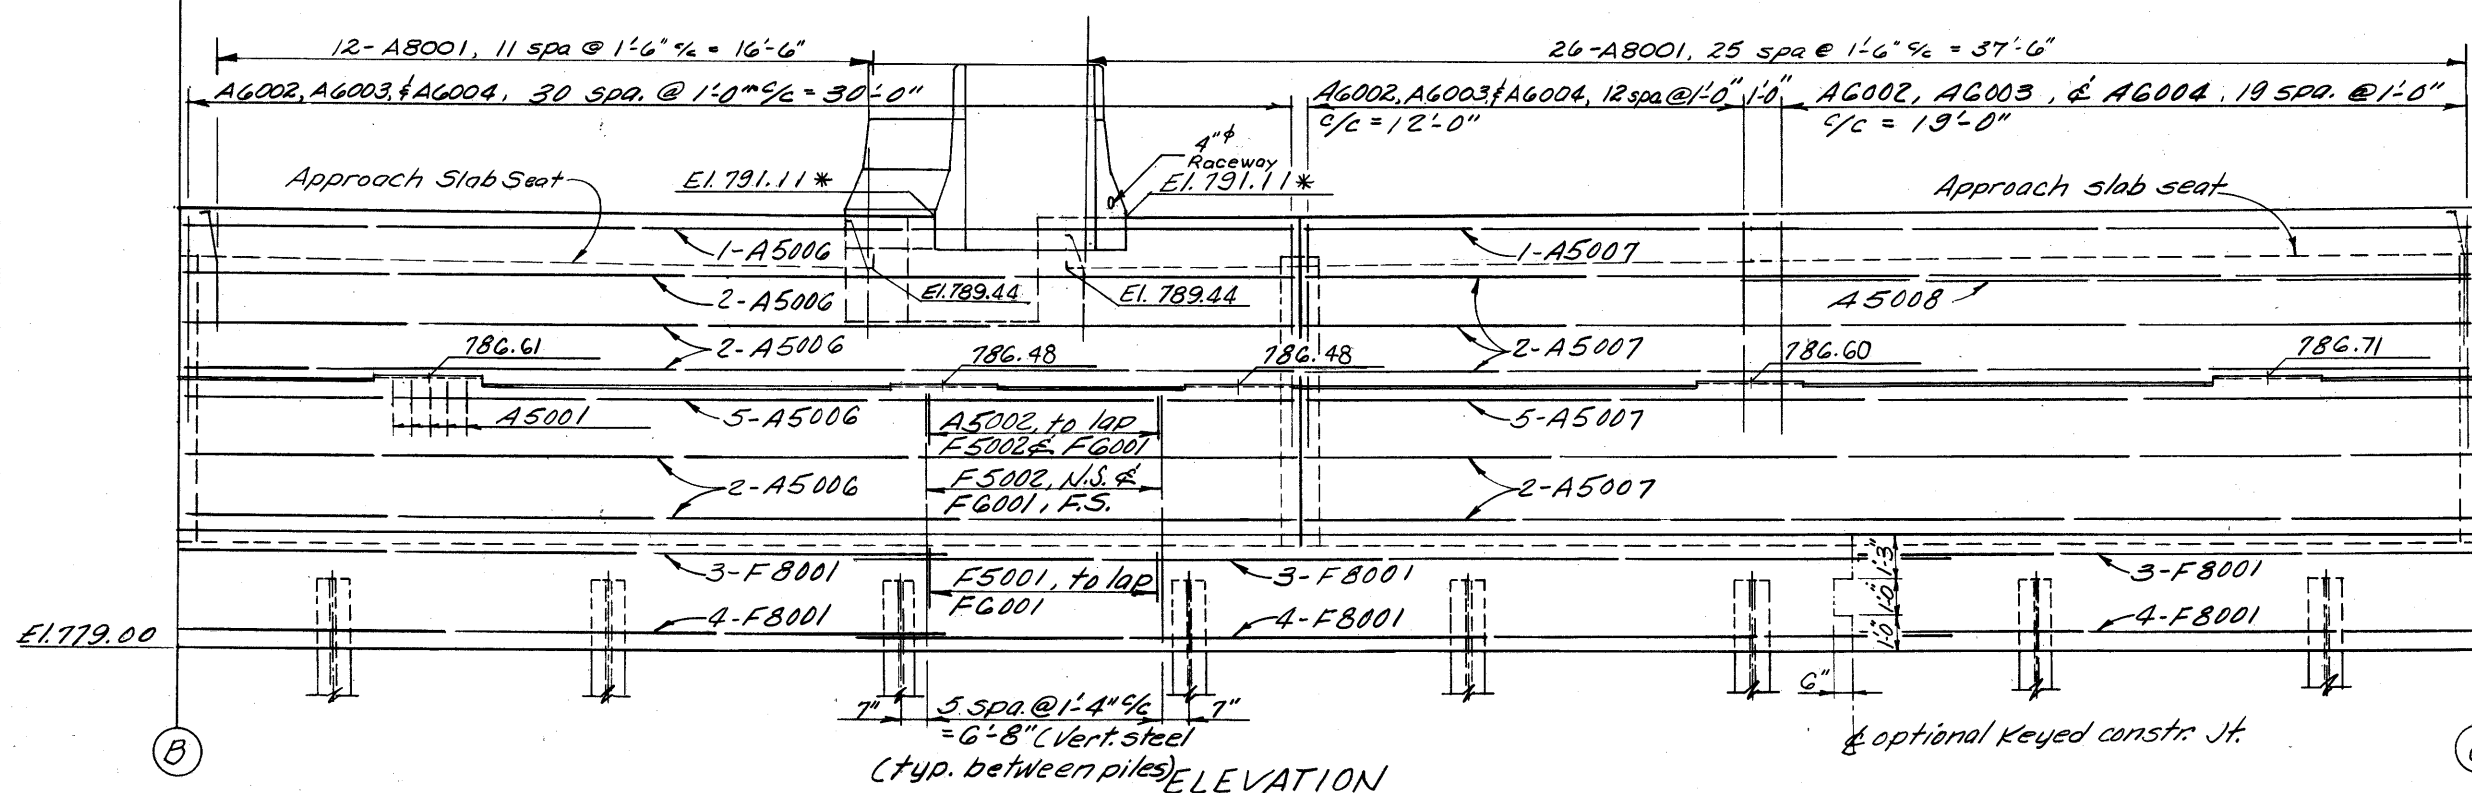

ELEVATION

Notes:

All piles are HP 10 x 42 - Piles
⊥ indicates vertical piles
⊙ indicates piles battered 1:4

In reinforcing bar callouts
N.S. indicates near side.
F.S. indicates far side.

* Elevations shown thus are pavement elevations at the face of backwall and the point indicated.


For additional notes see Sht. 4/24
The shape of the median on the abutment shall match the shape of the median on the superstructure.
For details of abutment median see Sht. 12/24

ALDEN E. STILSON & ASSOCIATES, LIMITED CONSULTING ENGINEERS CLEVELAND, OHIO COLUMBUS, OHIO WHEELING, W. VA.						
WEST ABUTMENT DETAILS BRIDGE N2 LOR-80-1998 I-80 OVER S.R. 10 (LORAIN ROAD)						
LORAIN COUNTY				STA. 92 + 89.14 STA. 95 + 44.32		
DESIGNED	DRAWN	TRACED	CHECKED	REVIEWED	DATE	REVISED
R.S.S.	R.T.		B.I.P.	G.W.M.	5/26/79	


JUL 19 1998

FED. RD. DIVISION	STATE	PROJECT	TYPE FUNDS
2	OHIO		336 375

LORAIN COUNTY
LOR. - 480-0.00

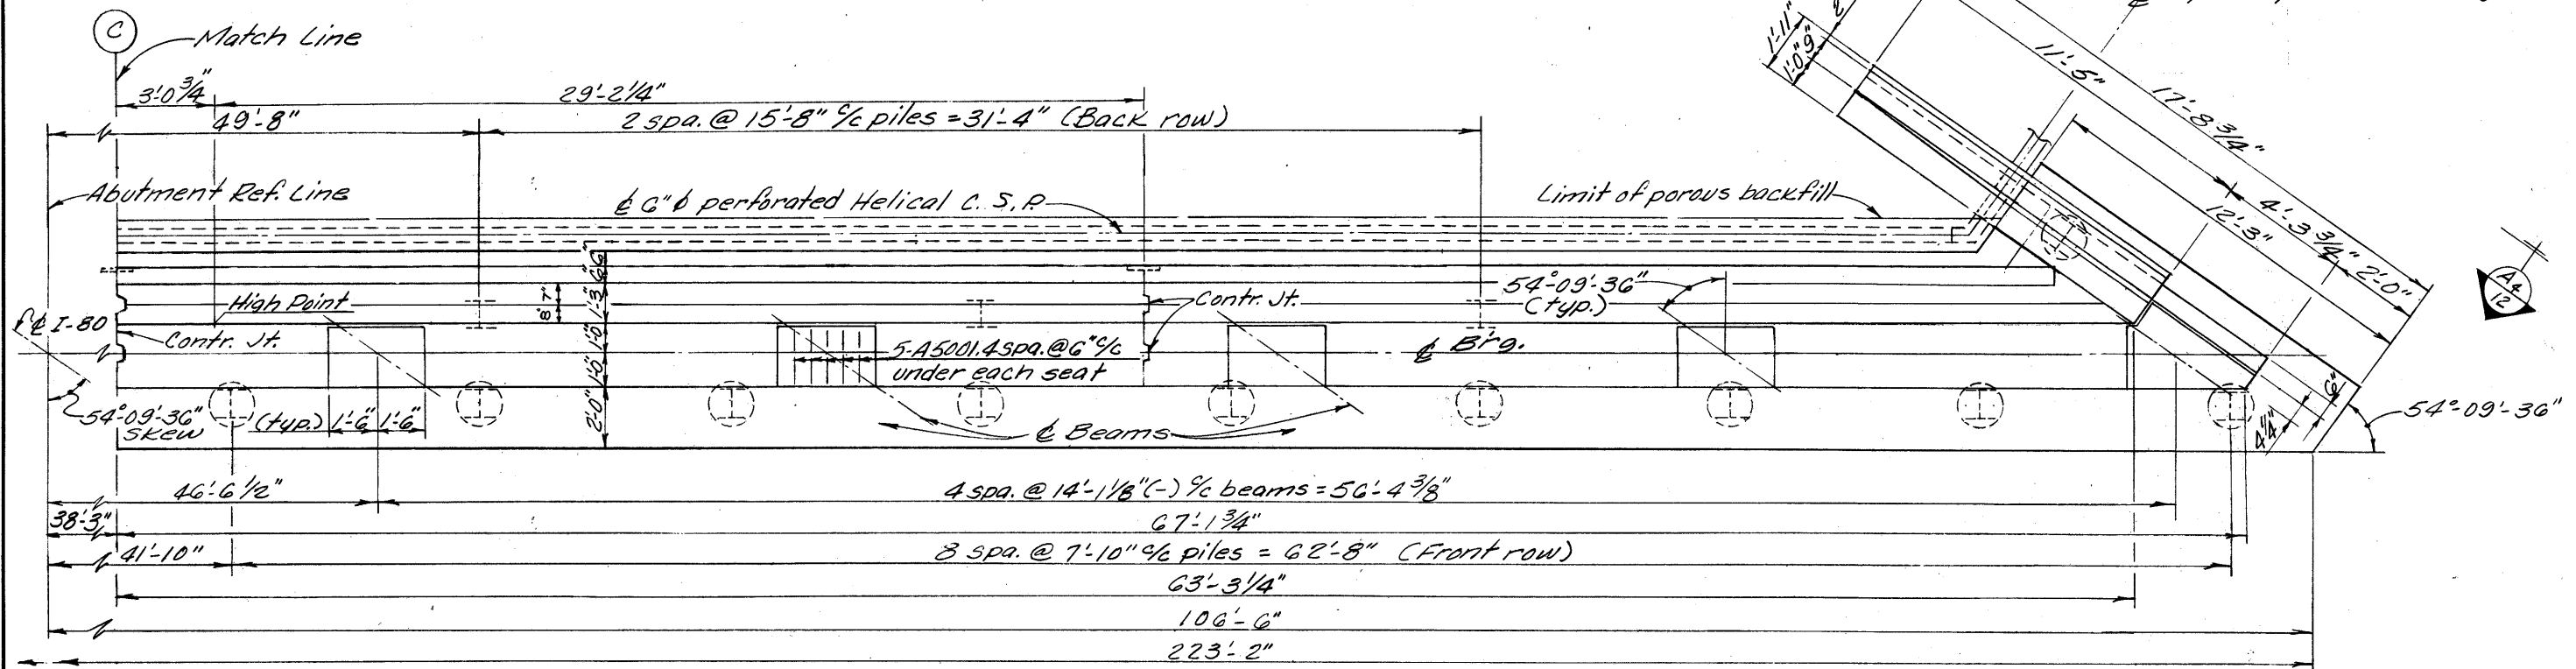

PLAN

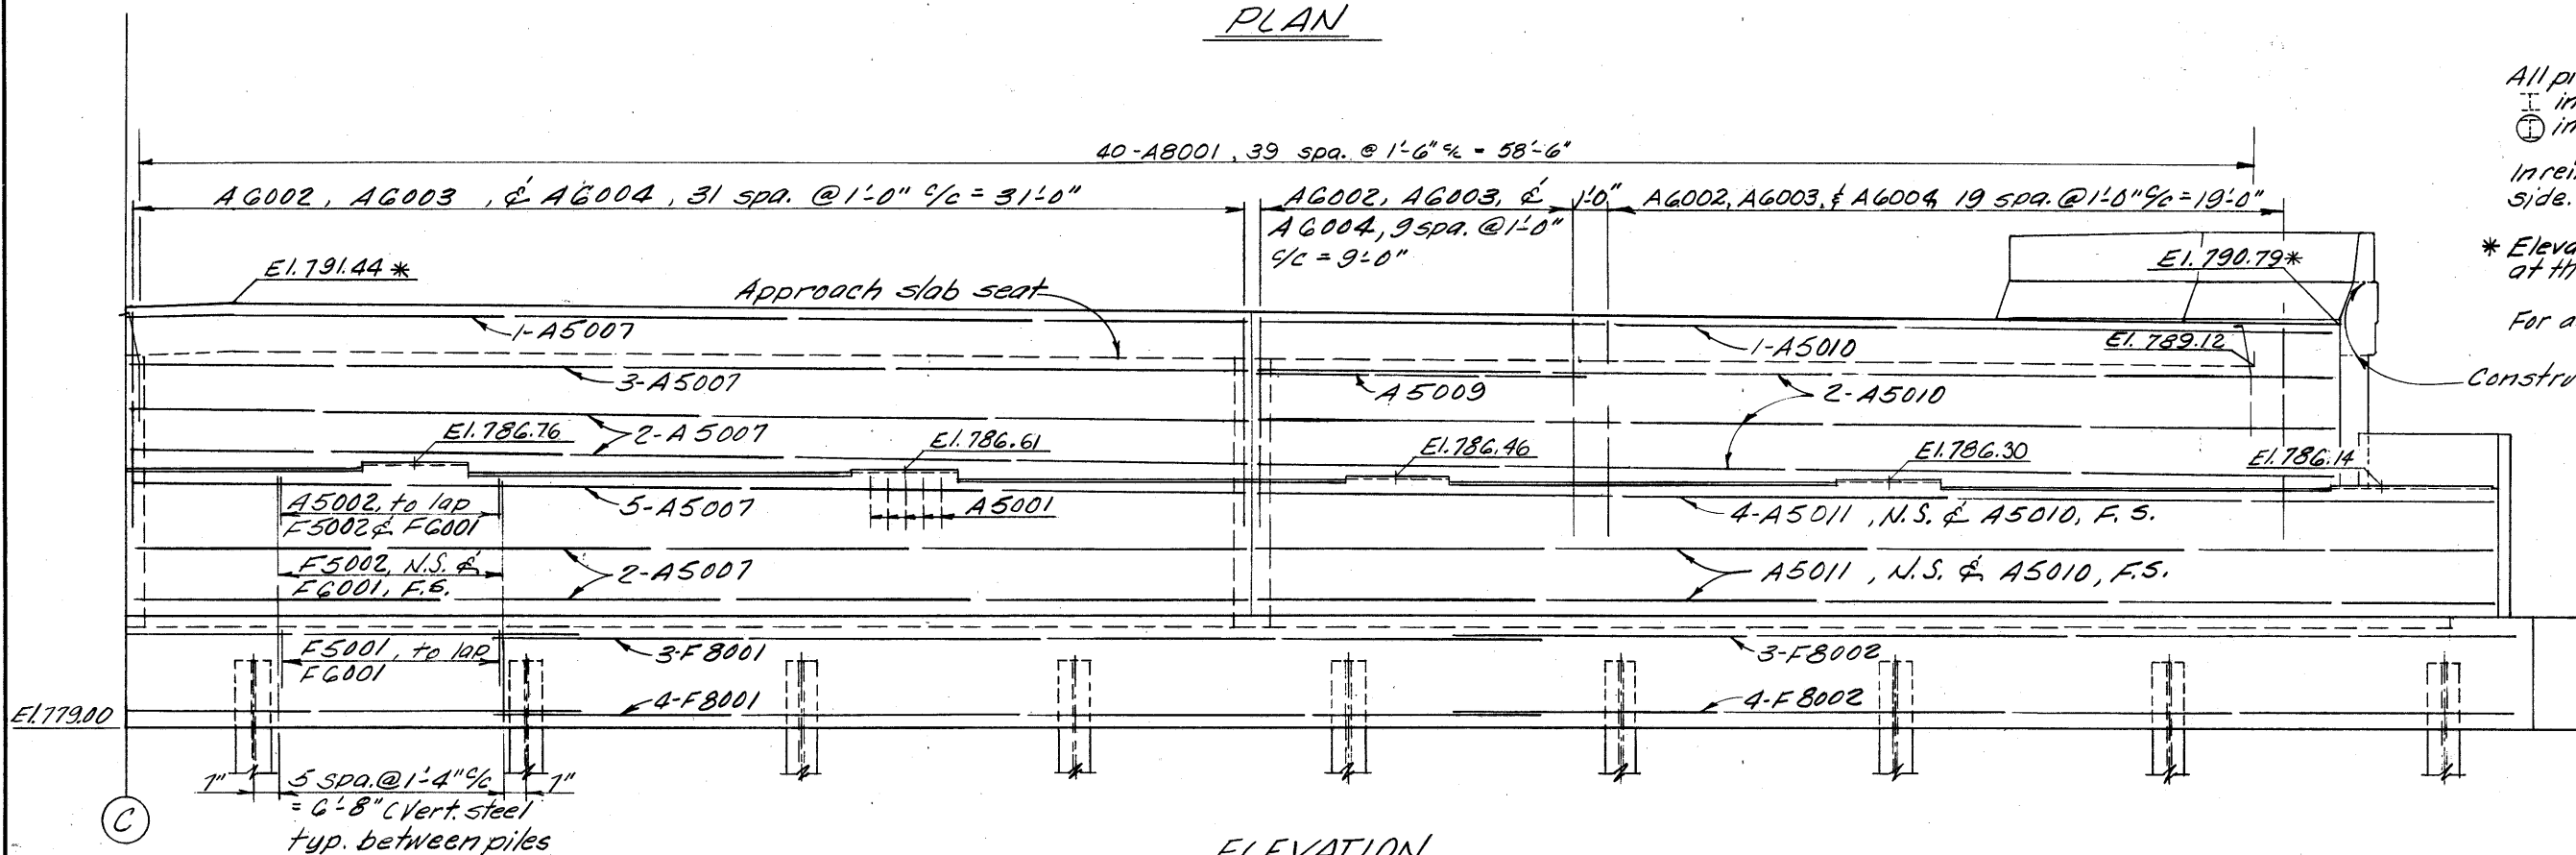

ELEVATION

Note:

All piles are HP10x42 -piles
⊥ indicates vertical piles
⊙ indicates piles battered 1:4

In reinforcing bar callouts, N.S. indicates near side. F.S. indicates far side.

* Elevations shown thus are pavement elevations at the face of back wall and the point indicated.

For additional notes see Sht. 4/24

Construction Jt.


ALDEN E. STILSON & ASSOCIATES, LIMITED CONSULTING ENGINEERS CLEVELAND, OHIO COLUMBUS, OHIO WHEELING, W. VA.							
WEST ABUTMENT DETAILS BRIDGE NO LOR-80-1998 I-80 OVER S.R. 10 (LORAIN ROAD)							
LORAIN COUNTY				STA. 92+89.14 STA. 95+44.32			
DESIGNED	DRAWN	TRACED	CHECKED	REVIEWED	DATE	REVISED	
R.S.S.	R.T.		B.I.P.	G.W.M.	5/24/10		

RECEIVED
JUL 19 1998


FED. RD. DIVISION	STATE	PROJECT	TYPE FUNDS
2	OHIO		

337
375

LORAIN COUNTY
LOR. - 480-0.00

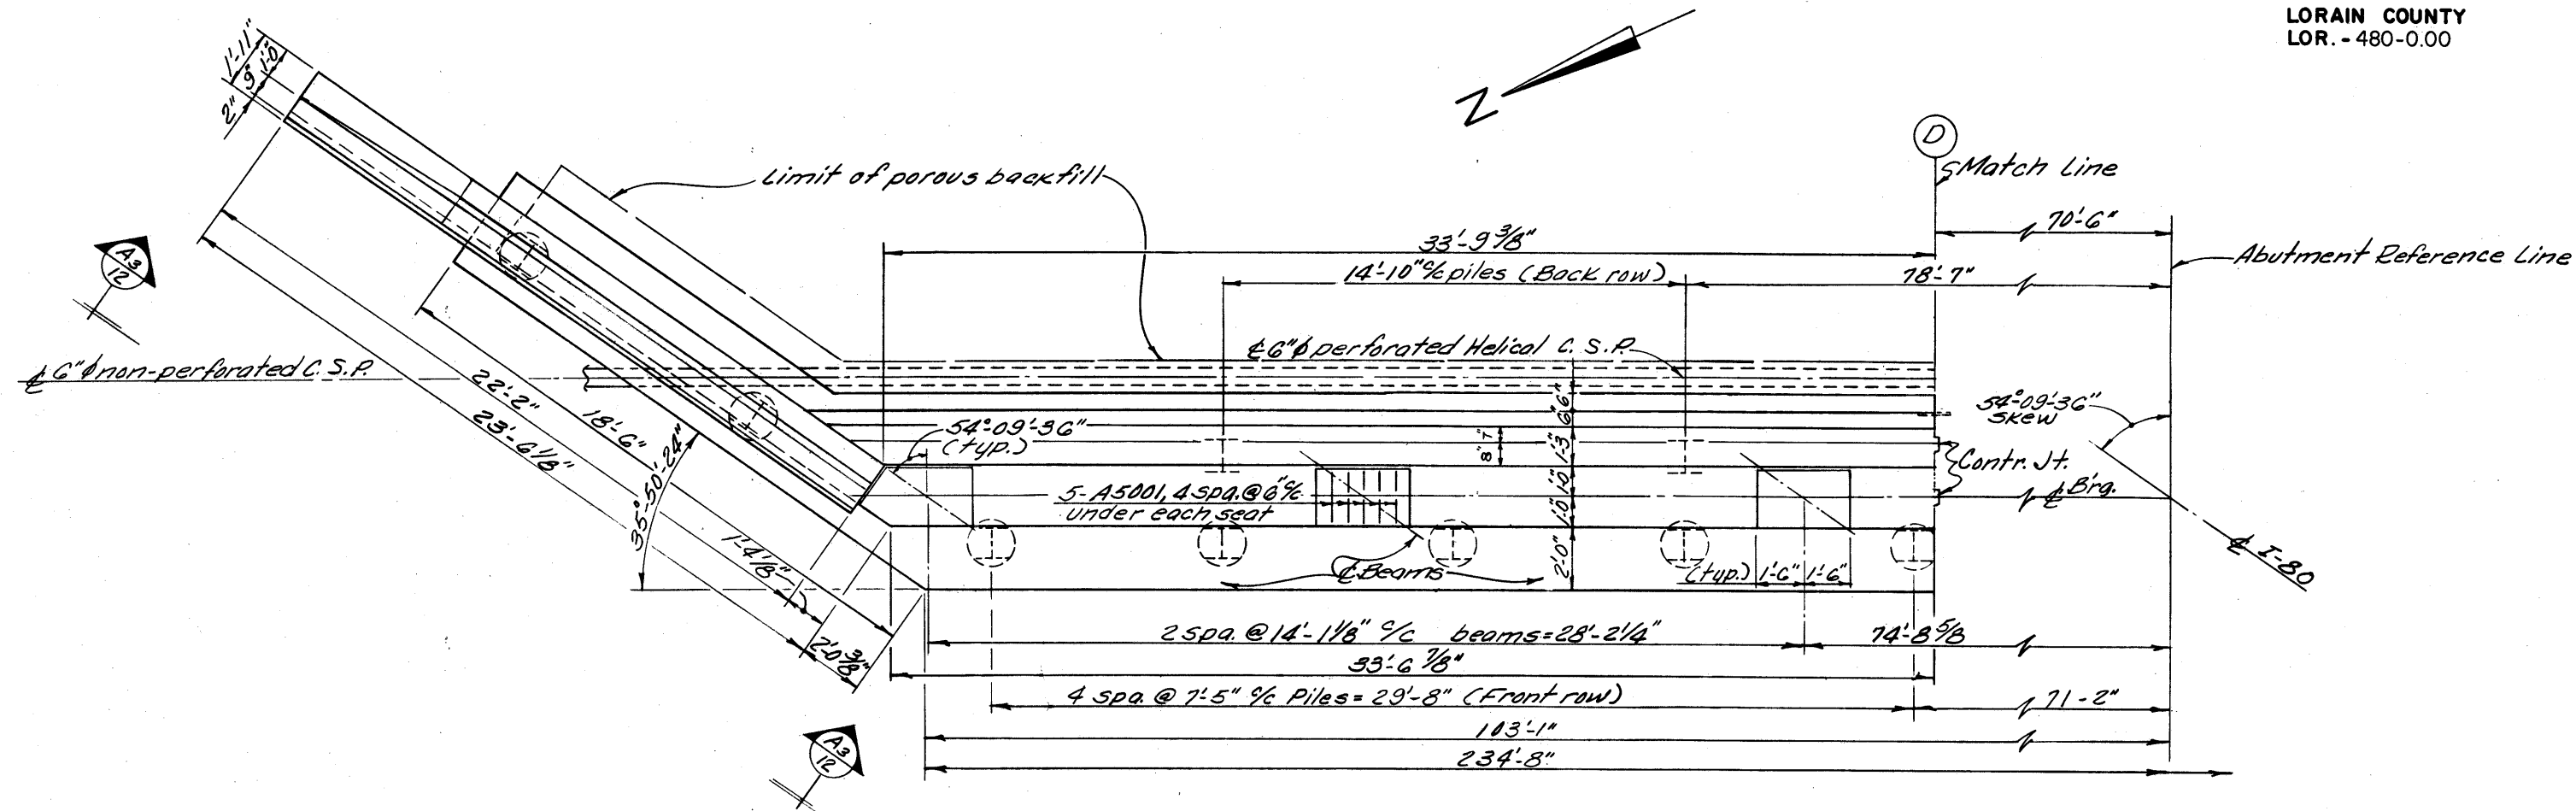

PLAN

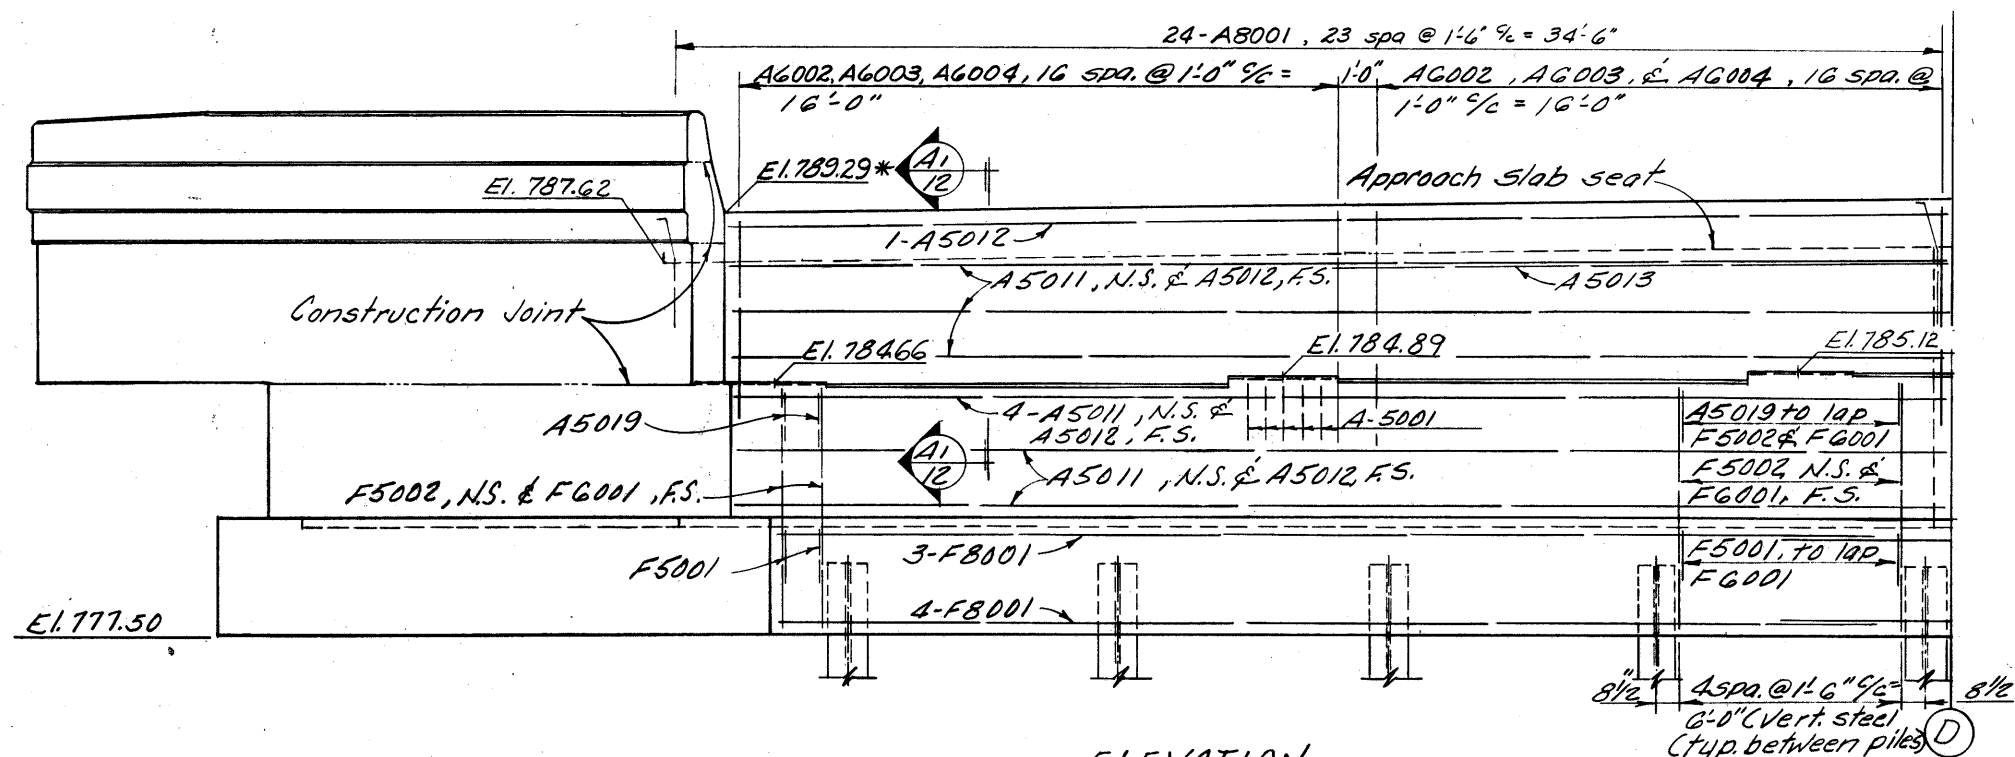


ELEVATION

Notes:


- All piles are HP 10x42-Piles
- indicates vertical piles
- indicates piles battered 1:4
- In reinforcing bar callouts, N.S. indicates near side, F.S. indicates far side.
- * Elevations shown thus are pavement elevations at the face of backwall and the point indicated.
- For additional notes see Sht. 4/24

ALDEN E. STILSON & ASSOCIATES, LIMITED CONSULTING ENGINEERS CLEVELAND, OHIO COLUMBUS, OHIO WHEELING, W. VA.						
EAST ABUTMENT DETAILS BRIDGE NO. LOR-80-1998 I-80 OVER S.R. 10 (LORAIN ROAD)						
LORAIN COUNTY			STA. 92+89.14 STA. 95+44.32			
DESIGNED	DRAWN	TRACED	CHECKED	REVIEWED	DATE	REVISED
R.S.S.	R.T.		B.I.P.	G.W.M.	5/27/70	

LORAIN COUNTY
LOR. - 480-000

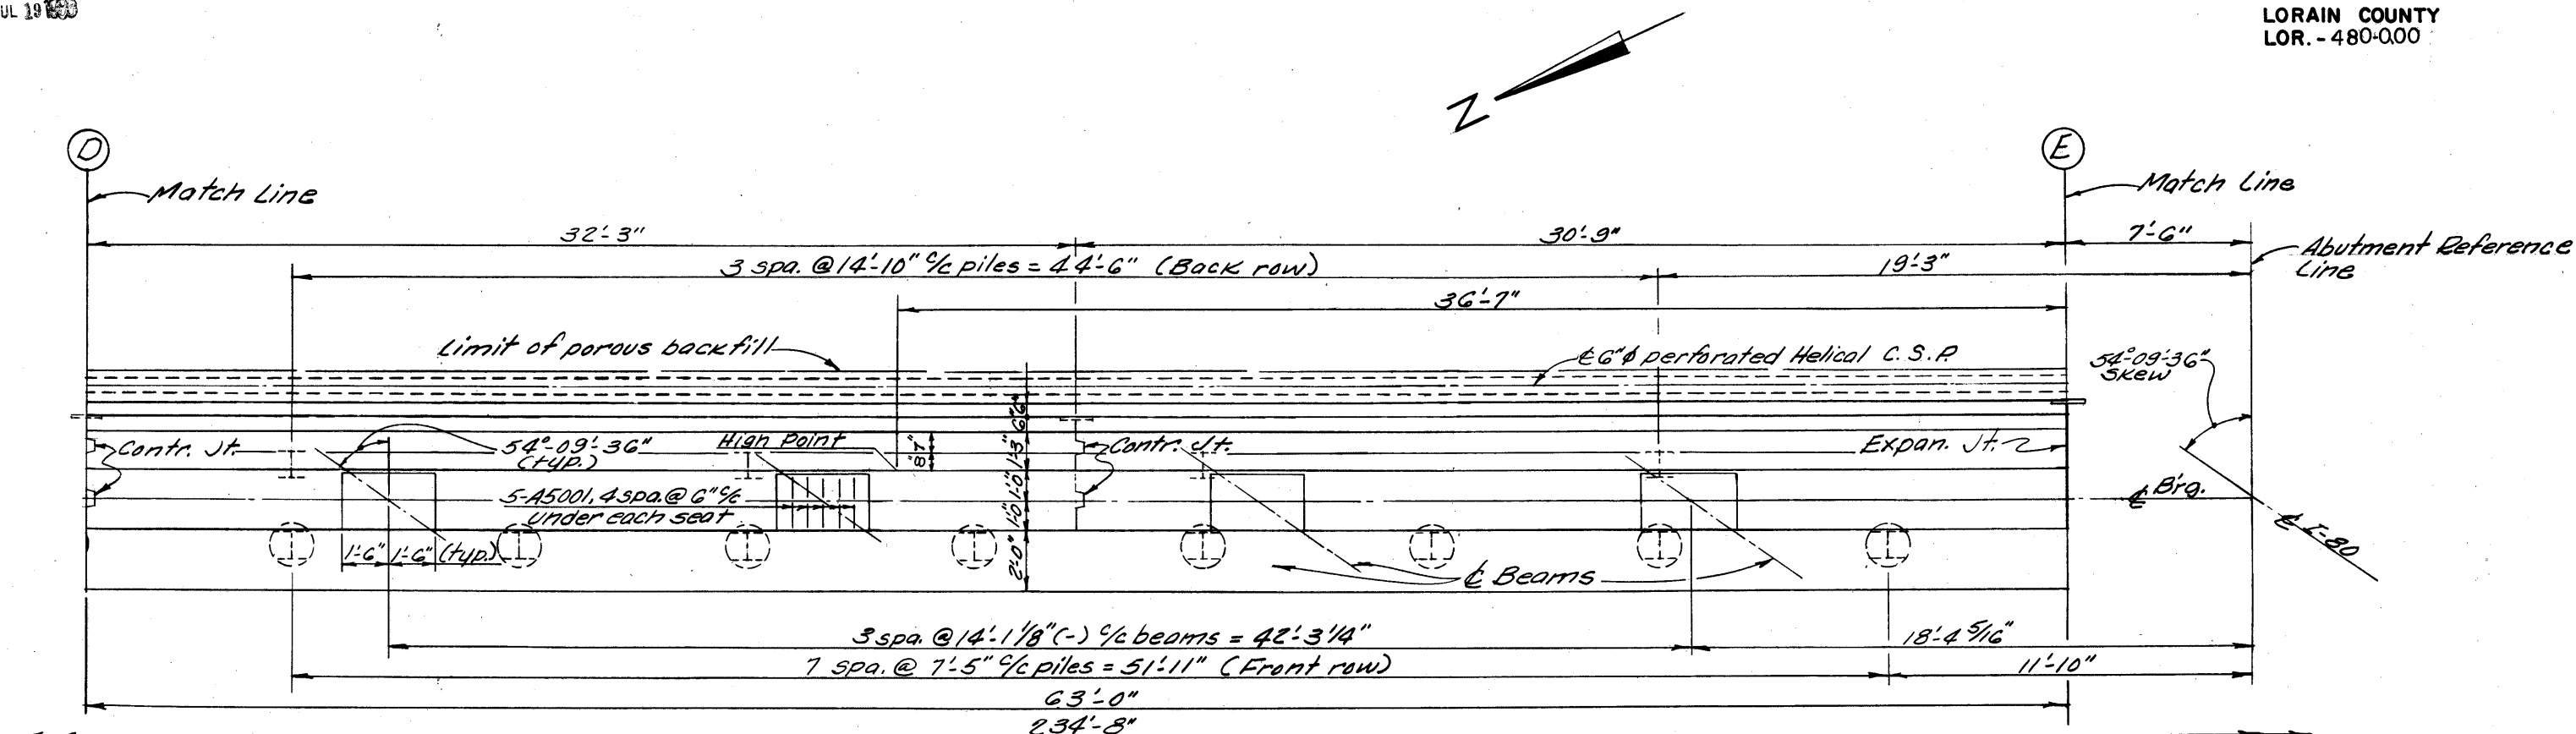

PLAN

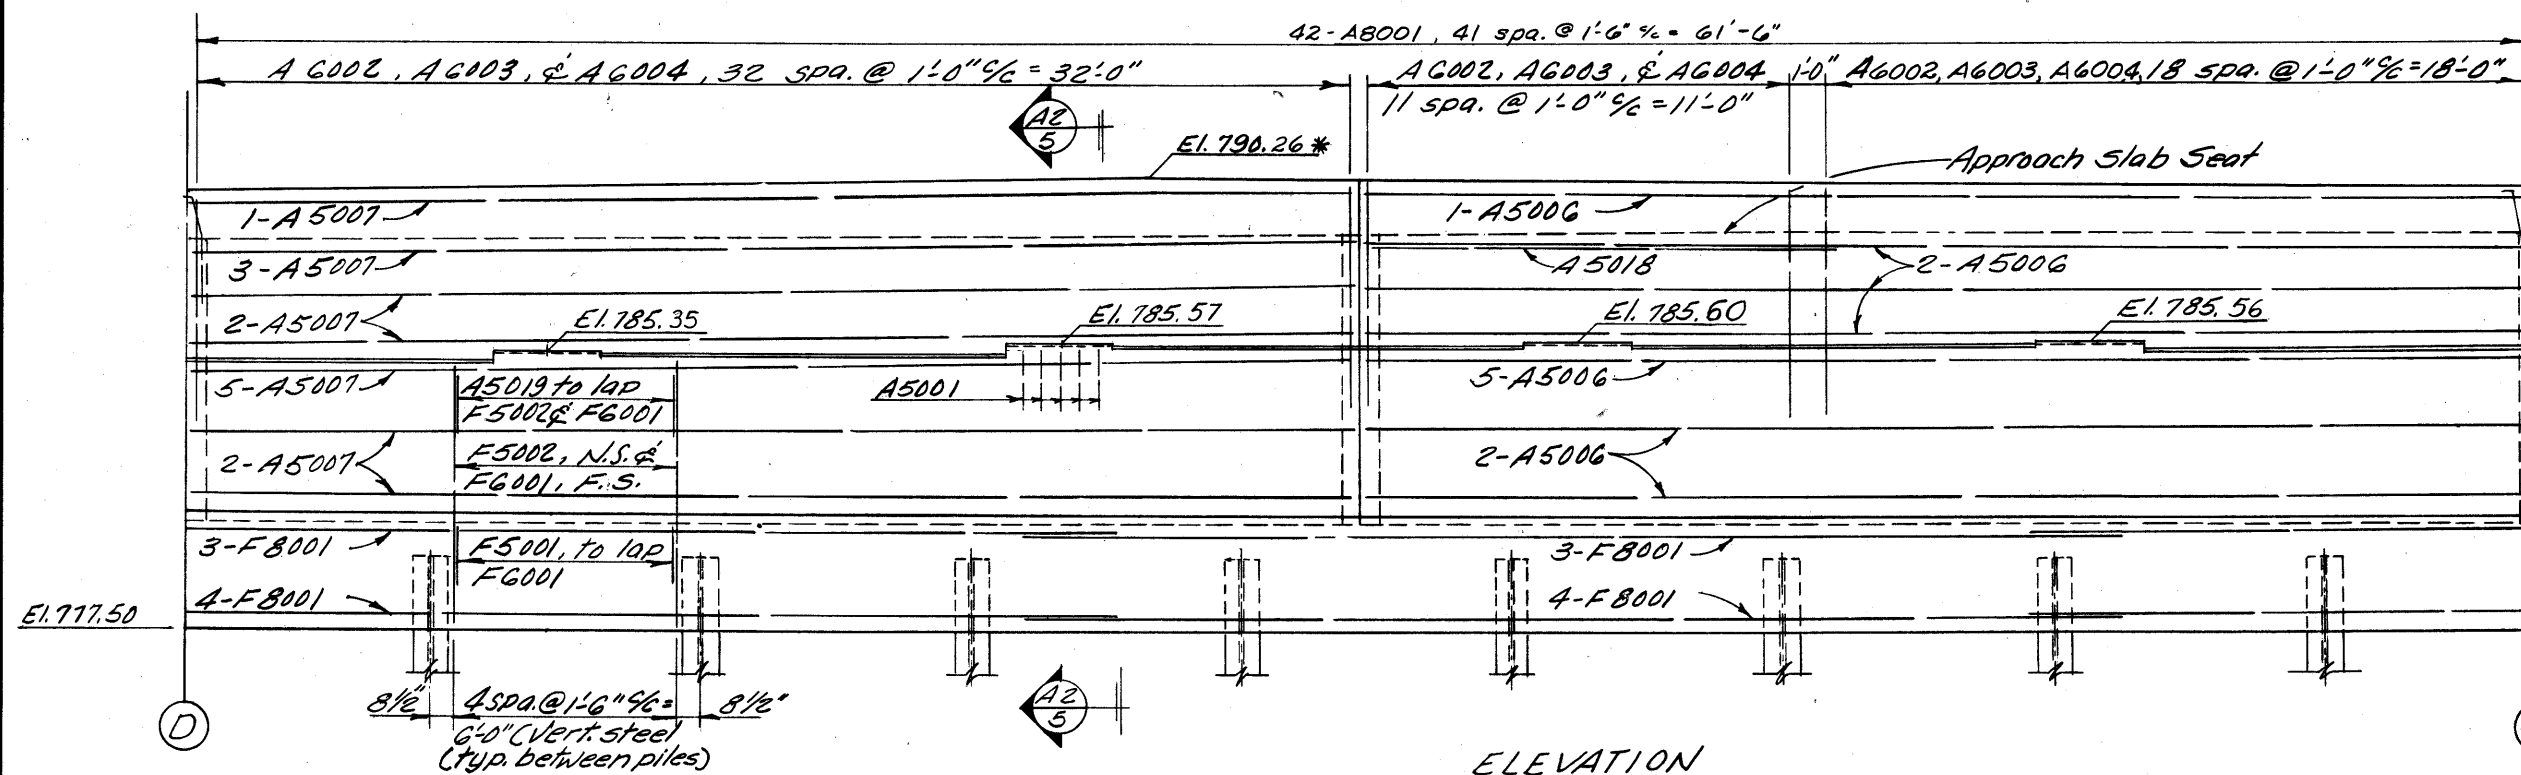

ELEVATION

Notes:

All piles are HP 10 x 42 -piles
 (---) indicates vertical piles
 (---) indicates piles battered 1:4

In reinforcing bar callouts,
N.S. indicates near side.
F.S. indicates far side.

* Elevations shown thus are pavement elevations at the face of backwall and the point indicated.

For additional notes see Sht.

4/20

ALDEN E. STILSON & ASSOCIATES, LIMITED
CONSULTING ENGINEERS
CLEVELAND, OHIO COLUMBUS, OHIO WHEELING, W. VA.


EAST ABUTMENT DETAILS
BRIDGE No LOR-80-1998

I-80 OVER S.R. 10 (LORAIN ROAD)


LORAIN COUNTY	STA. 92 + 89.14
	STA. 95 + 44.32

DESIGNED	DRAWN	TRACED	CHECKED	REVIEWED	DATE	REVISION
R.S.S.	R.T.		B.I.P.	G.W.M.	5/27/70	

LORAIN COUNTY
LOR. - 80 -480-0.00

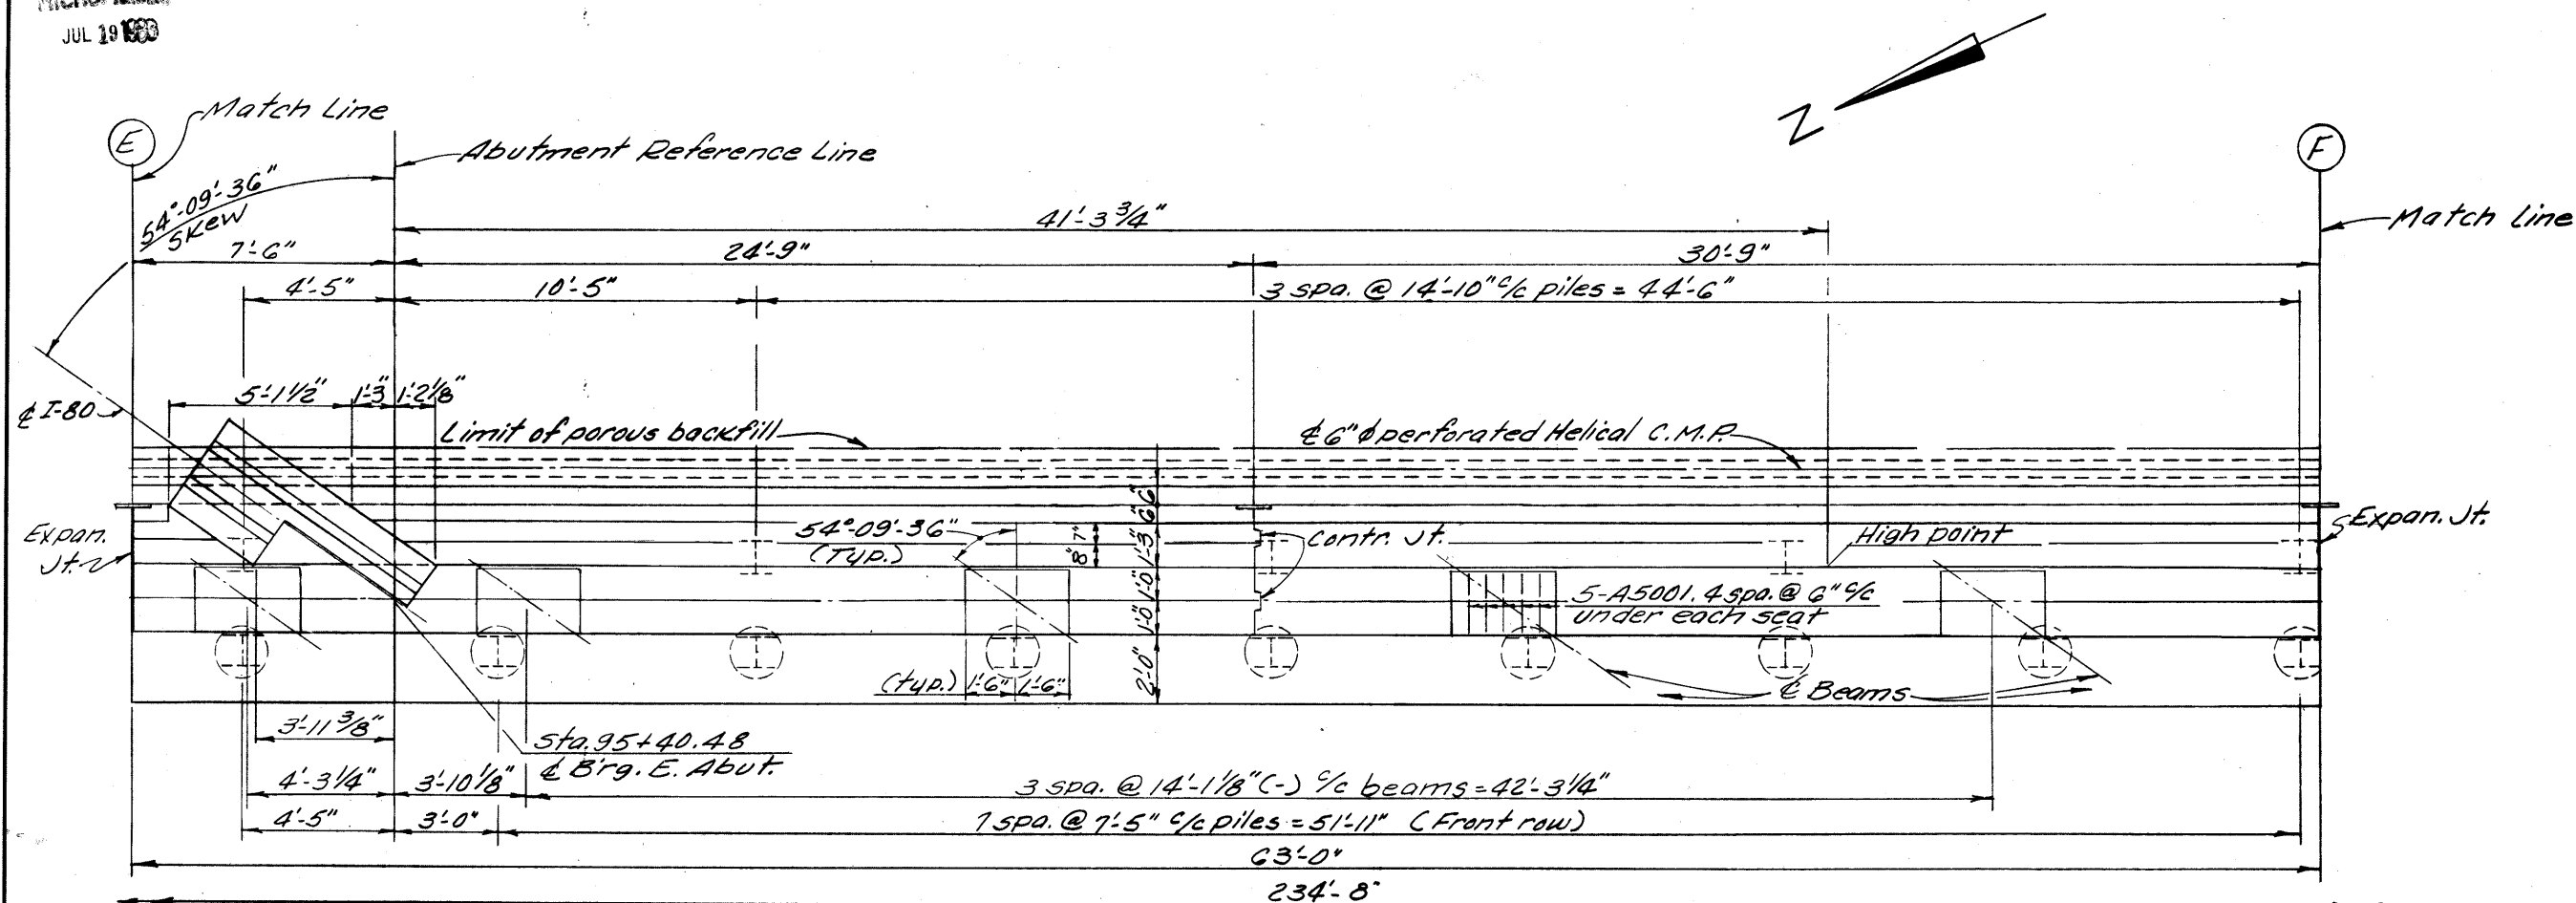

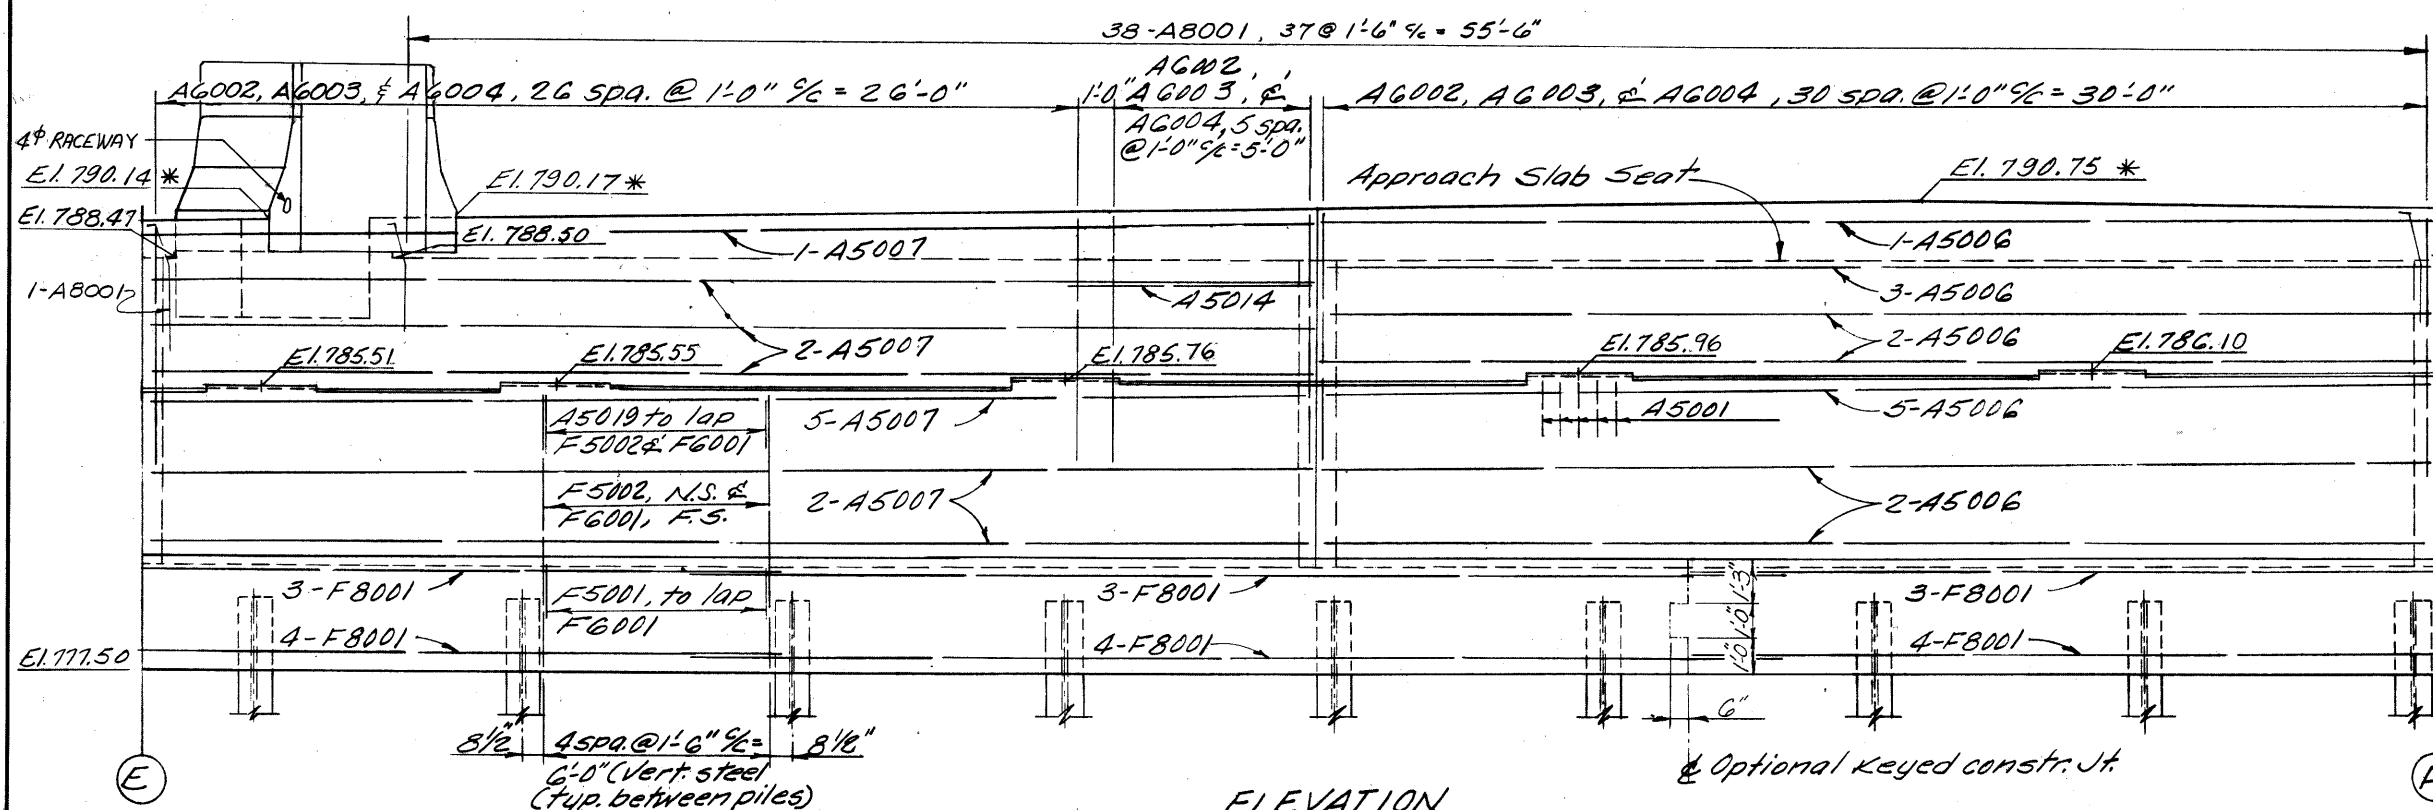

PLAN



ELEVATION

Notes:

All piles are HP 10x42 -piles
 indicates vertical piles
 indicates piles battered 1:4

In reinforcing bar callouts, N.S. indicates near side. F.S. indicates far side.

* Elevations shown thus are pavement elevations at the face of back wall and the point indicated.

For additional notes see Sht.

The shape of the median on the abutment shall match the shape of the median on the super-structure.
For details of abutment median see

5ht. 12/24

ALDEN E. STILSON & ASSOCIATES, LIMITED
CONSULTING ENGINEERS
CLEVELAND, OHIO COLUMBUS, OHIO WHEELING, W. VA.

EAST ABUTMENT DETAILS
BRIDGE No LOR-80-1998

I-80 OVER S.R. 10 (LORAIN ROAD)

LORAIN COUNTY	STA. 92 + 89.14
	STA. 95 + 44.32

DESIGNED	DRAWN	TRACED	CHECKED	REVIEWED	DATE	REVISION
R.S.S.	R.T.		B.I.P.	G.W.M.	5/27/70	

F


MICROFILMED
JUL 19 1980

FED. RD. DIVISION	STATE	PROJECT	TYPE FUNDS
2	OHIO		


340
375

LORAIN COUNTY
LOR.-480-000

6" non-perforated C.S.P.

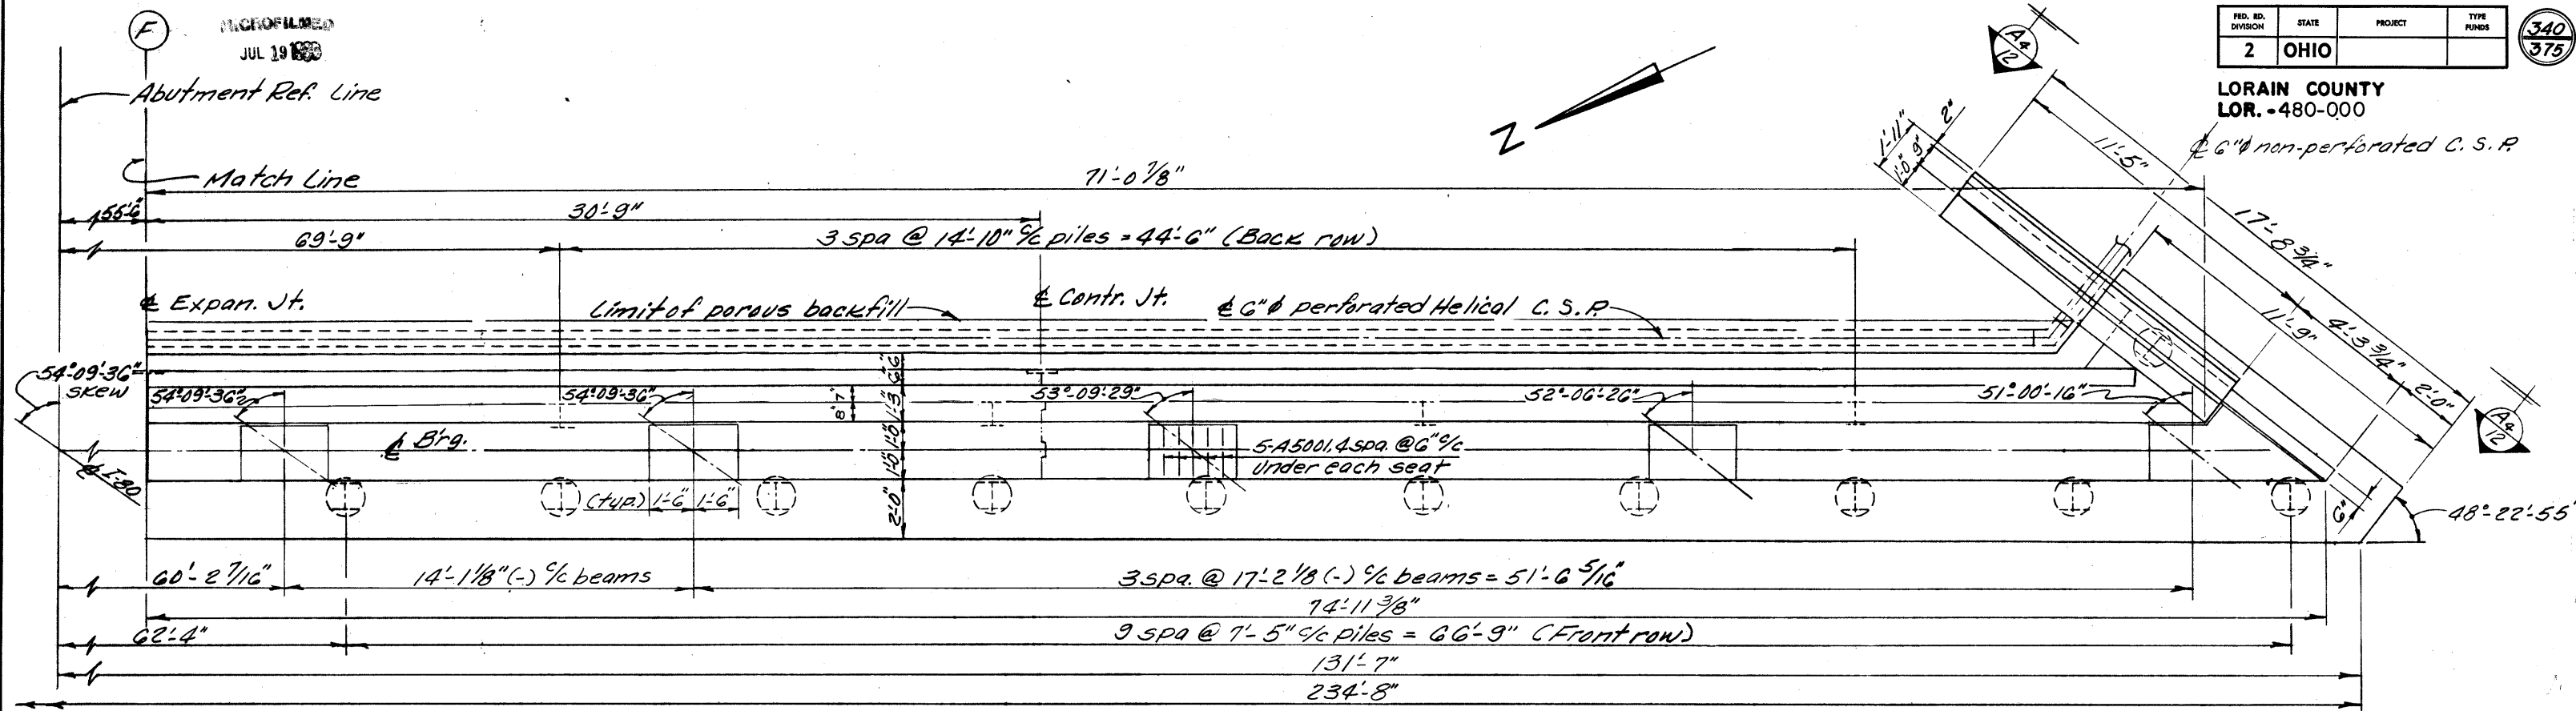

PLAN

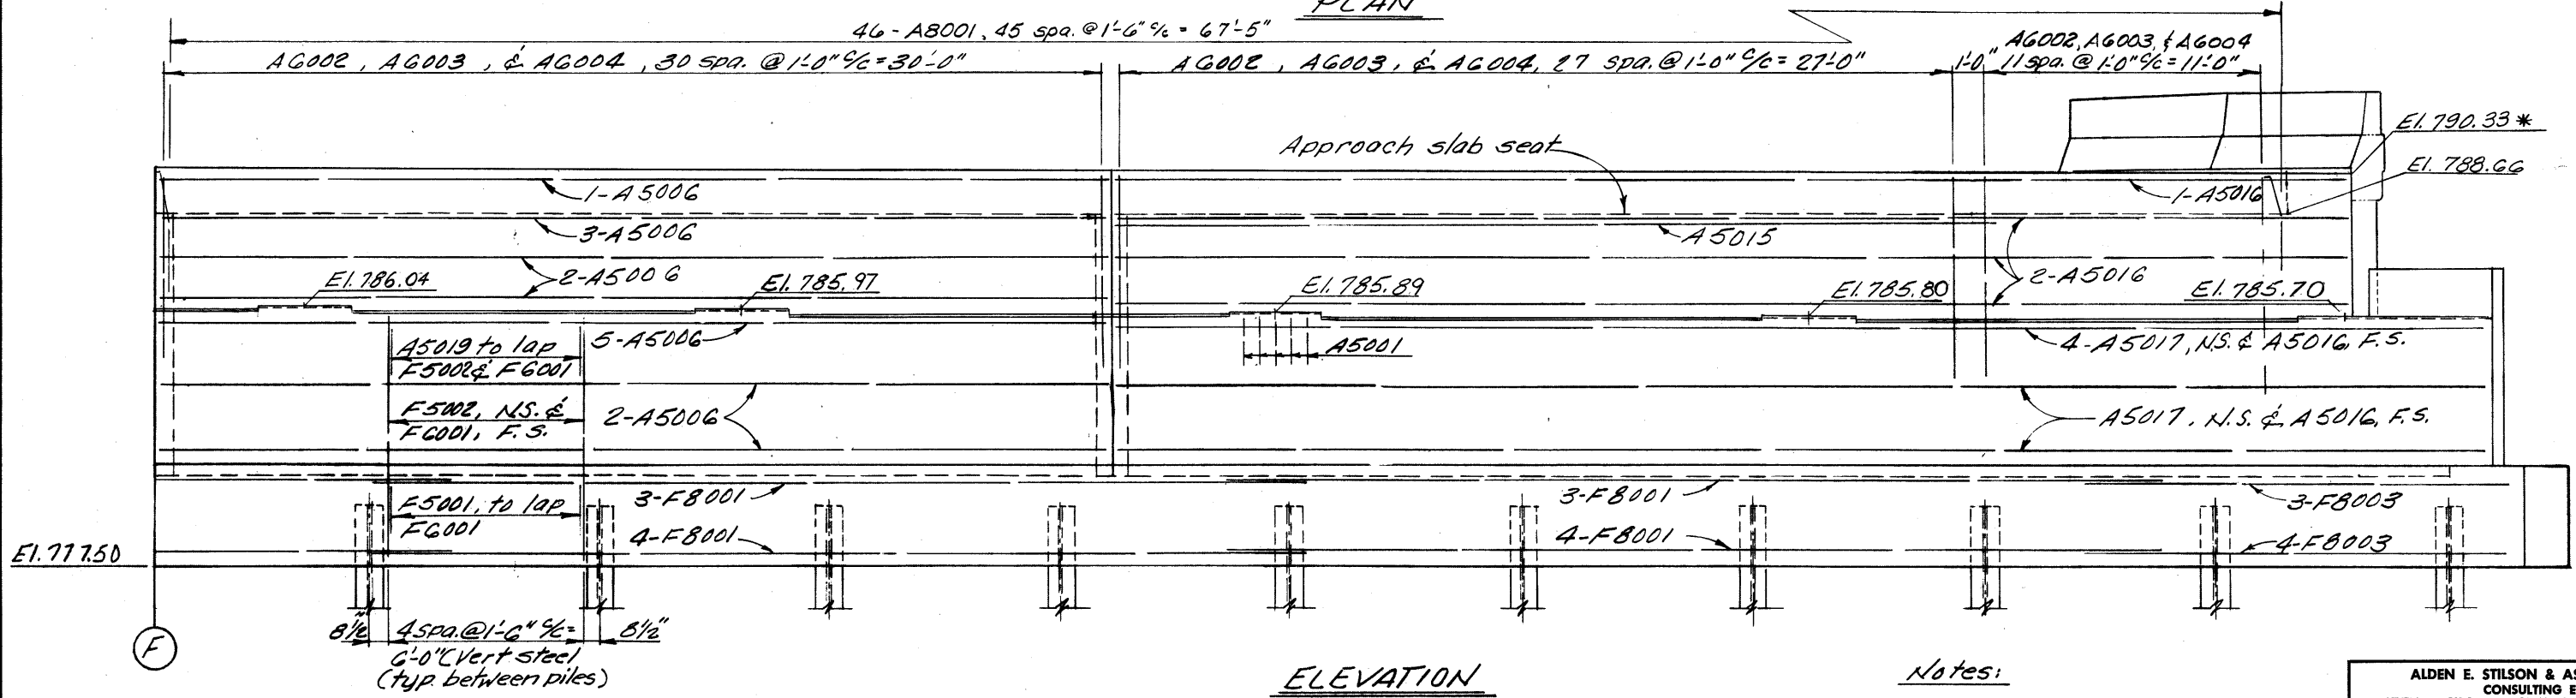

ELEVATION

Notes:

- All piles are HP 10 x 42 Piles
- ⊥ indicates vertical piles
- ⊙ indicates piles battered 1:4
- In reinforcing bar callouts, N.S. indicates near side, F.S. indicates far side.
- * Elevations shown thus are pavement elevations at the face of backwall and the point indicated.
- For additional notes see Sht. 4/24

11/24


ALDEN E. STILSON & ASSOCIATES, LIMITED
CONSULTING ENGINEERS
CLEVELAND, OHIO COLUMBUS, OHIO WHEELING, W. VA.

EAST ABUTMENT DETAILS
BRIDGE NO LOR-80-1998
I-80 OVER S.R. 10 (LORAIN ROAD)


LORAIN COUNTY STA. 92+89.14
STA. 95+44.32

DESIGNED	DRAWN	TRACED	CHECKED	REVIEWED	DATE	REVISED
R.S.S.	R.T.		B.I.P.	G.W.M.	5/27/70	


LORAIN COUNTY
LOR. - 480-0.00

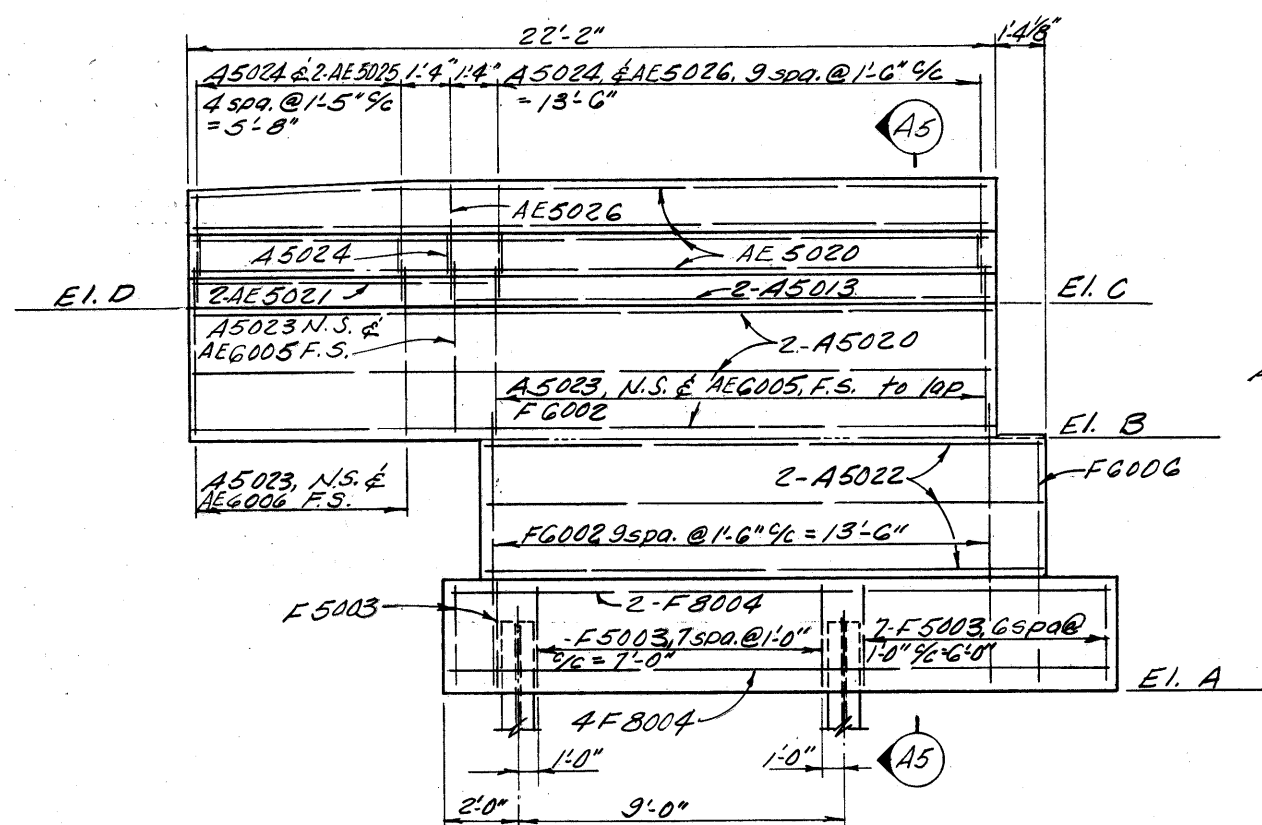

ELEVATION A-3 A-3 SHt. 4/24 & 8/24

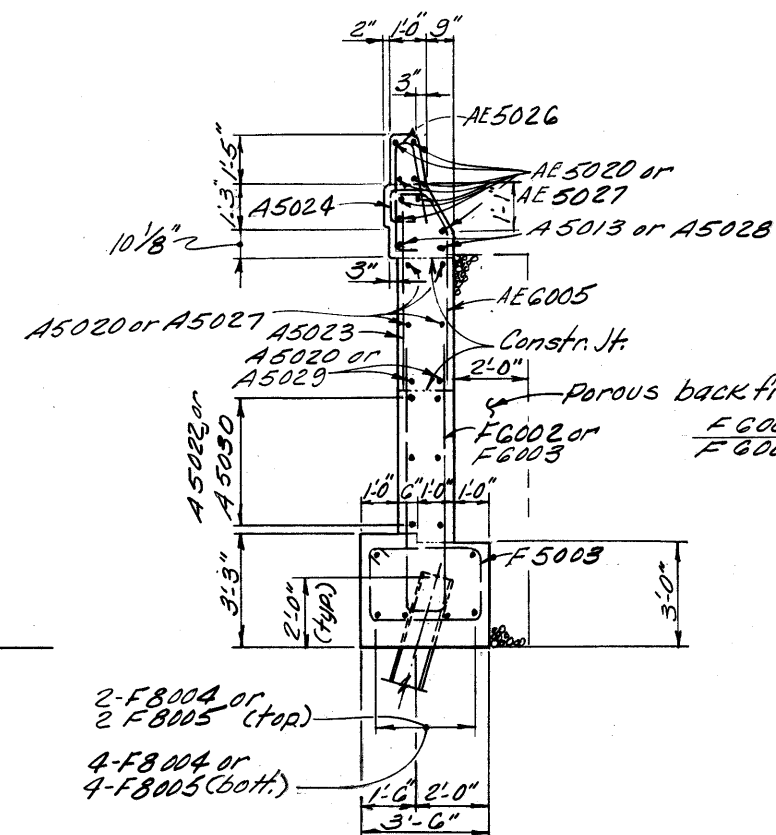


SECTION A-5 A-5

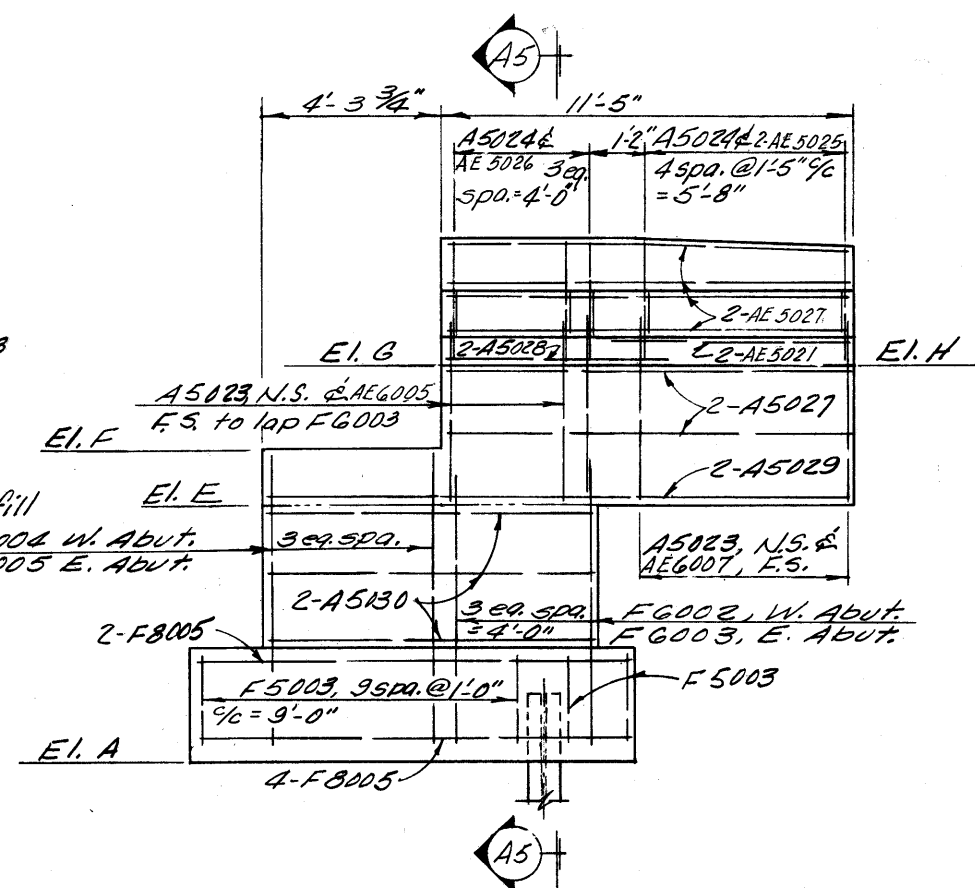


ELEVATION A4-A4 SHt. 7/24 & 11/24


Location	EI. A	EI. B	EI. C	EI. D	EI. E	EI. F	EI. G	EI. H
West Abutment	779.00	786.03	789.91	789.85	786.06	787.78	789.25	789.98
East Abutment	777.50	784.58	788.45	788.24	785.62	787.08	789.49	789.42

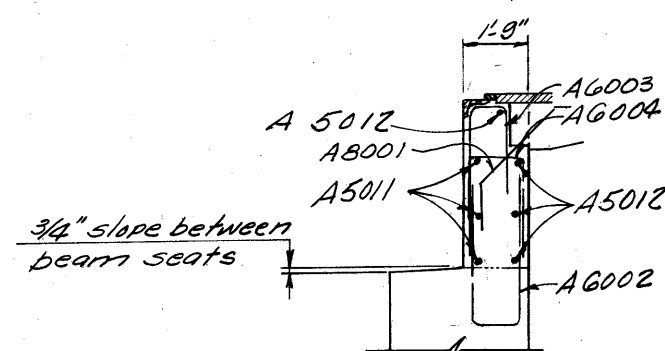

SECTION A1-A1
Details not shown same as
section A2-A2

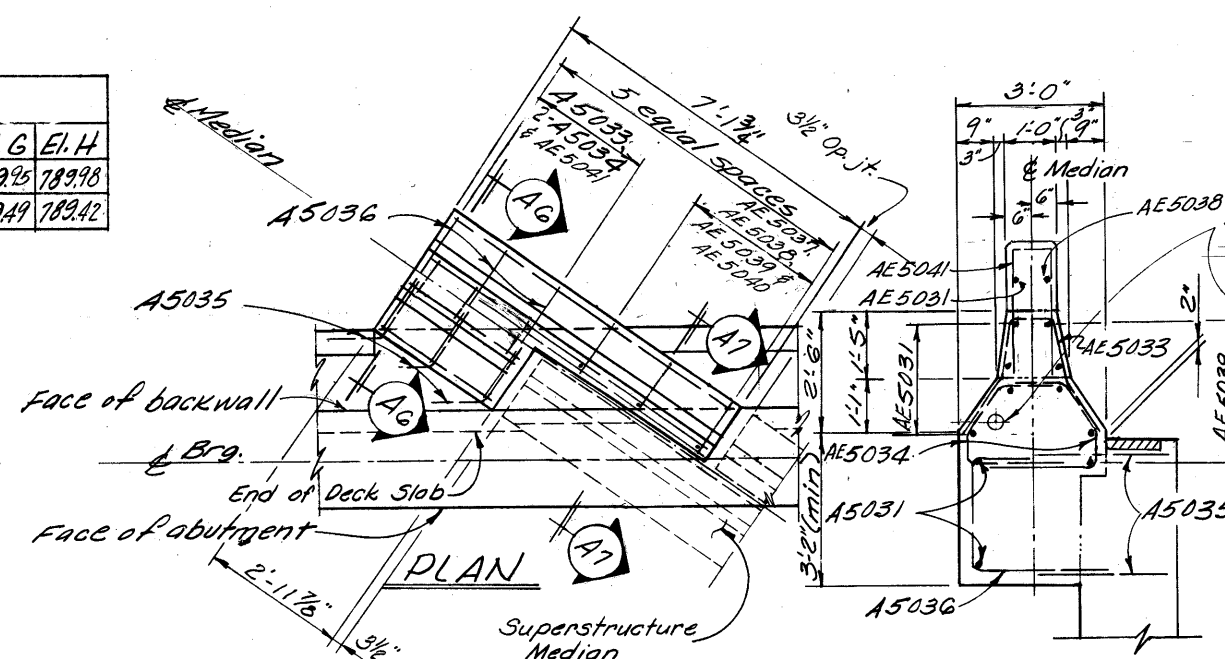

ABUTMENT MEDIAN DETAILS

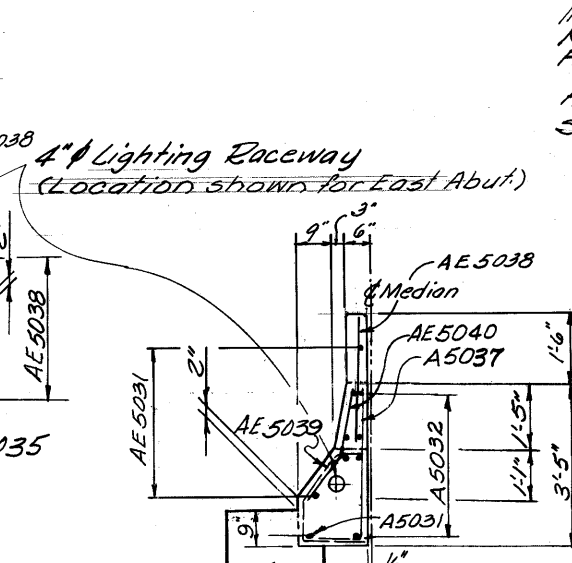

SECTION A7 - A7

NOTES:

In reinforcing bar callouts:
N.S. indicates near side
F.S. indicates far side

For additional notes see
Sht. 4/24

127

ALDEN E. STILSON & ASSOCIATES, LIMITED
CONSULTING ENGINEERS
CLEVELAND, OHIO COLUMBUS, OHIO WHEELING, W. VA.

ABUTMENT DETAILS

BRIDGE NO. LOR-80-1998

I-80 OVER S.R. 10 (LORAIN ROAD)

LORAIN COUNTY

STA. 92 + 89.14

STA. 95 + 44.32


DESIGNED	DRAWN	TRACED	CHECKED	REVIEWED	DATE	REVISION
R.S.S.	R.T.		B.I.P.	G.W.M.	5/27/70	

REPRODUCTION
JUL 19 1980

FED. RD. DIVISION	STATE	PROJECT	TYPE FUNDS
2	OHIO		

342
375

LORAIN COUNTY
LOR.-480-0.00

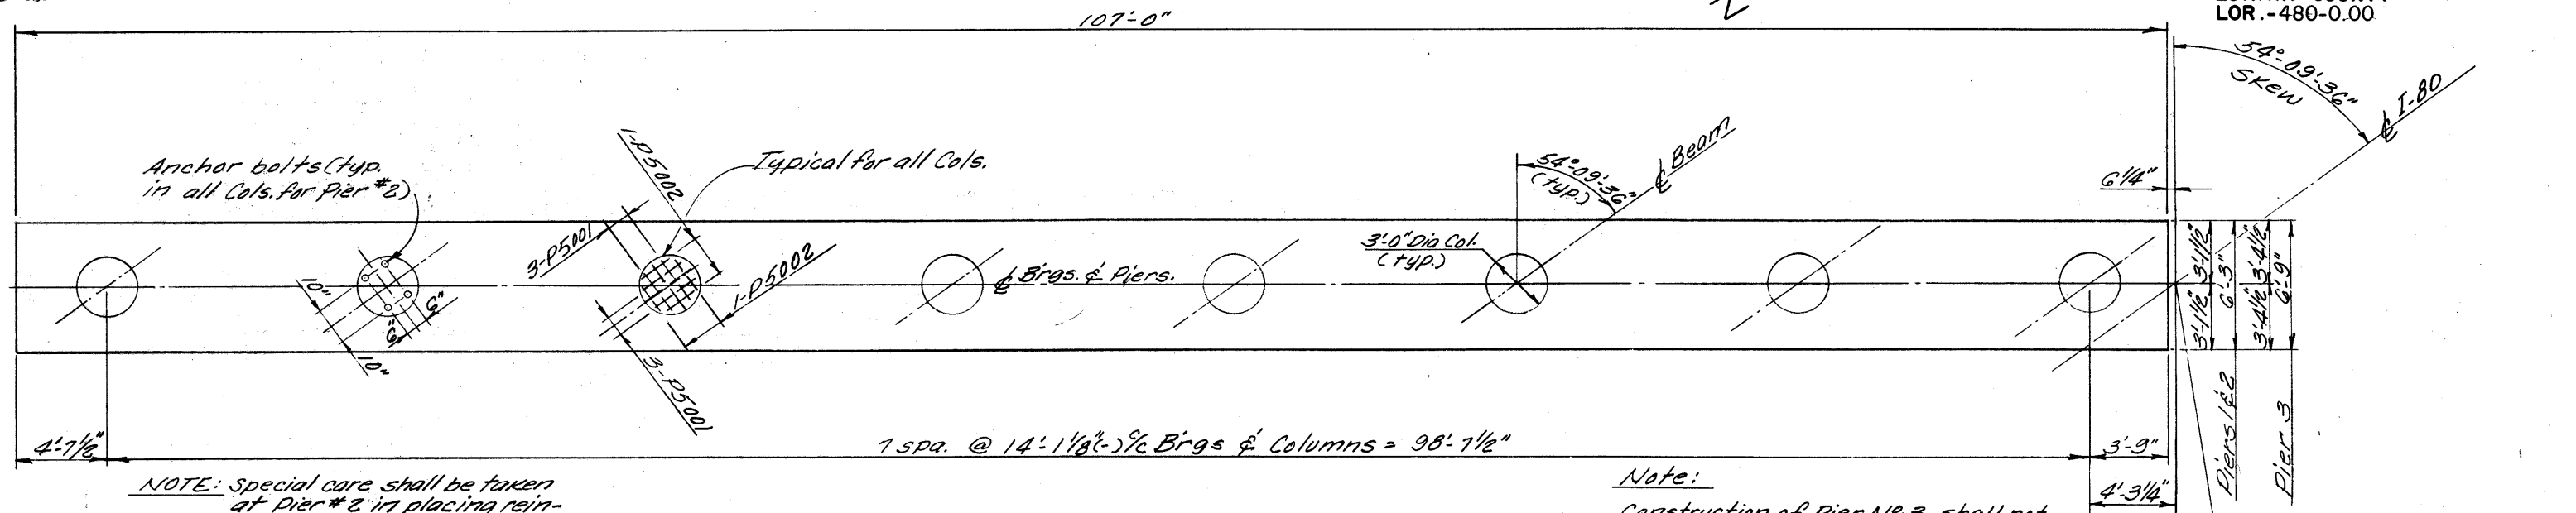

NOTE: Special care shall be taken at Pier #2 in placing reinforcing steel in top of column so as to avoid interference with the drilling of anchor bar holes or the pre-setting of bearing anchors.

PLAN

Note:

Construction of Pier No. 3 shall not commence until roadway embankment has been completed to subgrade elevation.


& Brgs. Pier #1 Sta. 93+43.98
& Brgs. Pier #2 Sta. 94+16.13
& Brgs. Pier #3 Sta. 94+89.48

Bearing Anchors: At the option of the Contractor, bearing anchors (or formed holes), located and supported by templates, may be cast in place.

P-5001 or P-5002

	EL. A	EL. B	EL. C	EL. D	EL. E	EL. F	EL. G	EL. H	EL. J
Pier No. 1	785.55	785.72	785.89	786.06	786.22	786.20	786.10	785.99	762.08
Pier No. 2	785.07	785.27	785.46	785.65	785.83	785.83	785.75	785.67	761.08
Pier No. 3	784.68	784.90	785.11	785.32	785.53	785.54	785.48	785.42	759.08

TABLE OF ELEVATIONS

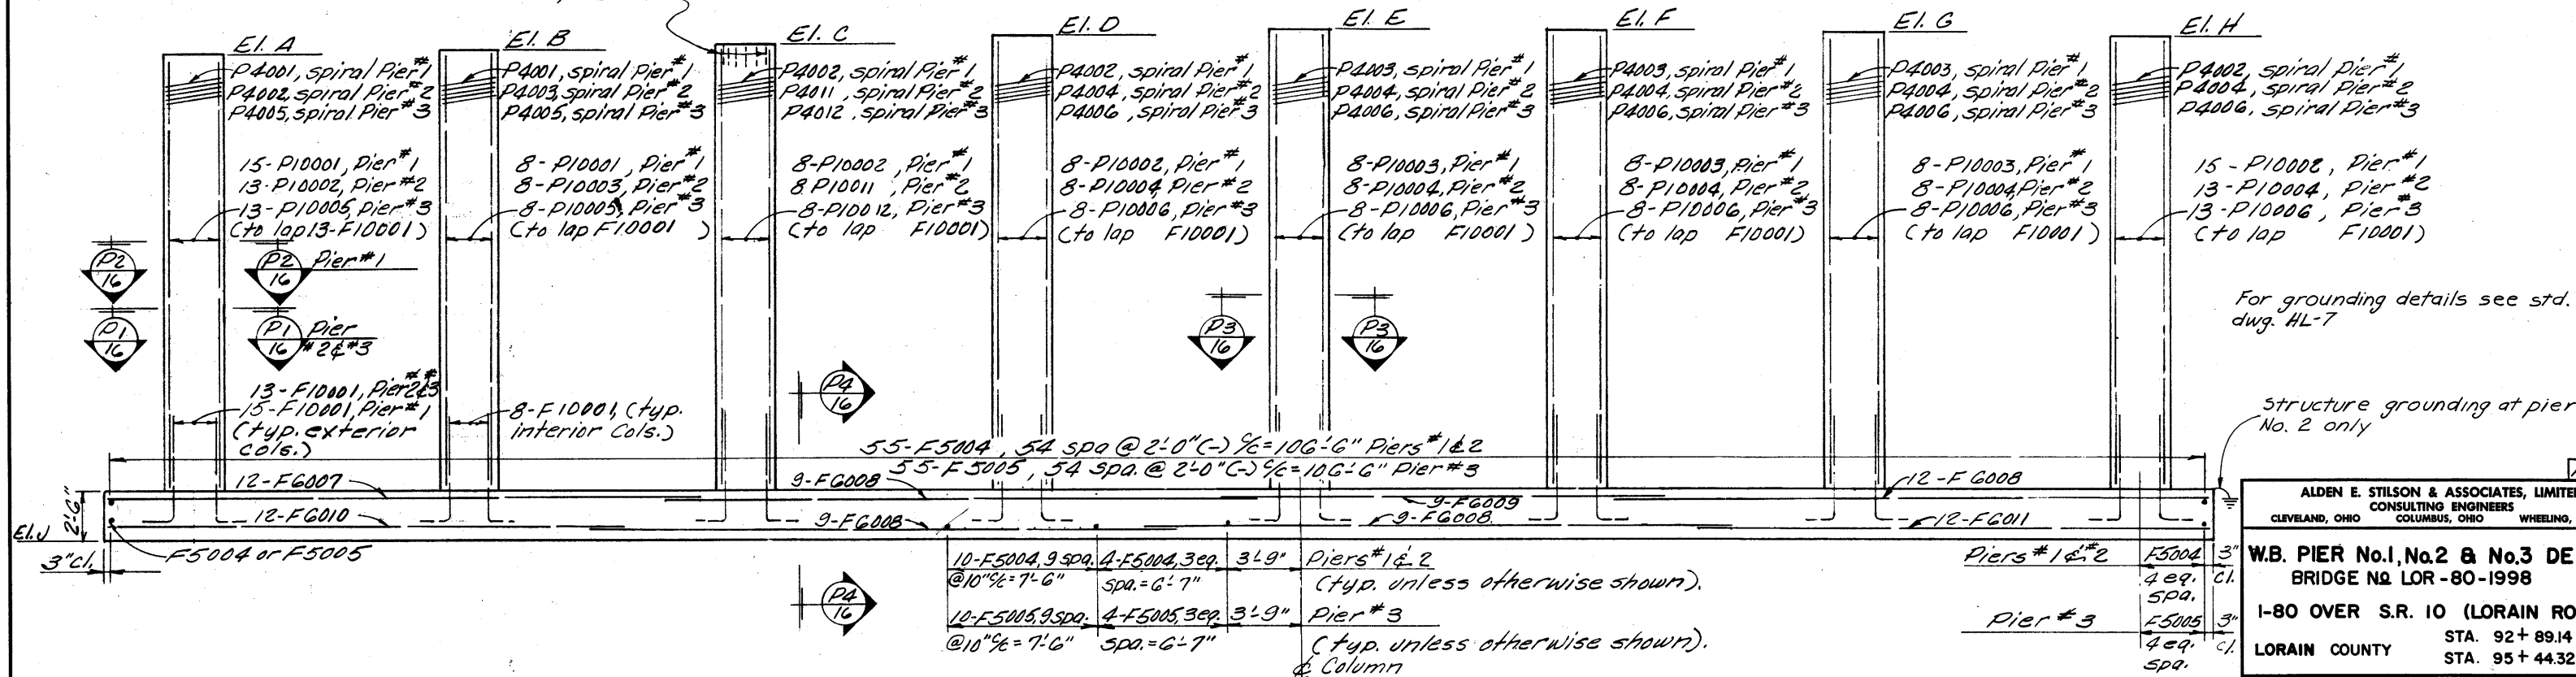


ELEVATION


ALDEN E. STILSON & ASSOCIATES, LIMITED CONSULTING ENGINEERS CLEVELAND, OHIO COLUMBUS, OHIO WHEELING, W. VA.							
W.B. PIER No. 1, No. 2 & No. 3 DETAILS BRIDGE No. LOR-80-1998 I-80 OVER S.R. 10 (LORAIN ROAD) LORAIN COUNTY STA. 92+89.14 STA. 95+44.32							
DESIGNED	DRAWN	TRACED	CHECKED	REVIEWED	DATE	REVISED	
R.S.S.	R.T.		B.I.P.	G.W.M.	5/7/70		

LORAIN COUNTY
LOR.-480-0.00

344
375

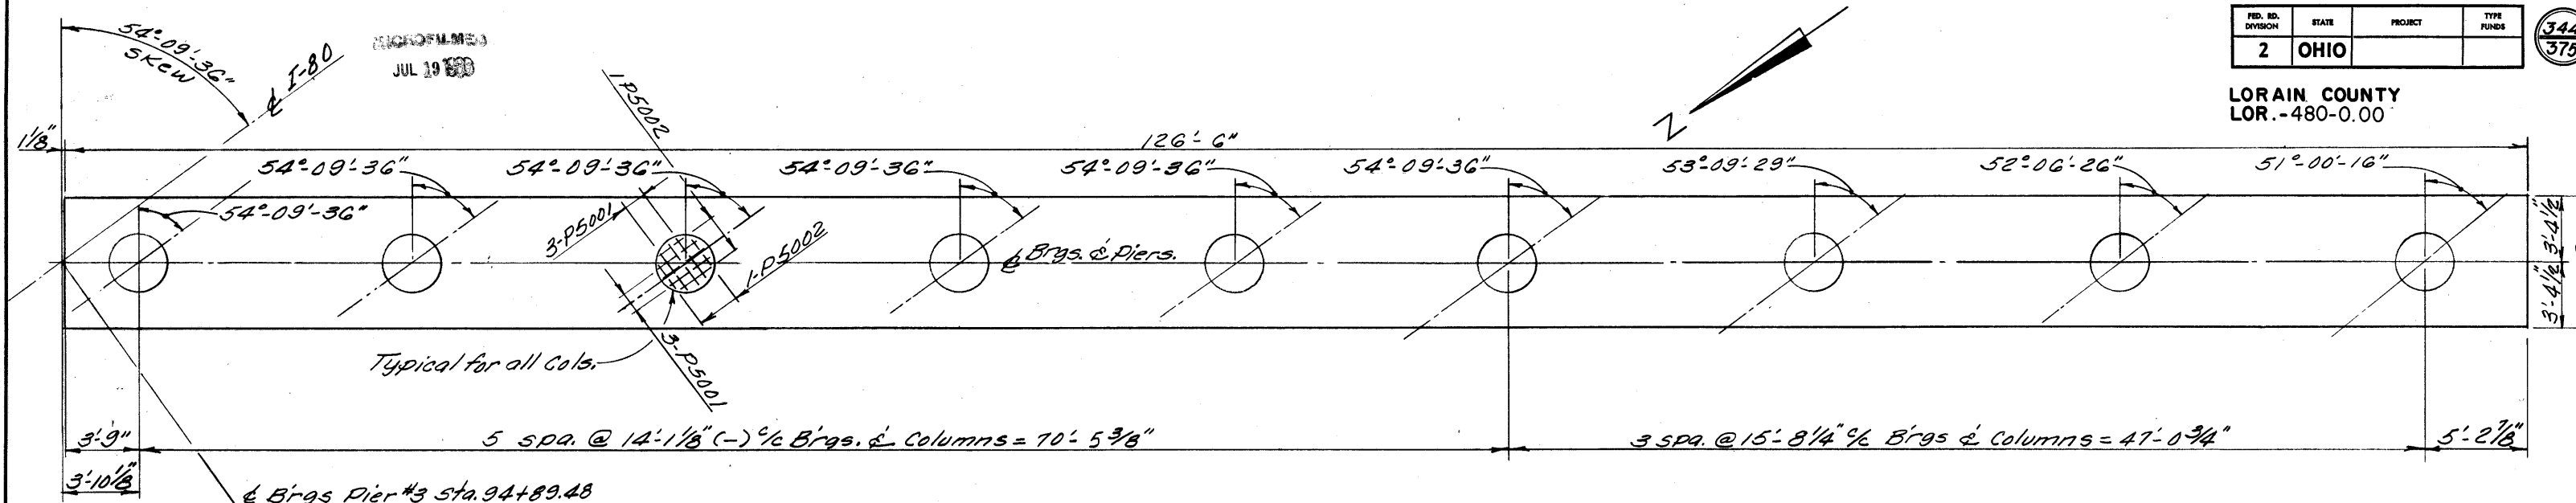

PLAN

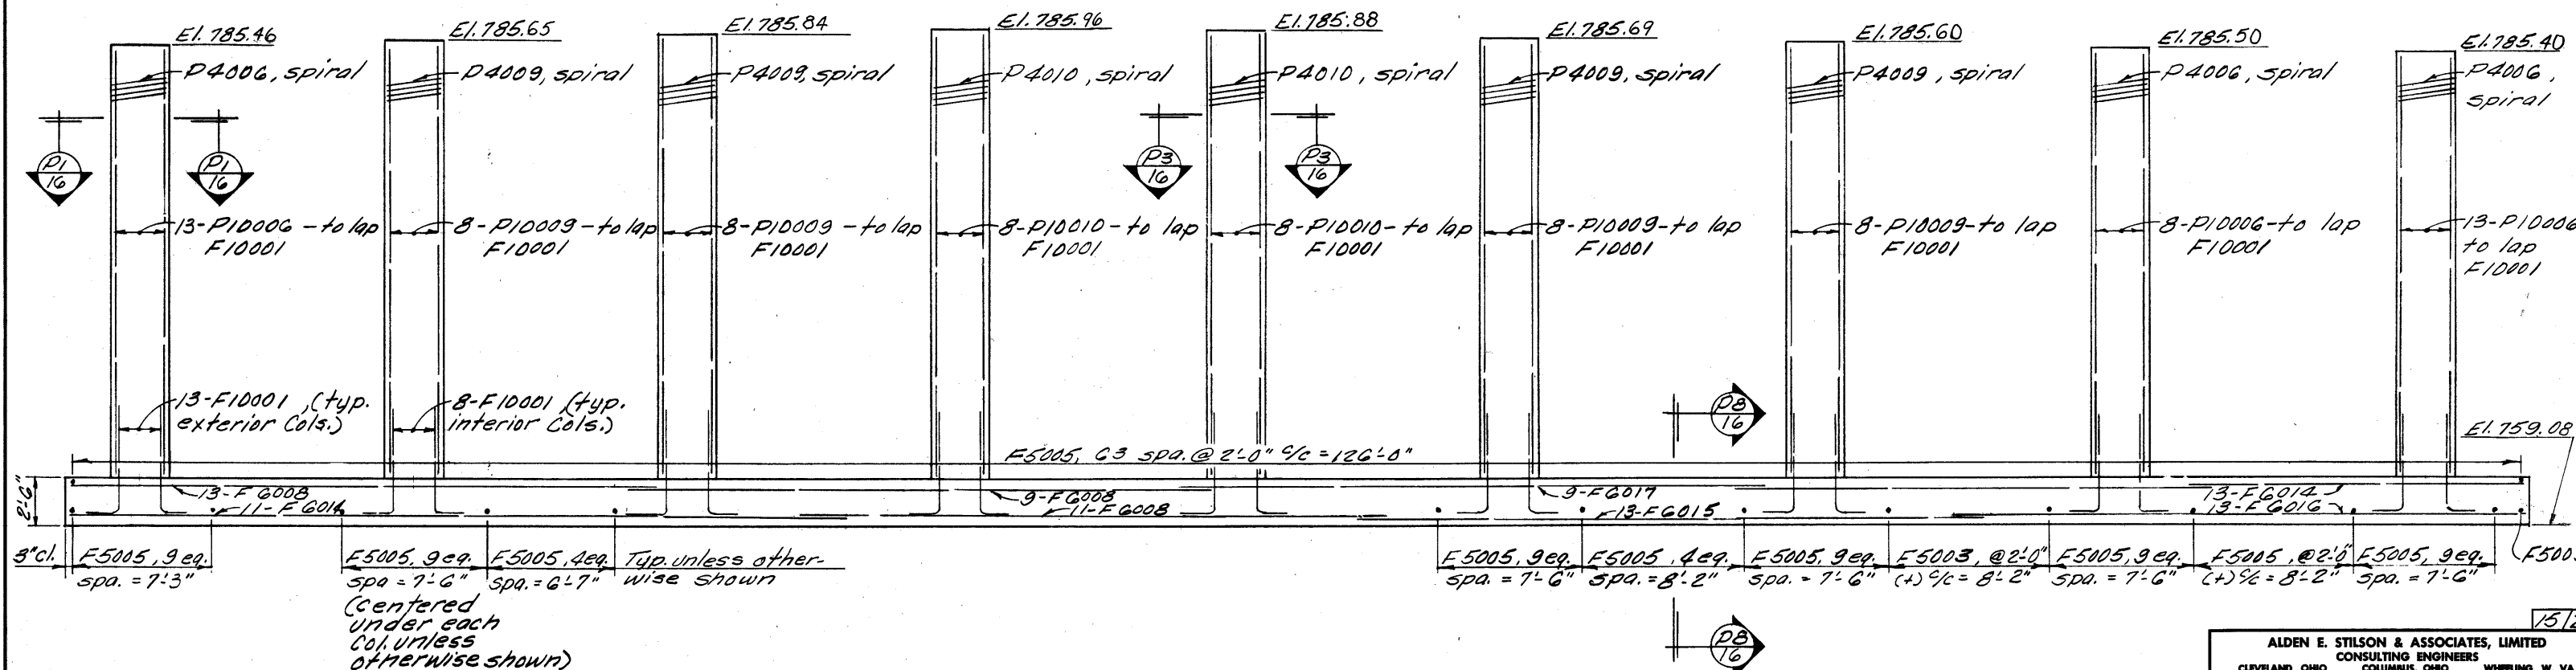

ELEVATION

1572


ALDEN E. STILSON & ASSOCIATES, LIMITED					
CONSULTING ENGINEERS					
CLEVELAND, OHIO		COLUMBUS, OHIO		WHEELING, W. VA.	
E.B. PIER No.3 DETAILS					
BRIDGE NO LOR-80-1998					
I-80 OVER S.R. 10 (LORAIN ROAD)					
LORAIN COUNTY				STA. 92+89.14	
				STA. 95+44.32	
DESIGNED	DRAWN	TRACED	CHECKED	REVIEWED	DATE
R.S.S.	R.T.		B.I.P.	G.W.M.	5/24/70

MICROFILMED
JUL 19 1980

FED. RD. DIVISION	STATE	PROJECT	TYPE FUNDS
2	OHIO		


345
375

LORAIN COUNTY
LOR-480-0.00

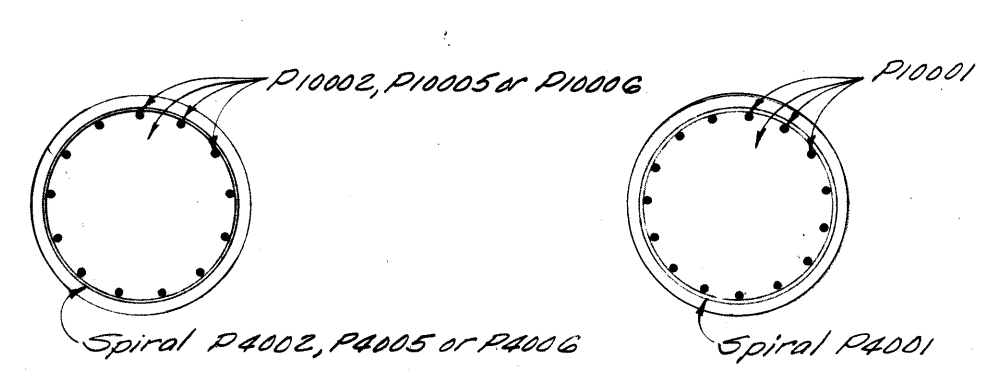

SECTION P1-P1


SECTION P2-P2

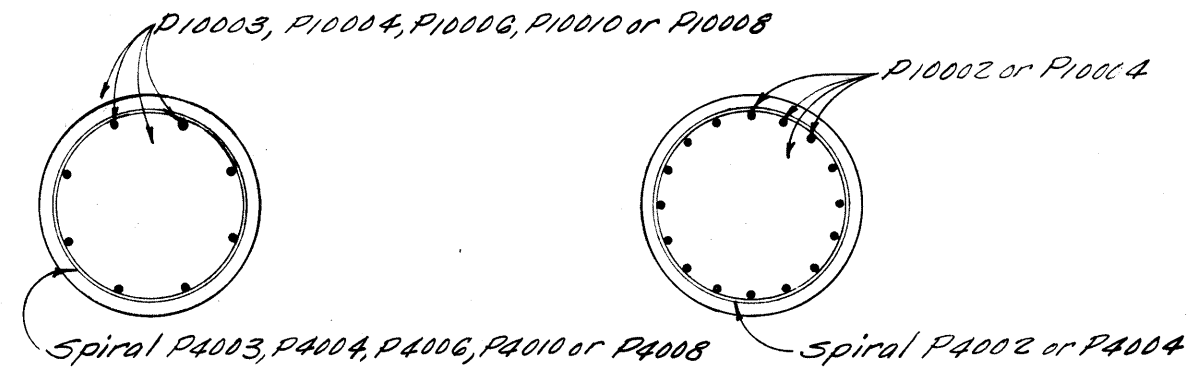


SECTION P3-P3

SECTION P5-P5


SECTION P6-P6

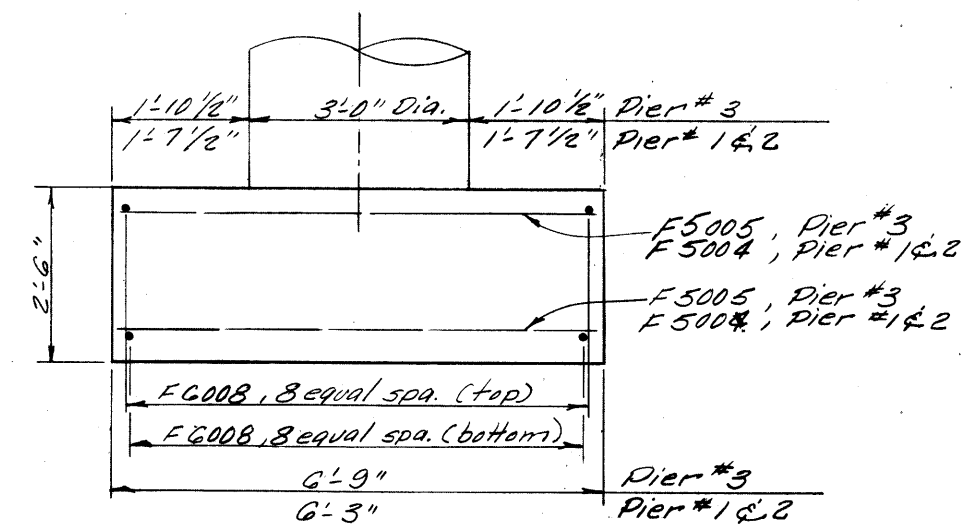

SECTION P4-P4

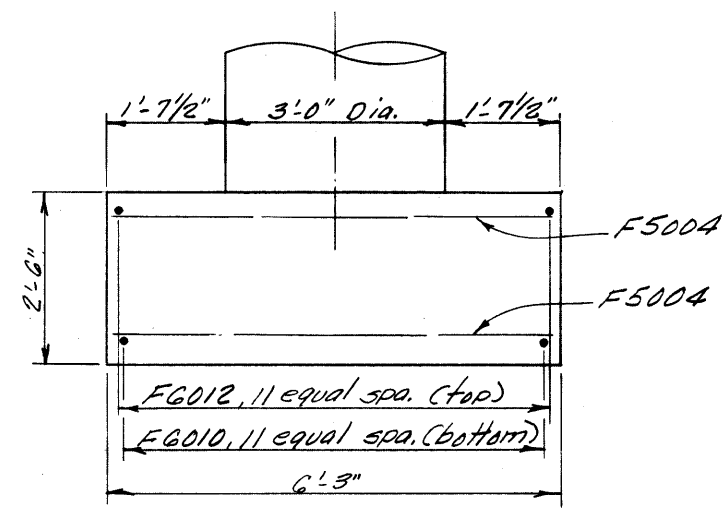

SECTION P7-P7

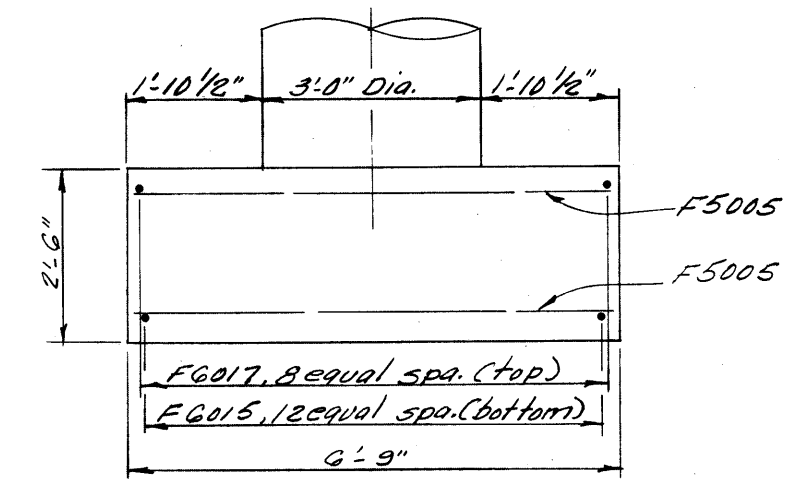


SECTION P8-P8

NOTE: Footing reinforcement shall be 3" clear from all surfaces.

ALDEN E. STILSON & ASSOCIATES, LIMITED CONSULTING ENGINEERS CLEVELAND, OHIO COLUMBUS, OHIO WHEELING, W. VA.							
PIER DETAILS BRIDGE N2 LOR-80-1998 I-80 OVER S.R. 10 (LORAIN ROAD) LORAIN COUNTY STA. 92+89.14 STA. 95+44.32							
DESIGNED	DRAWN	TRACED	CHECKED	REVIEWED	DATE	REVISION	
R.S.S.	R.T.		B.I.P.	G.W.M.	5/27/70		

LORAIN COUNTY
LOR - 480-0.00

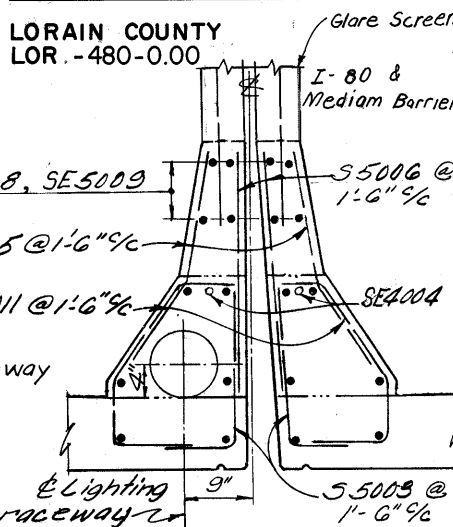


DETAIL S2


Blockout for the lighting raceway shall be increased from 4" to 8" for the first and last 3'-0" length of superstructure median to accommodate coupling and/or expansion devices.

For Detail of Glare Screen, See sh. 19/24

NOTE: Each run of longitudinal reinforcing, unless otherwise shown, shall be as follows:
Top of slab and lower part of railing and median: 8-SE4001 & 1-SE4002 lapped a min. of 1'-3"
Bottom of slab: 8-55012 & 1-55013, lapped a min. of 1'-7"

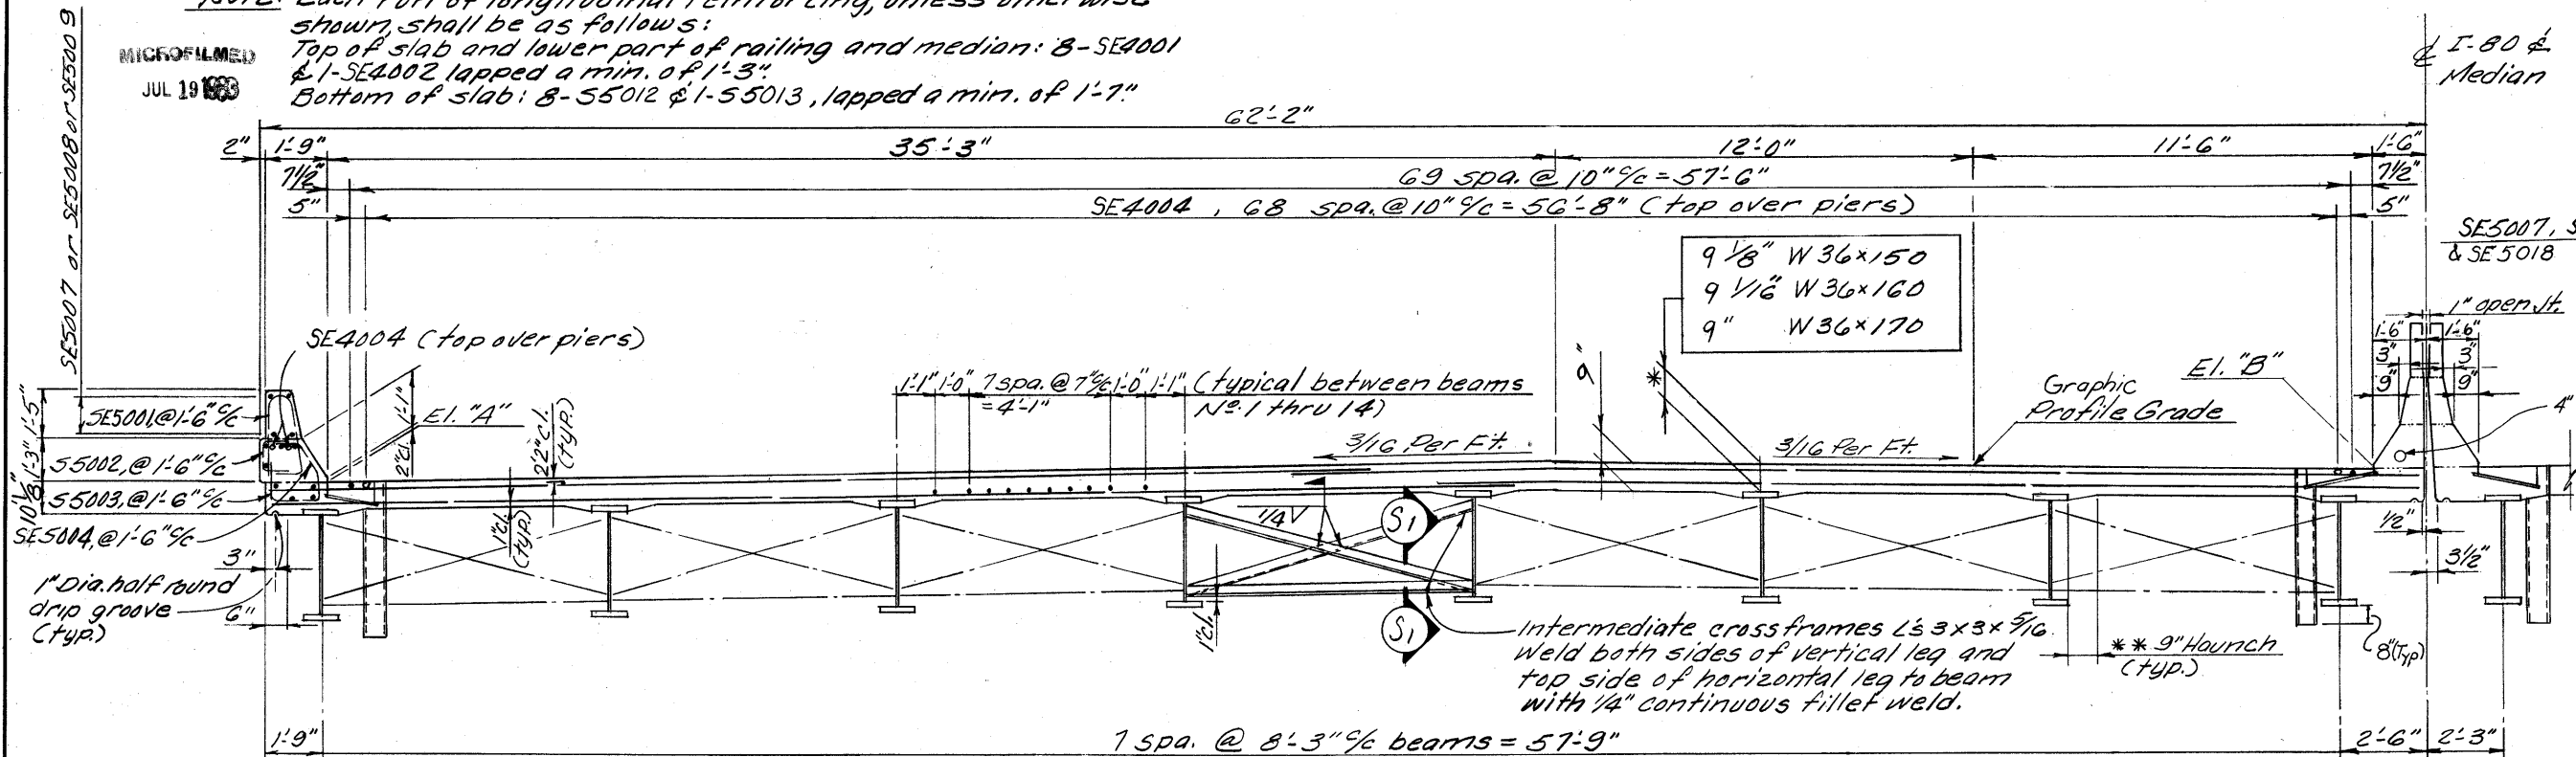

TRANSVERSE SECTION (WESTBOUND LANES)

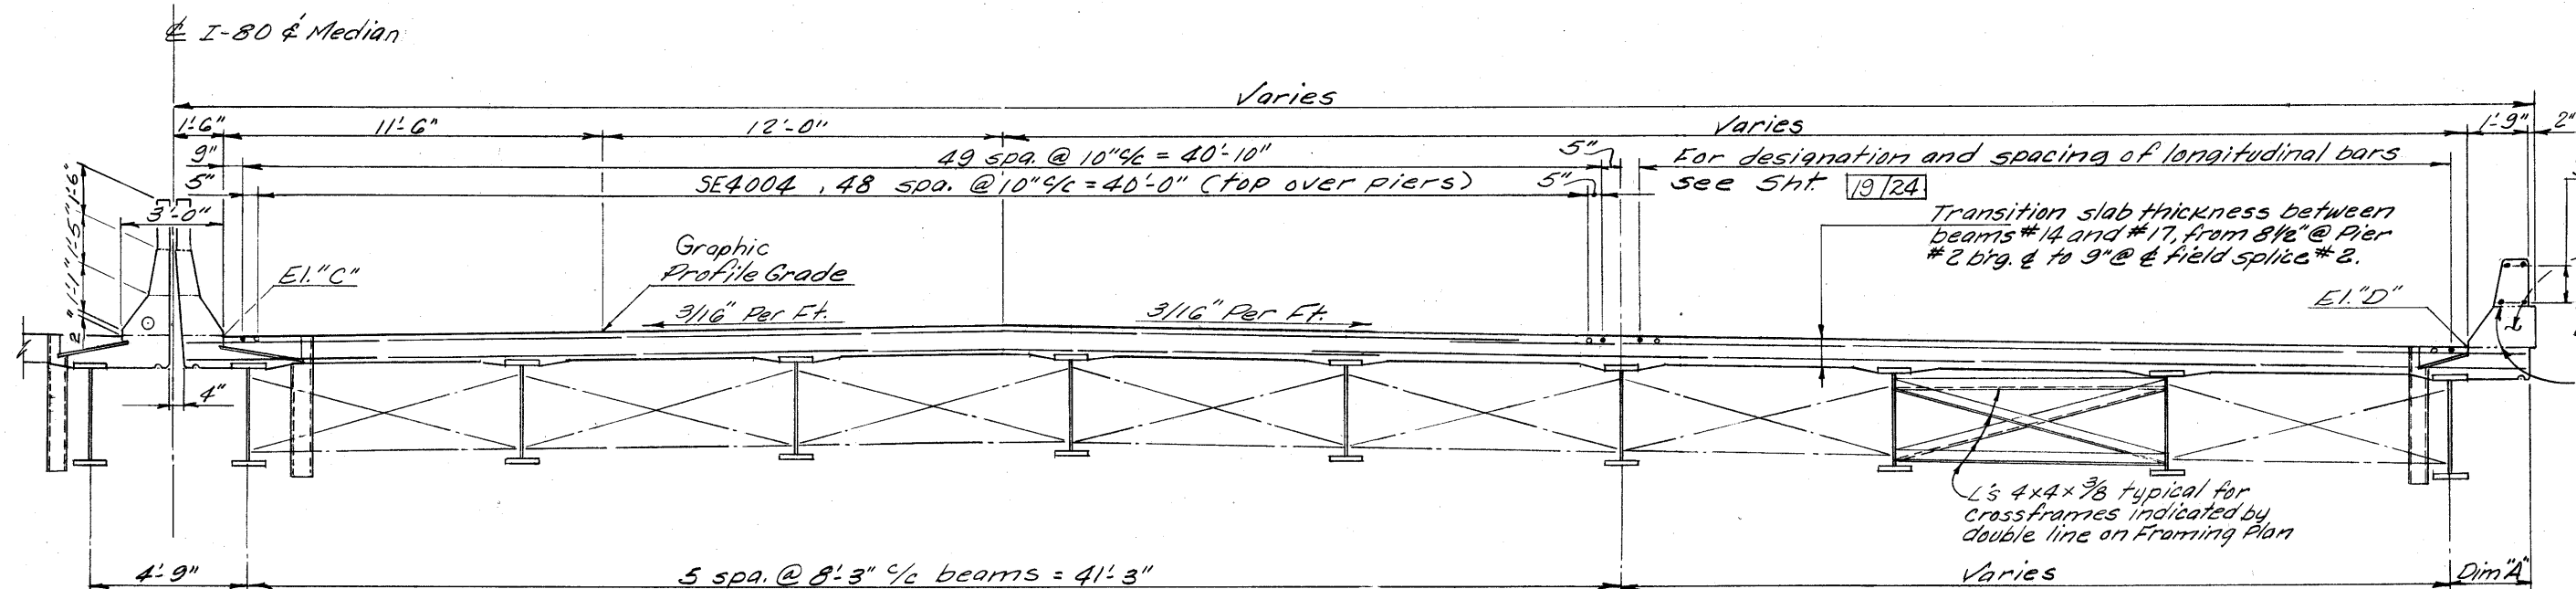

TRANSVERSE SECTION (EASTBOUND LANES)

Notes:

For scupper details see STD. DWG. SD-1-69
For End Dam details see sh. #354

* Deck slab depth: The distance shown from the top of deck slab to top of steel beam is the design dimension. The quantity of deck concrete to be paid for shall be based on this dimension, even though deviation from it may be necessary because the top flange of the beam may not have the exact camber or conformation required to place it parallel to the finished grade.


* * A haunch width of 9" shall be used for computing quantity of concrete. However, the haunch width may vary between 6" and 12" provided that the slope shall be not more than 1:4 for a haunch less than 9" in width.

For transverse slab reinforcing see sh. 18/24 & 19/24

Concrete and reinforcing steel for parapets and median barrier shall be included for payment with their respective items, Item 511 Superstructure Concrete and Item 509 reinforcing steel.

Longitudinal reinforcing steel shall be field cut as necessary to avoid interference with scuppers.

Steel Erection: During the erection of end dams and crossframes care shall be taken to insure that stringers, bearing parts and bridge seats remain in bearing contact.

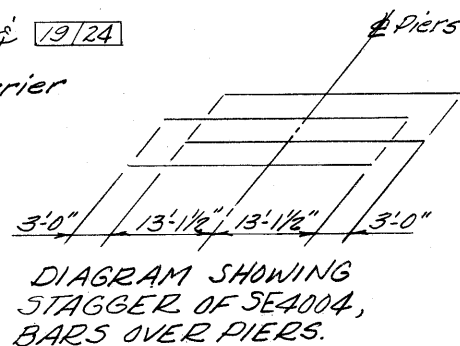

SLAB CANTILEVERS	
Location	Dim. "A"
4 Brg. W. Abut.	1'-9"
Span #2 - 0.50 Ph	1'-9 3/8"
" " 0.75 Ph	1'-11 1/8"
4 Brg. Pier #2	2'-3 7/8"
Span #3 - F.S. #2	1'-11 1/8"
" " 0.50 Ph	1'-9 3/8"
" " F.S. #3	1'-9 3/8"
4 Brg. Pier #3	1'-10 1/8"
Span #4 - 0.25 Ph	2'-0"
" " 0.50 Ph	2'-2 5/8"
" " 0.75 Ph	2'-6 3/4"
4 Brg. E. Abut.	3'-0"


ALDEN E. STILSON & ASSOCIATES, LIMITED CONSULTING ENGINEERS CLEVELAND, OHIO COLUMBUS, OHIO WHEELING, W. VA.			
SUPERSTRUCTURE DETAILS			
BRIDGE NO LOR-80-1998			
I-80 OVER S.R. 10 (LORAIN ROAD)			
LORAIN COUNTY		STA. 92 + 89.14	
		STA. 95 + 44.32	
DESIGNED	DRAWN	TRACED	CHECKED
R.S.S.	R.T.	B.I.P.	G.W.M.
			DATE 3/70

JUL 19 1980


FED. RD. DIVISION	STATE	PROJECT	TYPE FUNDS
2	OHIO		

347
375

LORAIN COUNTY
LOR - 480-0.00

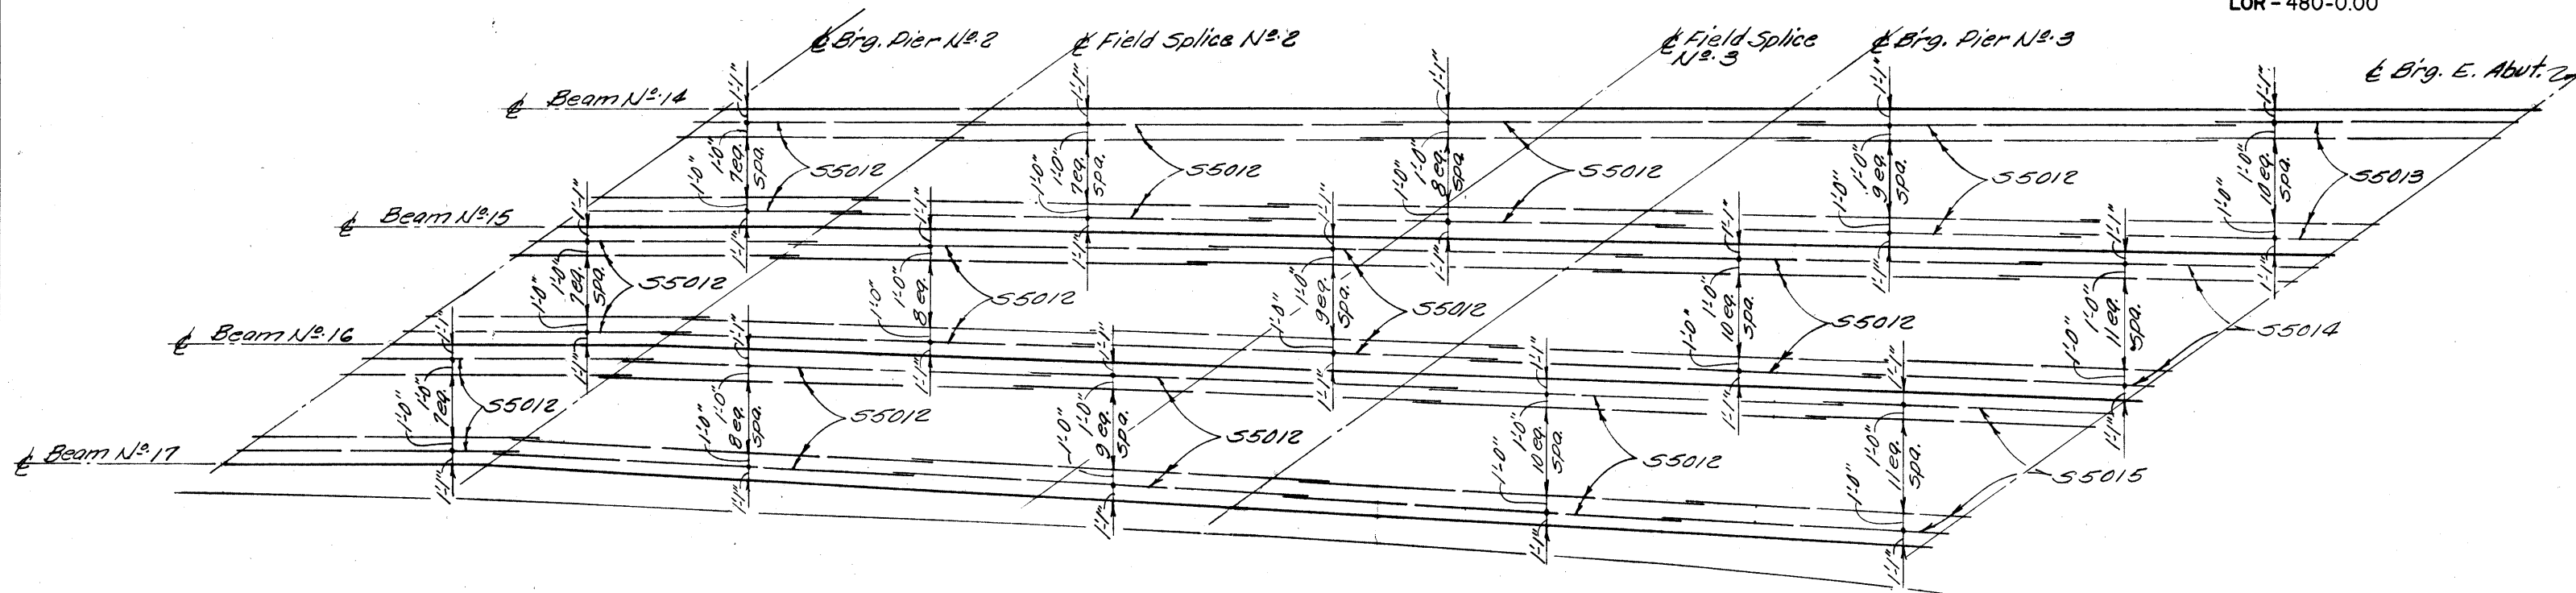

PLAN OF BOTTOM REINFORCING

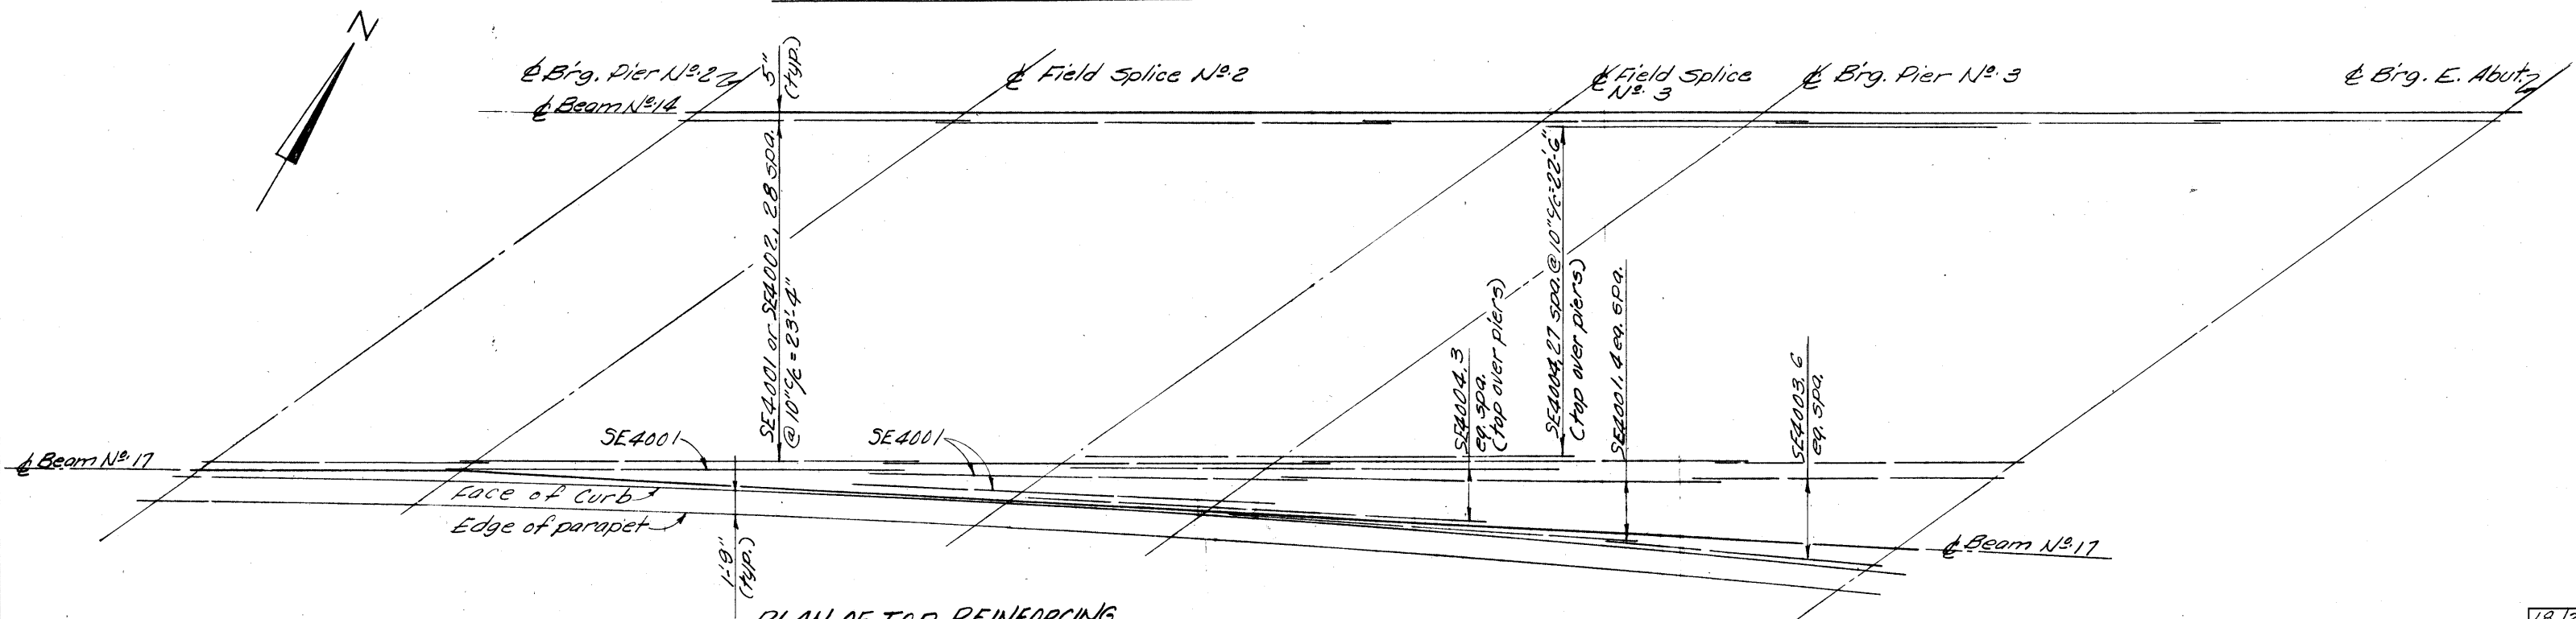

PLAN OF TOP REINFORCING

LONGITUDINAL SLAB REINFORCING (Between beams #14 thru #17)


NOTE: Each run of longitudinal reinforcing shall be as follows:
Top of slab, 8-SE4001 & 1-SE4002 or SE4003 lapped a min. of 1'-3"
Bottom of slab, 8-55012 & 1-55013, 55014 or 55015 lapped a min. of 1'-7"

ALDEN E. STILSON & ASSOCIATES, LIMITED CONSULTING ENGINEERS CLEVELAND, OHIO COLUMBUS, OHIO WHEELING, W. VA.						
SUPERSTRUCTURE DETAILS						
BRIDGE NO LOR-80-1998						
I-80 OVER S.R. 10 (LORAIN ROAD)						
LORAIN COUNTY				STA. 92+89.14		
				STA. 95+44.32		
DESIGNED	DRAWN	TRACED	CHECKED	REVIEWED	DATE	REVISED
R.S.S.	R.T.		J.P.P.	G.W.M.	5/23/70	



SE 7001 (Top), 57001 (Bott.)
7 spq. @ 10" = 5-10"

FED. RD. DIVISION	STATE	PROJECT	TYPE FUNDS
2	OHIO		

LORAIN COUNTY
LOR. - 480-0.00

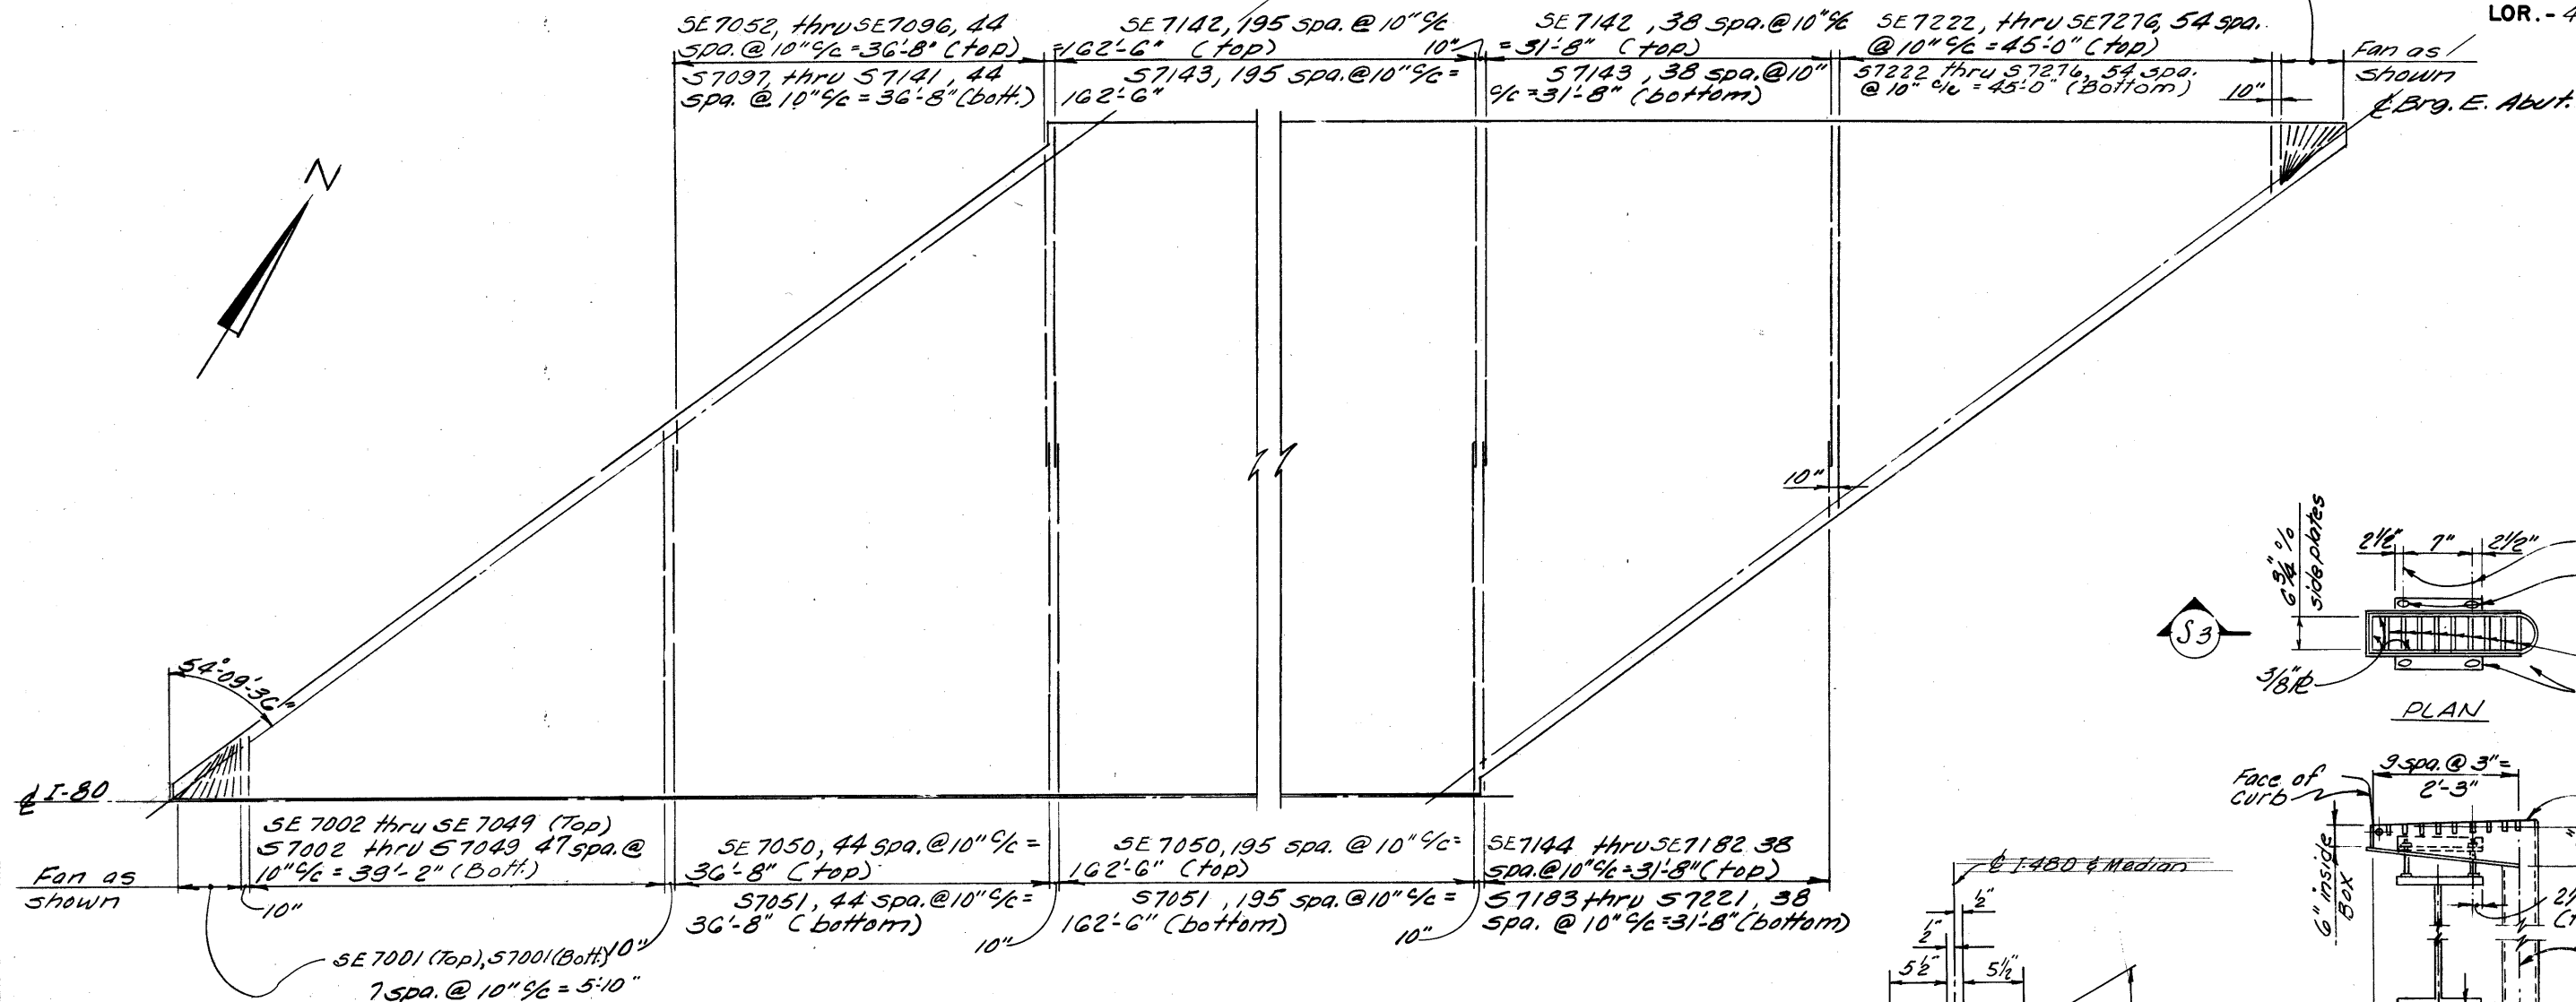


Note: Transverse slab reinforcing bars shall be placed normal to ϕ of I-80 except at acute corner of slab.

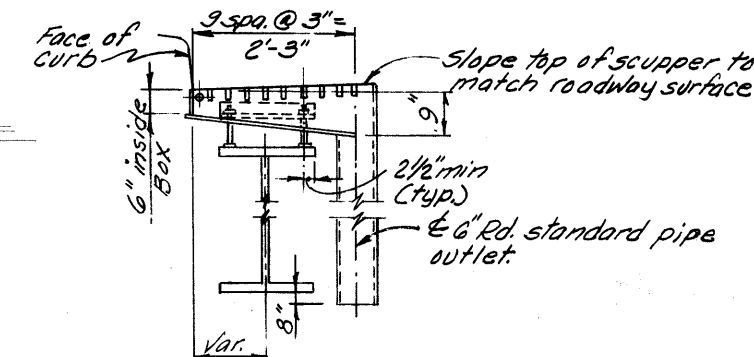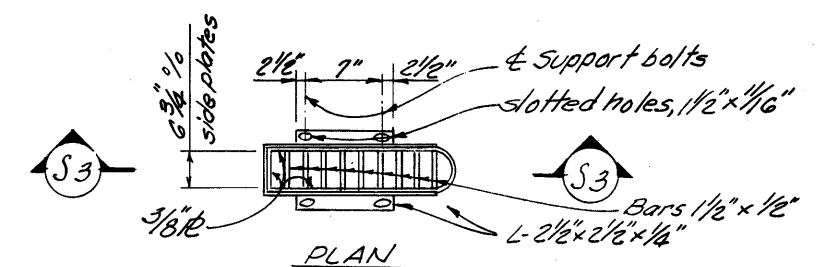

SECTION 53-53
TYPE 3 SCUPPER DETAIL

Notes. For additional scupper details
see Std. Dwg. SD-1-69 Sht. 3

For scupper spacing see General
Plan Sht. 3/24

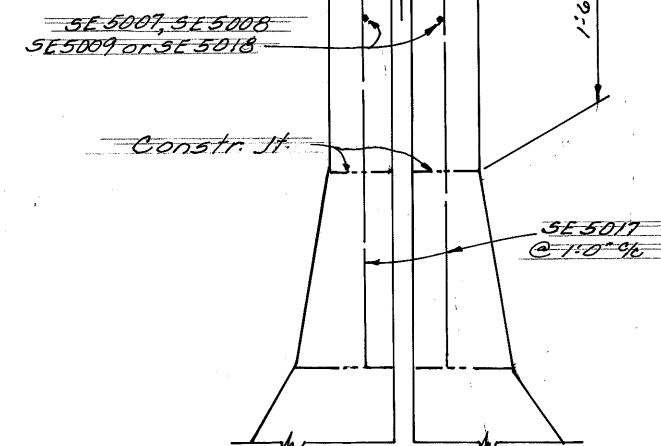

MEDIAN BARRIER WITH GLARE SCREEN

1312

ALDEN E. STILSON & ASSOCIATES, LIMITED
CONSULTING ENGINEERS
 CLEVELAND, OHIO COLUMBUS, OHIO WHEELING, W. VA.

SUPERSTRUCTURE DETAILS
BRIDGE No. LOR-80-1998
I-80 OVER S.R. 10 (LORAIN ROAD)
LORAIN COUNTY

DESIGNED	DRAWN	TRACED	CHECKED	REVIEWED	DATE	REVISED
R.S.S.	R.T.		B.I.P.	G.W.M.	7/29/77	

DATE OF MEASUREMENT
JUL 19 1980

FED. RD. DIVISION	STATE	PROJECT	TYPE FUNDS
2	OHIO		

349
375

LORAIN COUNTY
LOR.-480-0.00

SE 7001 (Top); 57001 (Bottom)
7 spa. @ 10" = 5'-10"
Fan as shown

N

SE 7331 thru
SE 7383, 52 spa. @ 10"
9" = 43'-4" (Top)

57384, thru
57436, 52 spa. @ 10"
9" = 43'-4" (Bottom)

SE 7437, 38 spa. @
10" 9" = 31'-8" (Top)

57438, 38 spa. @
10" 9" = 31'-8" (Bottom)

9" SE 7437, 150 spa. @ 9" 9" = 112'-6" (Top)

57438, 150 spa. @ 9" 9" = 112'-6" (Bottom)

9" SE 7437, 62 spa. @ 9" 9" =
46'-6" (Top)

57438, 62 spa. @ 9" 9" =
46'-6" (Bottom)

SE 7595, thru SE 7651, 56 spa.
@ 10" 9" = 46'-8" (Top); 57595
thru 57651 (Bottom)

I-80

59° 09' 36"

Br. E. Abut.

9"

SE 7277 thru SE 7328 (Top)

57277 thru 57328 (Bottom)
51 spa. @ 10" 9" =

SE 7329, 52 spa. @ 10" 9" =
43'-4" (Top)

57330, 52 spa. @ 10" 9" =
43'-4" (Bottom)

SE 7329, 38 spa. @ 10" 9" =
31'-8" (Top)

57330, 38 spa. @
10" 9" = 31'-8" (Bottom)

SE 7439, 62 spa. @ 9" 9" = 46'-6" (Top)

57439, 62 spa. @ 9" 9" = 46'-6" (Bottom)

SE 7469, thru SE 7531, 62 spa.
@ 9" 9" = 46'-6" (Top)

57532, thru 57594,
62 spa. @ 9" 9" = 46'-6" (Bottom)

SE 7001 (Top) 57001
(Bottom) 7 spa. @ 10" = 5'-10"
(Fan as shown)

SE 7454, 62 spa. @ 9" 9" = 46'-6" (Top)

57454, 62 spa. @ 9" 9" = 46'-6" (Bottom)

Note: X = 9 spa. @ 9" 9" = 6'-9"


TRANSVERSE SLAB REINFORCING (EAST BOUND LANES)

Note: Transverse slab reinforcing bars shall be placed normal
to I-80 except at acute corner of slab.

20/24


12012

ALDEN E. STILSON & ASSOCIATES, LIMITED					
CONSULTING ENGINEERS					
CLEVELAND, OHIO		COLUMBUS, OHIO		WHEELING, W. VA.	
SUPERSTRUCTURE DETAILS					
BRIDGE NO LOR-80-1998					
I-80 OVER S.R. 10 (LORAIN ROAD)					
LORAIN COUNTY			STA. 92 + 89.14		
			STA. 95 + 44.32		
DESIGNED	DRAWN	TRACED	CHECKED	REVIEWED	DATE
R.S.S.	D.T.		B.I.P.	G.W.M.	5/70

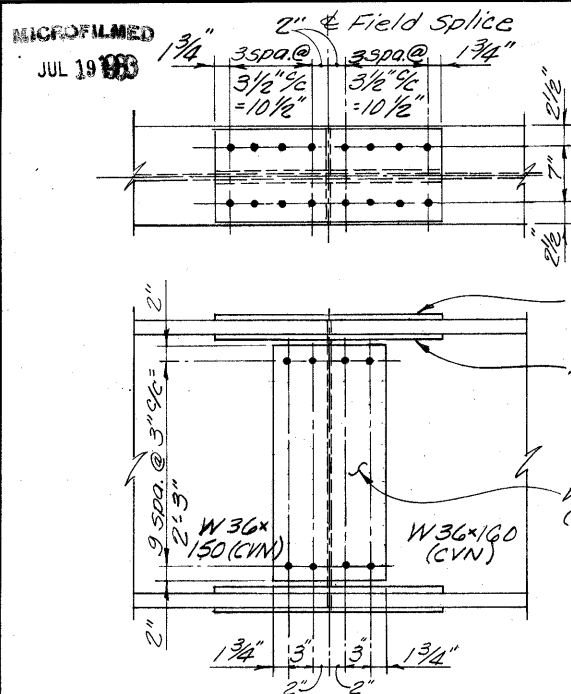

FIELD SPLICE DETAIL
FIELD SPLICE NO. 1, BEAM NO. 1 THRU 17
FIELD SPLICE NO. 3, BEAM NO. 1 THRU 13

End Crossframes
4x4x5/16 (T4P)

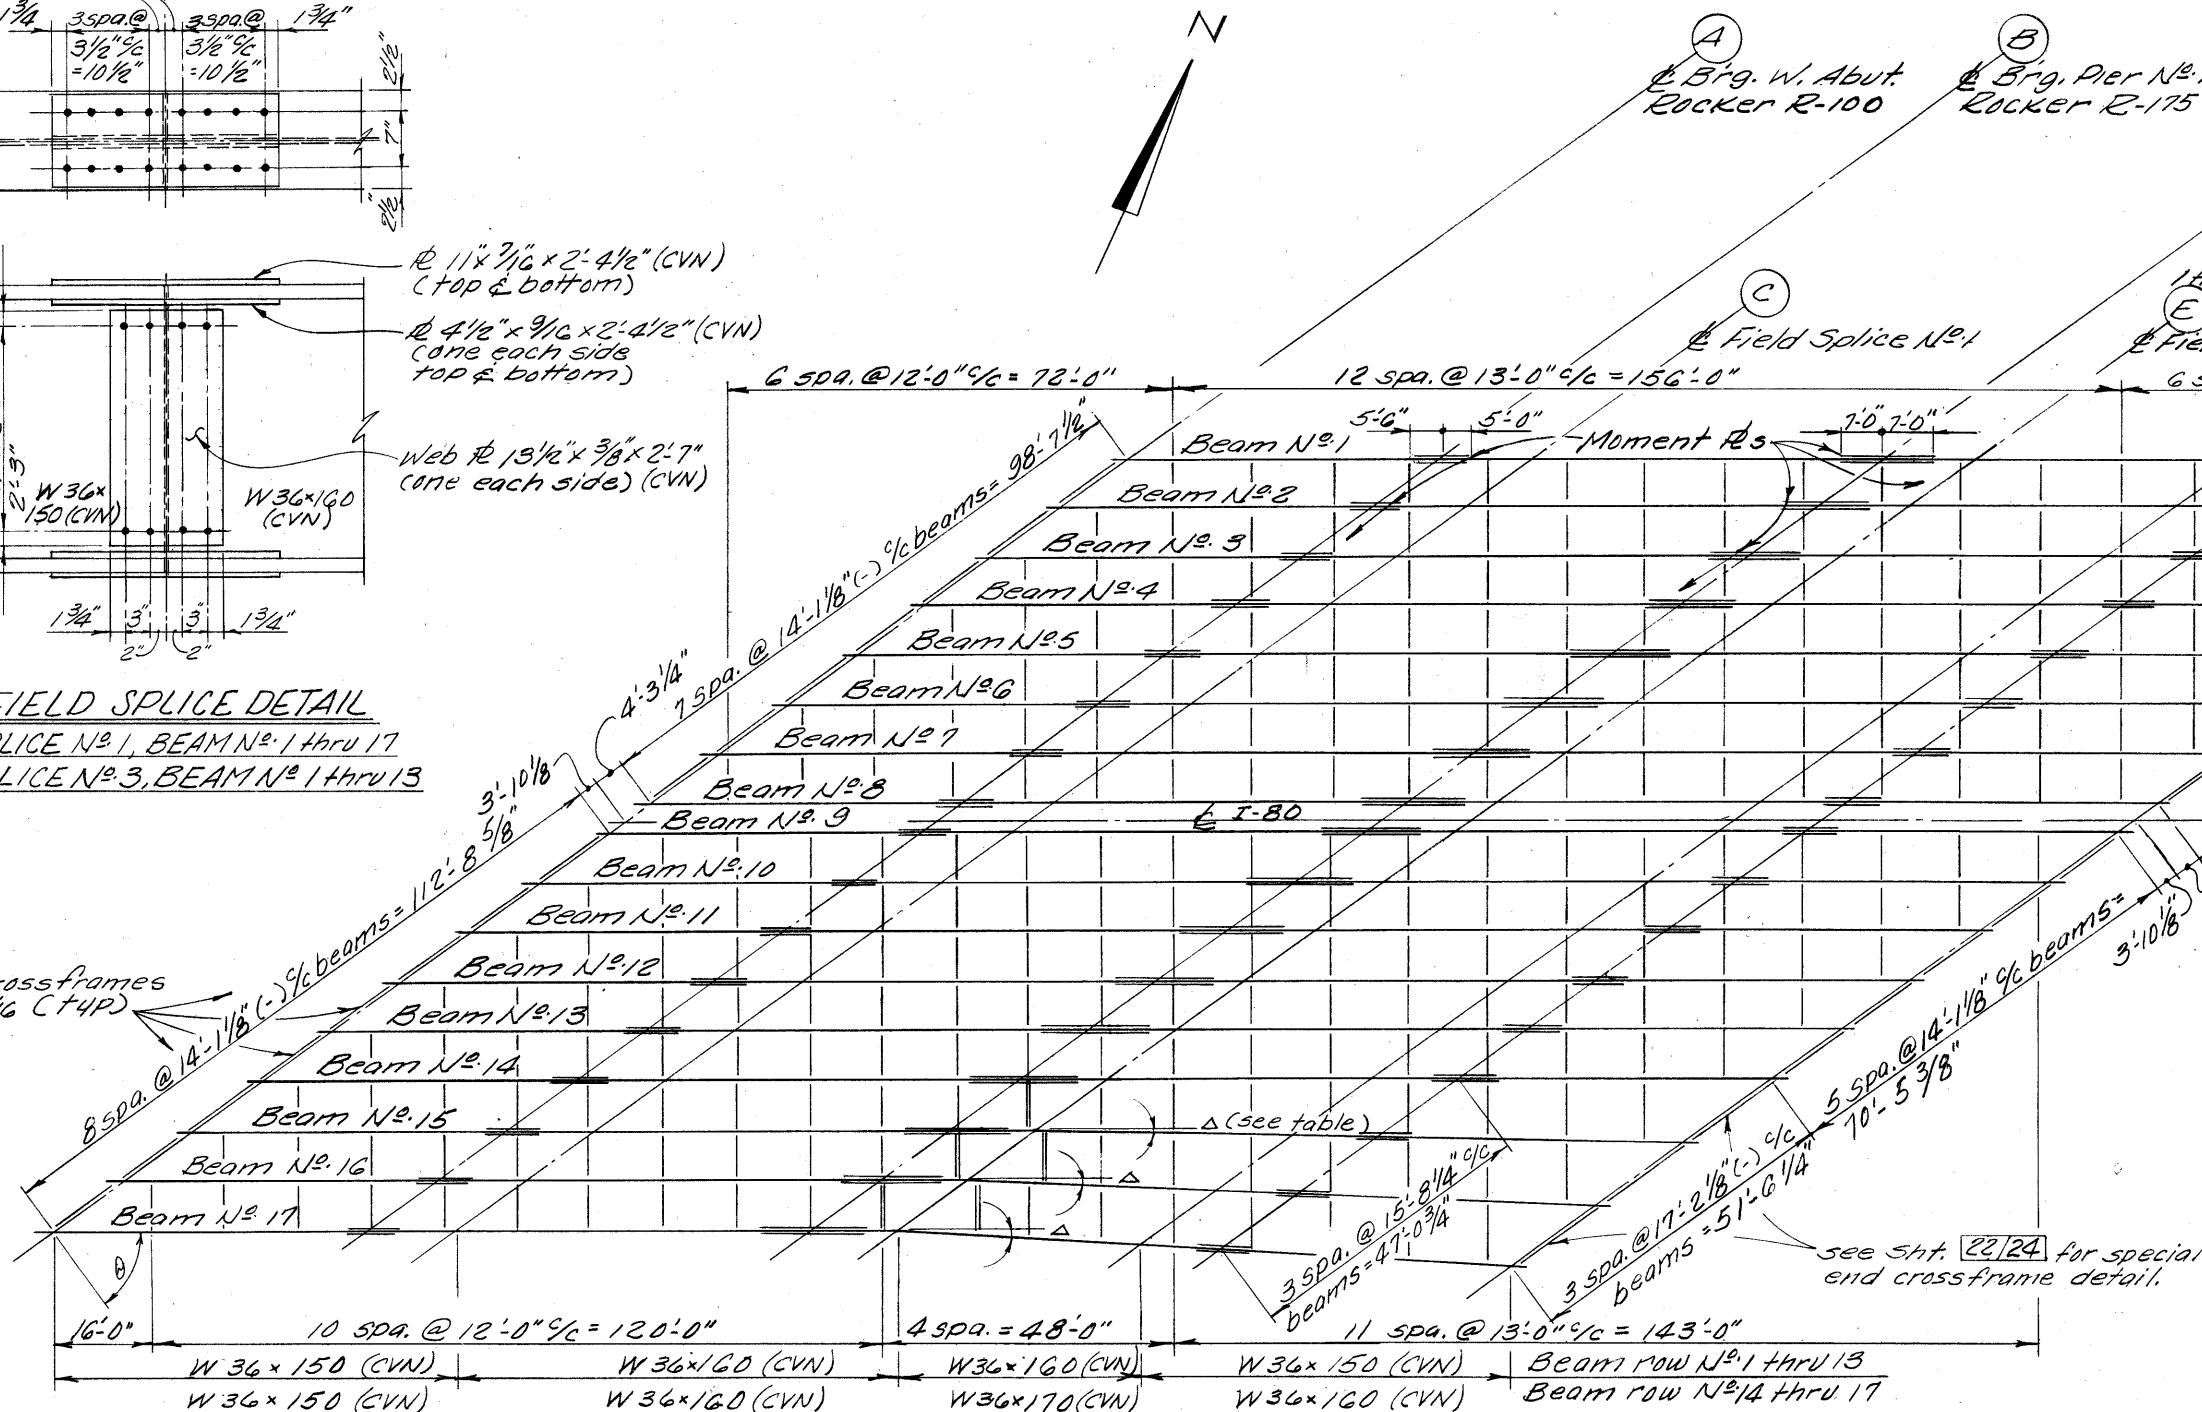

FRAMING PLAN

Notes:
1\"/>

Crossframes may be shifted if necessary to avoid field splice.

Crossframes shall be placed normal to beam lines 1 thru 16

TABLE OF MOMENT R _e SIZES			
Location	Beam No.	Top R _e	Bot R _e
Pier No. 1	1 thru 17	10 1/2 x 7 1/16	13 1/2 x 1/2
Pier No. 2	1 thru 17	10 1/2 x 7 1/16	13 1/2 x 1/2
Pier No. 3	1 thru 13	10 1/2 x 7 1/16	13 1/2 x 1/2
Pier No. 3	14 thru 17	10 1/2 x 1/2	13 1/2 x 1/2

Top Moment Plates shall be (CVN)

TABLE OF DEFLECTION ANGLES & BEAM LENGTHS

		Beam Row No. 1 thru 14	Beam Row No. 15	Beam Row No. 16	Beam Row No. 17
A	Length	54'-09'-36"	54'-09'-36"	54'-09'-36"	54'-09'-36"
	Δ	51'-0"	51'-0"	51'-0"	51'-0"
B	Length	00'-00'-00"	00'-00'-00"	00'-00'-00"	00'-00'-00"
	Δ	14'-6"	14'-6"	14'-6"	14'-6"
C	Length	00'-00'-00"	00'-00'-00"	00'-00'-00"	00'-00'-00"
	Δ	58'-3"	58'-3"	58'-3"	58'-3"
D	Length	00'-00'-00"	00'-00'-00"	00'-00'-00"	00'-00'-00"
	Δ	18'-0"	18'-0"	18'-0"	18'-0"
E	Length	00'-00'-00"	01'-00'-07"	02'-03'-10"	03'-09'-20"
	Δ	40'-3"	39'-3 1/16"	38'-4 1/2"	37'-5 1/16"
F	Length	00'-00'-00"	00'-00'-00"	00'-00'-00"	00'-00'-00"
	Δ	14'-6"	14'-1 15/16"	13'-9 7/8"	13'-5 5/16"
G	Length	00'-00'-00"	00'-00'-00"	00'-00'-00"	00'-00'-00"
	Δ	51'-0"	49'-9 5/8"	48'-7 7/16"	47'-5 1/2"
H	Length	54'-09'-36"	53'-09'-29"	52'-06'-26"	51'-00'-16"
	Δ				


Note: For Field Splice No. 2
Beam No. 1 thru 13 see
Std Dwg. 5 D-1-69
Sht. 4 of 4

ALDEN E. STILSON & ASSOCIATES, LIMITED
CONSULTING ENGINEERS
CLEVELAND, OHIO COLUMBUS, OHIO WHEELING, W. VA.

SUPERSTRUCTURE DETAILS
BRIDGE NO. LOR-80-1998
I-80 OVER S.R. 10 (LORAIN ROAD)


LORAIN COUNTY STA. 92+89.14
STA. 95+44.32

DESIGNED: R.S.S. DRAWN: R.T. TRACED: B.I.P. CHECKED: G.W.M. REVIEWED: DATE: 2/10

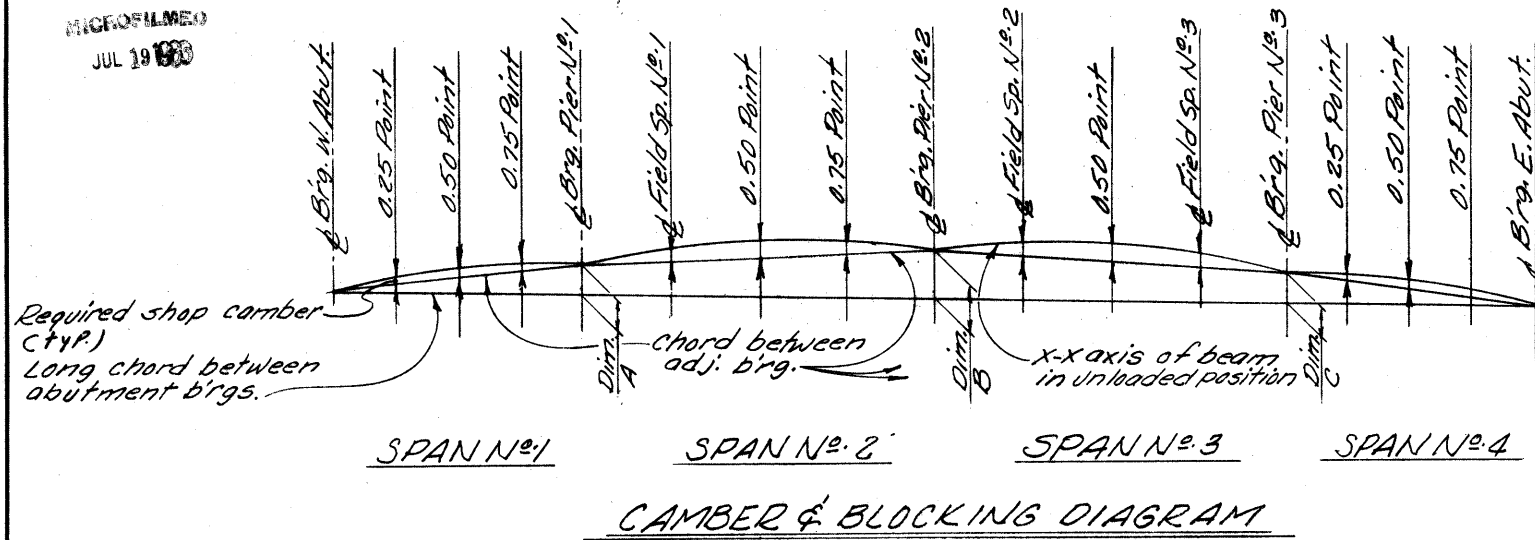

DEFLECTION AND CAMBER												
Location	SPAN N ^o 1			SPAN N ^o 2			SPAN N ^o 3			SPAN N ^o 4		
	0.25	0.50	0.75	F.S.*1	0.50	0.75	F.S.*2	0.50	F.S.*3	0.25	0.50	0.75
Deflection due to weight of steel	1/16	1/16	0	1/16	1/8	1/16	1/16	1/8	1/16	0	1/16	1/16
Deflection due to remaining dead load	3/16	3/16	1/16	3/16	3/8	3/16	3/16	3/8	3/16	1/16	3/16	3/16
Adjust req'd. for Vertical Curve	1/16	1/8	1/16	1/8	1/4	3/16	3/16	1/4	1/8	1/16	1/8	1/16
Required shap camber	5/16	3/8	1/8	3/8	3/4	7/16	1/16	3/4	3/8	1/8	3/8	5/16


BLOCKING DIMENSIONS			
Beam No.	Dim. A	Dim. B	Dim. C
1 thru 14	1 9/16	2 3/8	1 9/16
15	1 9/16	2 7/16	1 9/16
16	1 5/8	2 9/16	1 5/8
17	1 1/16	2 1/16	1 1/16

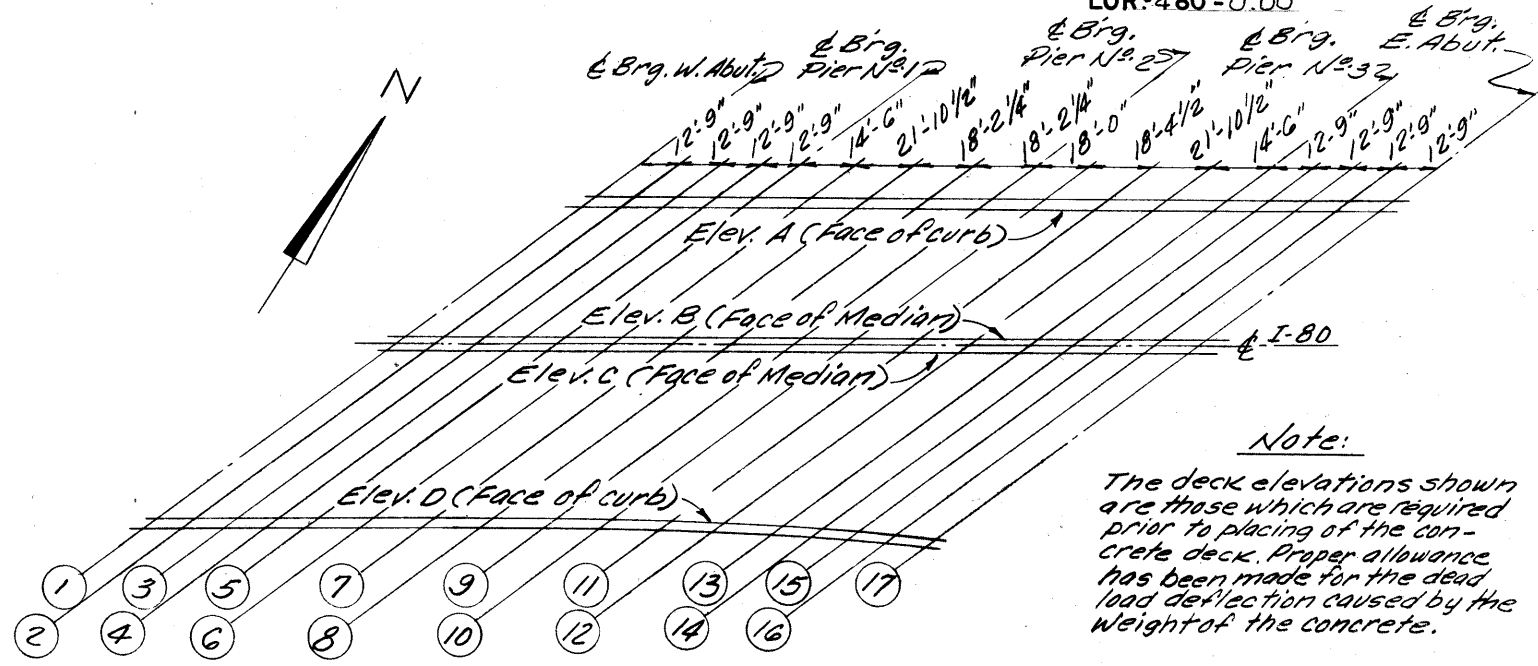

DECK ELEVATIONS

See Transverse Section sht. 17/24 for Elev. locations.

TABLE OF DECK ELEVATIONS																	
LINE	1	2	3	4	5	6	7	8	9	10	11	12	13	14	15	16	17
ELEV. A	790.79	790.76	790.72	790.66	790.61	790.56	790.47	790.36	790.24	790.14	790.03	789.86	789.72	789.64	789.54	789.43	789.30
ELEV. B	791.10	791.10	791.09	791.06	791.03	791.01	790.97	790.90	790.82	790.76	790.68	790.56	790.46	790.39	790.32	790.23	790.13
ELEV. C	791.12	791.12	791.10	791.08	791.05	791.03	790.99	790.93	790.85	790.79	790.73	790.60	790.51	790.44	790.37	790.28	790.19
ELEV. D	790.75	790.78	790.80	790.80	790.81	790.82	790.83	790.81	790.77	790.75	790.72	790.64	790.57	790.53	790.48	790.42	790.35

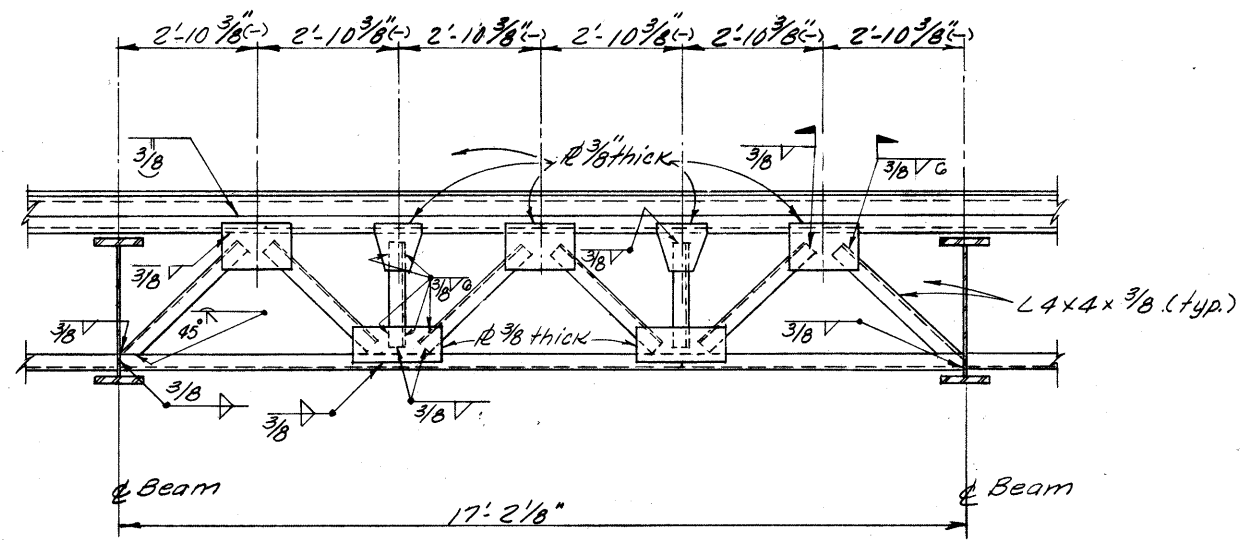

SPECIAL END CROSSFRAME

(For additional details see Std. Dwg. SD-1-69, Sht. #1)


Note:

Where "(CVN)" follows a shape or plate size designation, the material shall meet specified minimum notch toughness requirements.

SHOP DRAWINGS

After all steel fabrication is completed, the Fabricator shall furnish a 35 millimeter microfilm copy of each shop drawing mounted on a 3 1/4" x 7 3/8" aperture card. The card shall be imprinted with the bridge and project number, Fabricator's name, drawing number and details shown on the drawing (girders, beams, crossframes, etc.)

SCUPPERS: Steel bar stock utilized for scuppers may be any weldable grade of low or mild carbon steel available commercially. This material is to be excluded from the requirements of 501.07 for test reports.

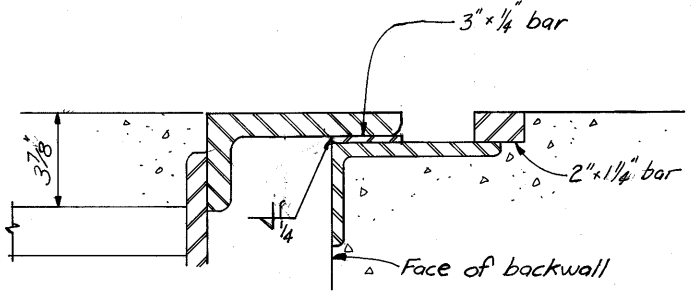

END DAM DETAIL

(See SD-1-69, sheet 1 of 4 for additional details)

NOT FILMED
JUL 19 1983

MARK	NUM.	LENGTH	WEIGHT	TYPE	A	B	C	D	E	NOTE
SUPERSTRUCTURE (CONTINUED)										
SE5010	28	6- 8	195	ST						
SE5011	342	2-11	1040	15	0- 8	0- 8	1- 1	0- 6	0- 9	
S 5012	1279	30- 0	40020	ST						
S 5013	139	21- 9	3153	ST						
S 5014	14	19- 3	281	ST						
S 5015	16	16- 9	280	ST						
S 5016	8	19- 9	165	ST						
S 7001	32	5- 6	360	ST						
S 7002	1	6- 0		ST						1
THRU			1987		VARY	LENGTH	BY	0- 7	1/ 4	
S 7049	1	34- 6		ST						1
S 7051	241	28- 2	13875	ST						
S 7097	1	9- 2		ST						1
THRU			2035		VARY	LENGTH	BY	0- 7	1/ 8	
S 7141	1	35- 1		ST						1
S 7143	235	35- 8	17132	ST						
S 7183	1	27- 7		ST						1
THRU			1299		VARY	LENGTH	BY	0- 7	1/ 8	
S 7221	1	5- 0		ST						1
S 7222	1	37-10		ST						1
THRU					VARY	LENGTH	BY	0- 7	1/ 8	
S 7276	1	6- 0	2464	ST						1
S 7277	1	7- 1		ST						1
THRU					VARY	LENGTH	BY	0- 7	3/ 8	
S 7328	1	38- 5	2418	ST						1
S 7330	92	36- 0	6770	ST						
S 7384	1	5- 0		ST						1
THRU			2248		VARY	LENGTH	BY	0- 7	1/ 4	
S 7436	1	36- 6		ST						1
S 7438	253	36- 6	18875	ST						
S 7454	10	36- 6		ST						1
THRU			12136		VARY	LENGTH	BY	0- 5	1/ 4	
S 7468	10	42- 8		ST						1
S 7532	1	42- 8		ST						1
THRU			3332		VARY	LENGTH	BY	0- 6	1/ 2	
S 7594	1	9- 1		ST						1
S 7595	1	42- 7		ST						1
THRU			2835		VARY	LENGTH	BY	0- 7	7/ 8	
S 7651	1	6- 1		ST						1

MARK	NUM.	LENGTH	WEIGHT	TYPE	A	B	C	D	E	NOTE
EPOXY COATED REINFORCING STEEL, SUPERSTRUCTURE										
SE5017	342	2- 7	921	ST						
SE5018	8	19-10	165	ST						
SE7001	32	5- 6	360	ST						
SE7002	1	6- 0		ST						1
THRU			1987		VARY	LENGTH	BY	0- 7		
SE7049	1	34- 6		ST						1
SE7050	241	32- 4	15928	ST						
SE7052	1	5- 0		ST						1
THRU			1652		VARY	LENGTH	BY	0- 7	1/ 8	
SE7096	1	30-11		ST						1
SE7142	235	31- 6	15131	ST						
SE7144	1	31- 9		ST						1
THRU			1631		VARY	LENGTH	BY	0- 7	1/ 8	
SE7182	1	9- 2		ST						1
SE7222	1	37-10		ST						1
THRU			2464		VARY	LENGTH	BY	0- 7	1/ 8	
SE7276	1	6- 0		ST						1
SE7277	1	7- 1		ST						1
THRU			2418		VARY	LENGTH	BY	0- 7	3/ 8	
SE7328	1	38- 5		ST						1
SE7329	92	31-10	5986	ST						
SE7331	1	5- 0		ST						1
THRU			2474		VARY	LENGTH	BY	0- 8	1/ 4	
SE7383	1	40- 8		ST						1
SE7437	253	40- 8	21030	ST						
SE7439	10	32- 4		ST						1
THRU			10859		VARY	LENGTH	BY	0- 5	1/ 4	
SE7453	10	38- 6		ST						1
SE7469	1	38- 6		ST						1
THRU			2801		VARY	LENGTH	BY	0- 6	1/ 2	
SE7531	1	5- 0		ST						1
SE7595	1	42- 7		ST						1
THRU			2835		VARY	LENGTH	BY	0- 7	1/ 8	
SE7651	1	6- 1		ST						1
SE 4001	1392	30-0	27896	ST						
SE 4002	171	19-0	2170	ST						
SE 4003	7	22-0	103	ST						
SE 4004	464	29-3	9066	ST						
SE5001	337	5- 4	1875	19	0- 8	2- 5	2- 2			
SE5004	337	3- 2	1113	15	0- 8	0- 8	1- 1	0- 9	0- 9	
SE5005	342	2- 5	862	12	1- 5	0- 11		0- 6		
SE5007	136	15- 8	2222	ST						
SE5008	180	7- 2	1346	ST						
SE5009	126	6- 5	843	ST						

FED. RD. DIVISION	STATE	PROJECT	TYPE FUNDS
2	OHIO		

LORAIN COUNTY
LOR-480-0.00

NOTES

- INDICATES SERIES BAR. EACH BAR VARIES FROM ADJACENT BAR(S) BY TABULATED AMOUNT(S). CALCULATED TO NEAREST 1/8 INCH. WEIGHT SHOWN IS FOR ENTIRE SERIES UTILIZING AVERAGE LENGTH.
- BARS INCLUDED WITH ITEM 517, RAILING, FOR PAYMENT.
- COST OF FIELD BENDING SHALL BE INCLUDED WITH ITEM 509.
- LIGHT POLE SUPPORT BARS INCLUDED WITH ITEM 509 FOR PAYMENT.
- END PREPARATION AND FIELD WELDING INCLUDED WITH ITEM 509.
- 'LENGTH' SHOWN FOR SPIRAL BARS IS DISTANCE FROM TOP OF FOOTING TO BOTTOM OF PIER CAP. 'NO. TURNS' SHOWN IS 'LENGTH' DIVIDED BY PITCH, PLUS 3 TURNS (NUMBER OF CLOSED COILS). EXPRESSED AS NEAREST WHOLE NUMBER.

1 1/2 CLOSED COILS SHALL BE PROVIDED AT ENDS OF EACH SPIRAL UNIT. FOUR STEEL CHANNEL, TEE OR ANGLE SPACERS, WEIGHING APPROXIMATELY 0.80 LB. PER LIN. FT. OF SPACER SHALL BE PROVIDED FOR EACH SPIRAL UNIT. THEY SHALL BE EQUALLY SPACED ALONG PERIPHERY OF COIL. WEIGHT OF SPACERS, AT 0.80 LB. PER LIN. FT. WILL BE PAID FOR AS REINFORCING STEEL AND IS INCLUDED IN TABULATED WEIGHT.


BAR DIMENSIONS ARE OUT TO OUT.

Refer to CMS Sections 106.03, 700, 709.01 through 709.05, and 709.08. Sufficient additional reinforcing steel shall be provided for sampling. Random samples shall be replaced in the structures by the additional steel, spliced in accordance with 509.08.

BAR SIZE DESIGNATION

BAR SIZE IS INDICATED IN THE BAR MARK. THE FIRST DIGIT WHERE FOUR DIGITS ARE USED, AND FIRST TWO DIGITS WHERE FIVE DIGITS ARE USED, INDICATE THE BAR SIZE NUMBER. FOR EXAMPLE, A7001 IS A NO. 7 SIZE BAR AND A10140 IS A NO. 10 SIZE.

BAR BENDING DIAGRAM TYPES

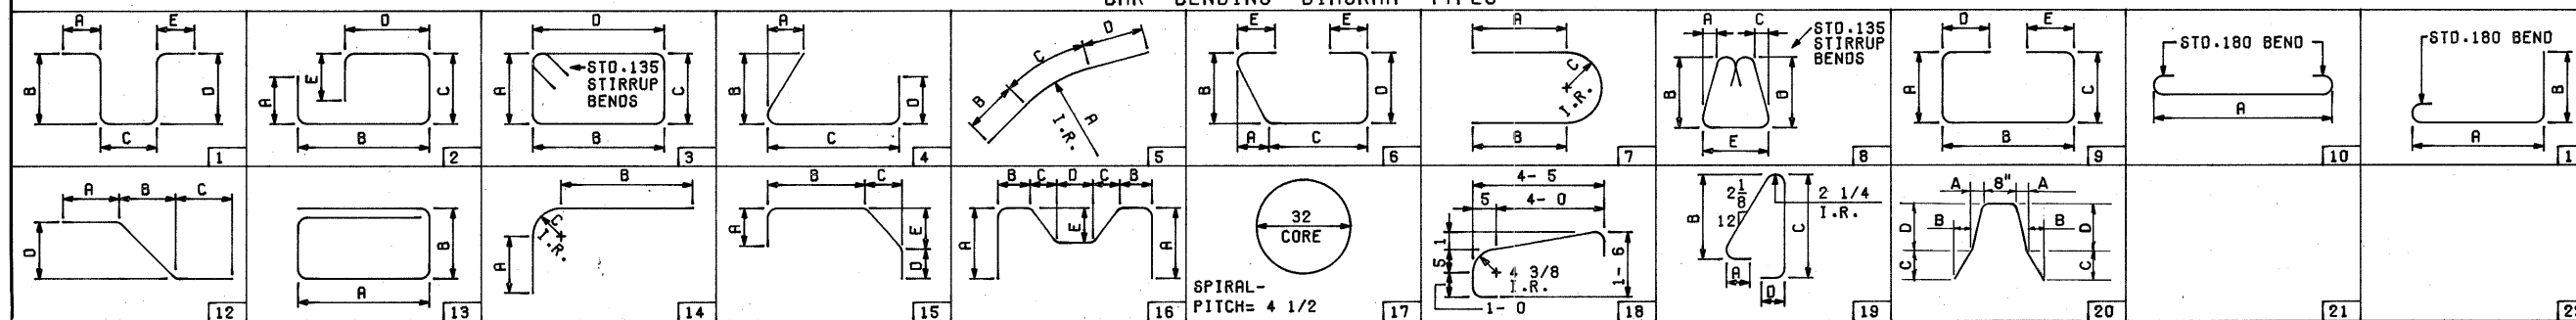

ALDEN E. STILSON & ASSOCIATES, LIMITED CONSULTING ENGINEERS CLEVELAND, OHIO COLUMBUS, OHIO WHEELING, W. VA.					
REINFORCING STEEL LIST					
BRIDGE NO LOR-80-1998					
I-80 OVER SR. 10 (LORAIN ROAD)					
LORAIN COUNTY				STA. 92+89.14	
				STA. 95+44.32	
DESIGNED	DRAWN	TRACED	CHECKED	REVIEWED	DATE
R.S.S.			B.I.P.	G.W.M.	5/28/70