COLUMBUS DOWNTOWN DEVELOPMENT CORPORATION SCIOTO GREENWAYS PROJECT CITY OF COLUMBUS, OHIO

BENCH MARKS

ALL BENCH MARKS SHOWN ARE BASED ON THE OHIO STATE PLANE, OHIO SOUTH ZONE (SPOS ZONE 3402) COORDINATE SYSTEM, REFERENCED TO THE NORTH AMERICAN DATUM OF 1983 (NAD83) WITH THE NSRS 2007 ADJUSTMENT. ALL ELEVATIONS ARE REFERENCED TO THE NORTH AMERICAN VERTICAL DATUM OF 1988

DESIGNATION: BROAD. ALUMINUM DISK SET IN THE NORTH END OF THE EAST ABUTMENT BACKWALL OF THE WEST BROAD STREET BRIDGE OVER THE SCIOTO RIVER, 15.7 FEET NORTH OF THE FACE OF THE NORTH CURB, 5 FEET SOUTHEAST OF A LARGE CONCRETE CIRCULAR PILLAR, 2 FEET NORTH OF A HANDRAIL.

DESIGNATION: COSICOLUMBUS. 6 INCH BRASS DISK SET FLUSH WITH THE CARPET ON THE SECOND FLOOR OF THE NEW COSI BUILDING, THE FOCAL POINT OF THE SOUTHERN ELLIPSE, AREA IS KNOWN AS CITY VIEW. DISK IS LOCATED 45.48 FEET SOUTHEAST OF THE CENTER OF THE PENDULUM, 26.65 FEET SOUTH OF THE CENTER FACE OF AN ELEVATOR SHAFT, 7.80 FEET WEST OF THE WEST FACE OF AN ALUMINUM FRAME FOR THE NORTHERLY DOOR LEADING OUTSIDE.

DESIGNATION: DISCOVERY. ALUMINUM DISK SET IN THE NORTH END OF THE WEST ABUTMENT BACKWALL OF THE WEST BROAD STREET BRIDGE OVER THE SCIOTO RIVER, AT THE INTERSECTION OF WEST BROAD STREET AND WASHINGTON BOULEVARD, 15.6 FEET NORTH OF THE FACE OF THE NORTH CURB, 6.6 FEET WEST OF A RAIL POST, 1 FOOT SOUTHWEST OF A LARGE CONCRETE CIRCULAR PILLAR, LEVEL WITH THE SIDEWALK.

ELEV. = 730.379

DESIGNATION: Q188RESET. BRASS DISK SET IN THE TOP OF THE GRANITE BASE OF THE COLUMBUS CITY HALL BUILDING AT THE NORTHWEST CORNER OF BROAD STREET AND FRONT STREET, ON THE EAST SIDE OF THE CITY HALL BUILDING, 40.5 FEET NORTH OF THE SOUTHEAST CORNER OF THE BUILDING, 1.5 FEET ABOVE THE SIDEWALK, 1 FOOT WEST OF THE EAST EDGE OF THE GRANITE BASE, STAMPED "Q188 RESET 1987".


ELEV. = 746.283


DESIGNATION: COC15-83RESET. ALUMINUM PLUG SET IN CONCRETE ON THE NORTH SIDE OF SPRING STREET, 0.2 MILES WEST OF HOCKING STREET, 5.8 FEET NORTH OF THE NORTH EDGE OF THE NORTH CURB ON SPRING STREET, 72.5 FEET WEST OF THE NORTHWEST PARAPET WALL OF THE SPRING STREET BRIDGE OVER THE OLENTANGY RIVER, 12 FEET SOUTHWEST OF A LARGE STEEL ELECTRIC POLE, 1.1 FEET SOUTHWEST OF A WITNESS POST, 2.0 FEET BELOW THE GROUND, ACCESS THROUGH AN 8 INCH CLAY TILE WITH A CAST IRON LID.

N 716,525.150 E 1,822,840.693 ELEV. = 724.213

DESIGNATION: TOWERRESET. ALUMINUM DISK SET IN A DRILL HOLE IN THE SOUTHEAST CORNER OF THE CONCRETE ROOF OF THE STATE OFFICE TOWER AT 30 EAST BROAD STREET, 0.1 MILES EAST OF HIGH STREET, STATION LOCATED 4.35 FEET WEST FROM THE BASE OF THE EAST PARAPET WALL, 4.3 FEET NORTH FROM THE BASE OF THE SOUTH PARAPET WALL. STATION IS 189.5 FEET SOUTHEAST OF STATION "RHODES". MONUMENT WAS REPAIRED AND RESET IN 2000. ORIGINAL SET DATE WAS 1982.

N 715,204.190 E 1,828,565.050 ELEV. = 738.83

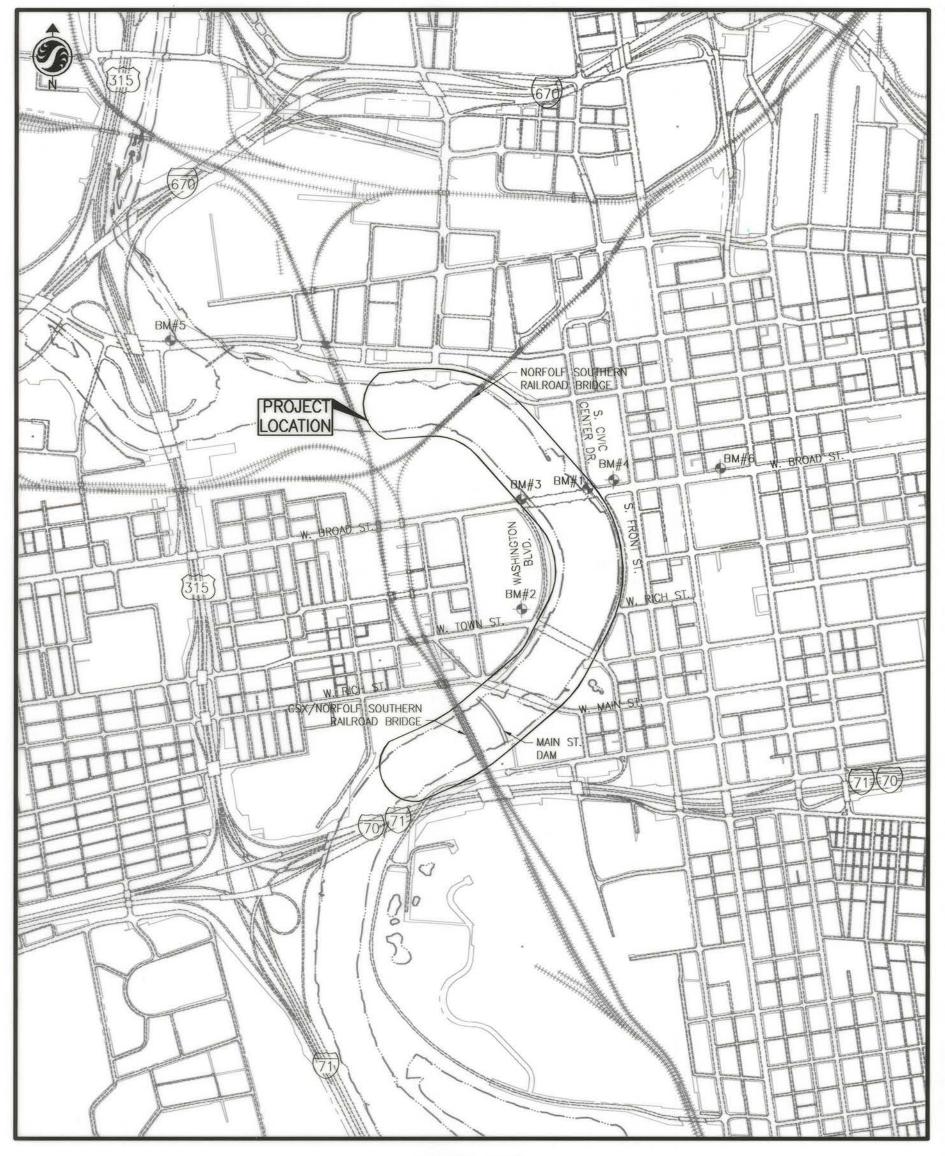

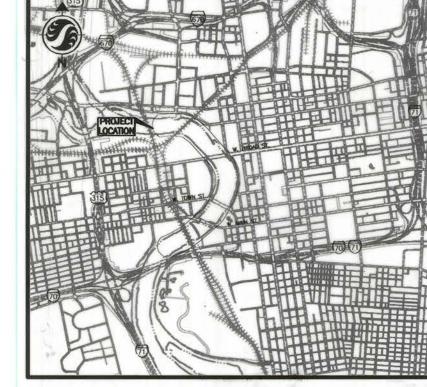

STANDARD DRAWINGS

THE FOLLOWING LISTED STANDARD DRAWINGS SHALL BE CONSIDERED A PART OF THESE PLANS:

AA-S102	AA-S13
AA-S104	AA-S14
AA-S106	AA-S15
AA-S107	AA-S15
AA-S112	AA-S16
AA-S114	AA-S16
AA-S117	AA-S16
AA-S119	AA-S16

SHEET INDEX


TITLE SHEET	GN-101
GENERAL NOTES AND LEGEND	GN-102 - GN-103
CONTROL POINTS	V-101
OVERVIEW	CR-101
MAIN STREET DAM DEMOLITION PLAN	CR-102
STREAM RESTORATION PLANS	CR-103 - CR-107
STREAM RESTORATION PROFILE	CR-108
STREAM RESTORATION TYPICAL SECTIONS	CR-109
STREAM RESTORATION CROSS SECTIONS	CR-110 - CR-114
STREAM RESTORATION DETAILS	CR-115 - CR-118
SEWER EXTENSION PROFILES	CS-101 - CS-102
SEWER EXTENSION DETAILS	CS-103 - CS-105
FORCE MAIN PLAN AND PROFILE	CS-106
STRUCTURAL/GEOTECHNICAL DETAILS	S-101 - S-150

TOPOGRAPHICAL AND CONTROL DATA PER FIELD SURVEY DATED 11/7/2012 PROVIDED BY RESOURCE INTERNATIONAL, INC.

WATER QUALITY BMP NOTE: LEVEL SPREADER, DETAIL 2/CS-105, IS A STORMWATER QUALITY BMP WHICH IS AN INTEGRAL PART OF THE PUBLIC STORM SEWER SYSTEM DEPICTED IN THESE DRAWINGS. RESPONSIBILITY AND ASSURANCE OF PERIODIC MAINTENANCE AND THE CONTINUOUS FUNCTIONALITY OF THIS STORMWATER QUALITY DEVICE IS PERPETUAL; BEGINNING WITH THE OWNER AT THE TIME OF INSTALLATION AND CONTINUING TO ALL FUTURE OWNERS OF SAID STORM SEWER SYSTEM. SEE SHEET CS-105 FOR POST-CONSTRUCTION INSPECTION AND MAINTENANCE REQUIREMENTS.

	ENGINEER
UNDERGROUND UTILITIES	FOR ENTIRE PLANS EX
Two Working Days BEFORE YOU DIG	BRY
Call 800-362-2764 (Toll free) OHIO UTILITIES PROTECTION SERVICE	RING E-60

NON-MEMBERS MUST BE CALLED DIRECTLY RS SEAL ENGINEERS SEAL XCEPT GEOTECHNICAL FOR GEOTECHNICAL

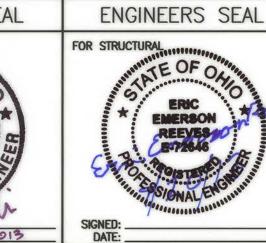



	EA	SEMENT REFEREI	NCE		REVISIONS	
CITY NO.	COUNTY I	RECORDER	CDANTOD	NO.	DESCRIPTION	APPROVAL/DATE
	VOL	PAGE	GRANTOR			



Stantec Consulting Services Inc. 1500 Lake Shore Drive, Suite 100 Columbus, Ohio 43204 (614) 486-4383 (614) 486-4387

PREPARED BY:

APPROVALS:			ONCURRENCE WITH	
			OJECT. ALL TECHNI ER PREPARING THE	
	THE RESPONSIBIL	III OF THE ENGINE	LIX FIXEFAMING THE	runs.
	4 1		ä	
John J	Wense	10/2/13	DIRECTOR, DEPARTMENT	2 by anluby
	NGINEERING MANAGER, RAGE & DRAINAGE	DATE	DIRECTOR, BEPARTMENT (F PUBLIC UTILITIES
Con	TO DE LE BIONIO	10-2-13	Hasson Y.Z	ahm land
DOTAL D	DIVISION OF POWER	DATE	CITY ENGINEER/ADMINISTR	ATOR, DIVISION
	· Celebrate)	10.3.13	OF DESIGN & CONSTRUCT	ION / 17/6
FOR H.	IVISION OF SEWERAGE	DATE	DIRECTOR, DEPARTMENT	OF PUBLIC SERVICE
& DRAINAGE	- 1 il	0.04	,	
MY RCZ	exterfield	9-24-13	NOTONO OF STATE OF	P DECDEATION
ADMINISTRATOR, D	IVISION UP WATER	DATE	DIRECTOR, DEPARTMENT/O	r RECREATION

	urpose Emain	PROJECT TITL
í	10.7.1013 DATE	
	/0-2-13 DATE	
3	10-2-13 DATE	
	DATE	

COLUMBUS DOWNTOWN DEVELOPMENT CORPORATION SCIOTO GREENWAYS PROJECT CITY OF COLUMBUS, OHIO

CITY OF COLUMBUS DEPARTMENT OF PUBLIC UTILITIES DIVISION OF SEWERAGE AND DRAINAGE DIVISION USE ONLY

DIVISION USE ONLY		OW	NER				
		CONTR	RACTOR				
	INSPECTOR				2011 to 0101111	CUETT C	CN 101
	AGREEMENT		COMPLETED		SCALE: AS SHOWN	SHEET: GN-10	
V	RPD	CKD	CLD	CON. DR.	CONTRACT DRAWING NO.	RECORD PLAN NO.	
		INDEX DETAIL		ECORD FILE	CC-16423		

ANY MODIFICATION TO THE SPECIFICATIONS OR CHANGES TO THE WORK AS SHOWN ON THE DRAWINGS MUST HAVE PRIOR WRITTEN APPROVAL BY THE ADMINISTRATOR OF THE DIVISION OF SEWERAGE AND DRAINAGE.

- ADDITIONAL COMPENSATION: THE CONTRACTOR SHALL FURNISH ALL LABOR, MATERIALS, TOOLS, EQUIPMENT, SERVICES, AND RELATED ACCESSORIES FOR A COMPLETE PROJECT AS SHOWN AND DESCRIBED IN THE PLANS AND SPECIFICATIONS. THE PRICE FOR ITEMS OF WORK OR MATERIALS SHOWN ON THE PLANS OR PROVIDED FOR IN THE SPECIFICATIONS OR SPECIAL PROVISIONS FOR WHICH NO SEPARATE UNIT PRICE IS GIVEN SHALL BE BID AS PER PLANS AND THE COSTS DISTRIBUTED AMONG THE VARIOUS BID ITEMS. SUBMISSION OF A BID SHALL BE CONSIDERED EVIDENCE THAT THE BIDDER IS SATISFIED WITH THE PLANS AND CONDITIONS AS SHOWN. NO ADDITIONAL COMPENSATION WILL BE PAID TO THE CONTRACTOR FOR COMPLIANCE WITH THE PLANS, SPECIFICATIONS, OR SPECIAL PROVISIONS.
- 3. NOTIFICATION: THE CONTRACTOR SHALL NOTIFY THE FOLLOWING DIVISIONS AT LEAST 48 HOURS IN ADVANCE OF THE ANTICIPATED START OF CONSTRUCTION, HOLIDAYS AND WEEKENDS EXCLUDED. WORK SHALL NOT COMMENCE UNTIL A PRE-CONSTRUCTION CONFERENCE IS HELD.

DIVISION OF SEWERAGE AND DRAINAGE	(614) 645-7102
DIVISION OF WATER	(614) 645-7788
DIVISION OF POWER	(614) 645-7627
DIVISION OF FIRE	(614) 221-3132
DIVISION OF POLICE	(614) 645-6676
DIVISION OF PLANNING AND OPERATIONS	(614) 645-7738
DIVISION OF INSPECTION SERVICES	(614) 645-0433

THE CONTRACTOR SHALL NOTIFY, IN WRITING, ALL ADJACENT LANDOWNERS A MINIMUM OF ONE WEEK IN ADVANCE OF WORK NEAR THEIR PROPERTY. THE CONTRACTOR SHALL CONTACT THE DIVISION OF SEWERAGE AND DRAINAGE FOR A SUGGESTED FORMAT FOR THE NOTICE.

- PERMITS: THE CONTRACTOR SHALL OBTAIN ALL NECESSARY PERMITS AND LICENSES NEEDED FOR CONSTRUCTION OF THIS PROJECT AS REQUIRED UNDER CMSC 107.02. WHEN EXCAVATING WITHIN THE PUBLIC RIGHT-OF-WAY LIMITS INSIDE THE CITY OF COLUMBUS, THE CONTRACTOR SHALL OBTAIN AN EXCAVATION PERMIT FROM THE DIVISION OF PLANNING AND OPERATIONS PERMIT OFFICE BY CALLING 645-3039 DURING THE HOURS OF 8:00 A.M. TO 4:00 P.M., MONDAY - FRIDAY.
- 5. NON-RUBBER TIRED VEHICLES: NO NON-RUBBER TIRED VEHICLES SHALL BE MOVED ON PUBLIC STREETS OR ROADS. THE DPS DESIGN AND CONSTRUCTION DIVISION MAY GRANT EXCEPTIONS WHERE SHORT DISTANCES AND SPECIAL CIRCUMSTANCES ARE INVOLVED. GRANTING OF EXCEPTIONS MUST BE IN WRITING AND ANY RESULTING DAMAGE MUST BE REPAIRED TO THE SATISFACTION OF THE APPROPRIATE JURISDICTION.
- 6. <u>SAFETY:</u> THE CONTRACTOR SHALL BE SOLELY RESPONSIBLE FOR COMPLYING WITH ALL FEDERAL, STATE, AND LOCAL SAFETY REQUIREMENTS. TOGETHER WITH EXERCISING PRECAUTIONS AT ALL TIMES FOR THE PROTECTION OF PERSONS (INCLUDING EMPLOYEES) AND PROPERTY, IT IS ALSO THE SOLE RESPONSIBILITY OF THE CONTRACTOR TO INITIATE, MAINTAIN, AND SUPERVISE ALL SAFETY REQUIREMENTS, PRECAUTIONS, AND PROGRAMS IN CONNECTION WITH THE WORK.
- ELEVATION DATUM: ELEVATIONS SHOWN ON THESE PLANS ARE BASED ON THE NAVD88 DATUM.
- BENCHMARKS: THE CONTRACTOR SHALL CAREFULLY PRESERVE BENCHMARKS, PROPERTY CORNERS, REFERENCE POINTS, AND STAKES. ANY BENCHMARK, PROPERTY CORNER. OR SURVEY MARKER DAMAGED OR DISTURBED BY THE CONTRACTOR SHALL BE RESET BY AN OHIO REGISTERED SURVEYOR AT THE CONTRACTOR'S EXPENSE.
- RIGHT-OF-WAY: IN ADDITION TO THE DIRECT REQUIREMENTS OF THE CONTRACT SPECIFICATIONS. THE CONTRACTOR SHALL OBSERVE AND CONFORM TO THE SPECIFIC REQUIREMENTS OF ALL RIGHTS-OF-WAY INCLUDING EASEMENTS, COURT ENTRIES, AND RIGHTS OF ENTRY OR ACTION FILED IN COURT IN ACCORDANCE WITH THE CODE OF THE APPLICABLE GOVERNING AGENCY. THE COST OF THE OPERATIONS NECESSARY TO FULFILL SUCH REQUIREMENTS SHALL BE INCLUDED IN THE PRICE BID FOR THE VARIOUS ITEMS OF THE CONTRACT. UNLESS SPECIFIC PROVISION IS MADE IN THE CONTRACT SPECIFICATIONS FOR SUCH COST UNDER SPECIFIC ITEMS OF THE CONTRACT.
- 10. UTILITIES: THE LOCATIONS OF UNDERGROUND UTILITIES SHOWN ON THE PLAN ARE OBTAINED FROM THE OWNERS OF THE UTILITY AS REQUIRED BY SECTION 153.64 ORC. THE UTILITY LOCATIONS INDICATED ARE NOT NECESSARILY COMPLETE OR CORRECT. THE CONTRACTOR IS RESPONSIBLE FOR THE INVESTIGATION, LOCATION, SUPPORT, PROTECTION AND RESTORATION OF ALL EXISTING UTILITIES AND APPURTENANCES SHOWN.

FAX ALL LOCATION REQUESTS (2) WORKING DAYS PRIOR TO THE START OF CONSTRUCTION.

NON-OUPS MEMBERS: CITY OF COLUMBUS DIVISION OF PLANNING & OPERATIONS DEPARTMENT OF TECHNOLOGY TRAFFIC MAINTENANCE 1820 17TH AVENUE COLUMBUS, OHIO 43219 P: 614-645-7393

CITY OF COLUMBUS 90 WEST BROAD STREET COLUMBUS, OHIO 43215 P: 614-645-1501 F: 614-645-6627

CITY OF COLUMBUS DIVISION OF SUPPORT SERVICES - COMMUNICATIONS 4211 GROVES ROAD COLUMBUS, OHIO 43232 P: 614-724-7047

OUPS MEMBERS: AMERICAN ELECTRIC POWER 700 MORRISON ROAD GAHANNA, OHIO 43230 P: 614-716-1000

F: 614-645-5967

F: 614-645-6588

COLUMBIA GAS OF OHIO 1600 DUBLIN ROAD COLUMBUS, OHIO 43215 P: 614-481-1063

11. GRADE CHANGES: IF IT IS DETERMINED THAT THE ELEVATION OF THE EXISTING SEWER, OR EXISTING APPURTENANCE TO BE CONNECTED, DIFFERS FROM THE PLAN ELEVATION OR RESULTS IN A CHANGE IN THE PLAN SEWER SLOPE, THE ENGINEER SHALL BE NOTIFIED BEFORE STARTING CONSTRUCTION OF ANY PORTION OF THE PROPOSED SEWER WHICH WILL BE AFFECTED BY THE VARIANCE IN THE EXISTING ELEVATIONS.

IF IT IS DETERMINED THAT THE PROPOSED SEWER WILL INTERSECT AN EXISTING SEWER OR UNDERGROUND UTILITY IF CONSTRUCTED AS SHOWN ON THE PLAN. THE ENGINEER SHALL BE NOTIFIED BEFORE STARTING CONSTRUCTION OF ANY PORTION OF THE PROPOSED SEWER WHICH WOULD BE AFFECTED BY THE INTERFERENCE WITH AN EXISTING FACILITY.

GRADES AND ELEVATIONS SHOWN ON THE PLANS SHALL NOT BE REVISED UNDER ANY CIRCUMSTANCES WITHOUT FIRST OBTAINING WRITTEN APPROVAL FROM THE ENGINEER. INVERT ELEVATIONS SHALL NOT DEVIATE FROM PLAN ELEVATION BY MORE THAN 0.05 FOOT. FAILING TO MEET THE ABOVE REQUIREMENTS IS CAUSE FOR REJECTION OF THE AFFECTED SECTION OF SEWER.

12. FOR THE DIVISION OF WATER: IT SHALL BE UNLAWFUL FOR ANY PERSON TO PERFORM ANY WORK ON CITY OF COLUMBUS WATER LINE SYSTEMS WITHOUT FIRST SECURING LICENSE TO ENGAGE IN SUCH WORK, AS INDICATED IN COLUMBUS CITY CODE SECTION 1103.02 AND 1103.06. THIS WORK INCLUDES ANY ATTACHMENTS, ADDITIONS TO OR ALTERATIONS IN ANY CITY SERVICE PIPE OR APPURTENANCES (INCLUDING WATER SERVICE LINES AND TAPS). THIS REQUIREMENT MAY BE MET BY UTILIZATION OF A SUBCONTRACTOR WHO HOLDS A CITY OF COLUMBUS WATER CONTRACTOR LICENSE OR A COMBINED WATER/SEWER CONTRACTOR LICENSE TO PERFORM THIS WORK. UTILIZATION OF A SUBCONTRACTOR MUST MEET THE LICENSING REQUIREMENTS OF CITY OF COLUMBUS BUILDING CODE, IN PARTICULAR SECTION 4114.119 AND 4114.529.

NO TWO (2) ADJACENT FIRE HYDRANTS SHALL BE TAKEN OUT OF SERVICE CONCURRENTLY.

THE CONTRACTOR SHALL NOTIFY THE DIVISION OF FIRE ALARM OFFICE, 221-3132, WHENEVER FIRE HYDRANTS ARE TAKEN OUT OF SERVICE AND PLACED BACK IN SERVICE.

- 13. FIRE HYDRANT PERMIT: THE CONTRACTOR MUST OBTAIN FROM THE DIVISION OF WATER A FIRE HYDRANT PERMIT PRIOR TO CONNECTION OF WATER SUPPLY LINES TO ANY FIRE HYDRANT. THE CONTRACTOR SHALL PROVIDE THE NECESSARY GATE VALVES, BACKFLOW PREVENTERS, AND FLOW METER FOR EACH HYDRANT LOCATION. ALL EQUIPMENT. FITTINGS AND VALVES SHALL BE IN ACCORDANCE WITH DIVISION OF POWER AND WATER STANDARDS. THE CONTRACTOR SHALL PAY FOR WATER AT THE CURRENT CITY RATES. CONNECTED HOSES SHALL NOT BE LEFT UNATTENDED.
- 14. TRENCHING: ANY EXCAVATION PERFORMED BEYOND THE MINIMUM TRENCH WIDTH, AS DEFINED ON DIVISION OF SEWERAGE AND DRAINAGE STANDARD CONSTRUCTION DRAWINGS AA-S149, AA-S151, AND AA-S152 DUE TO SITE CONDITIONS OR THE CONTRACTOR'S METHODS ARE DONE SO SOLELY AT THE CONTRACTOR'S EXPENSE. NO EXTRA PAYMENT WILL BE MADE FOR UNAUTHORIZED EXCAVATION. BLASTING IS NOT PERMITTED.
- 15. <u>DEWATERING</u>: SHOULD WATER BE ENCOUNTERED, THE CONTRACTOR IS RESPONSIBLE TO PROVIDE ALL DEWATERING OPERATIONS AS REQUIRED TO ACCOMPLISH THE PROPOSED CONSTRUCTION OPERATIONS, PER CMSC ITEM 901.06. THE TRENCH SHALL BE SUFFICIENTLY DEWATERED SO THAT THE PLACEMENT OF BEDDING AND LAYING AND JOINING OF THE PIPE OR STRUCTURES IS MADE ON FIRM, DRY GROUND. THE CONTRACTOR SHALL BE RESPONSIBLE TO PLACE AND MAINTAIN THE NECESSARY SEDIMENT CONTROL MEASURES TO FILTER THE DEWATERING DISCHARGE. DIRECT DISCHARGE OF SEDIMENT LADEN WATER TO THE CITY'S SEWER SYSTEM OR A RECEIVING STREAM IS A VIOLATION OF OHIO EPA AND CITY OF COLUMBUS REGULATIONS; THE CONTRACTOR WILL BE HELD LIABLE FOR THE VIOLATION AND SUBSEQUENT FINES. THE COST OF ALL DEWATERING WORK SHALL BE INCLUDED IN THE UNIT PRICE BID FOR CMSC ITEM 901.

16. TRENCH BACKFILL: TRENCH BACKFILL SHALL BE PER CMSC ITEM 901.17. NO ADDITIONAL COMPENSATION SHALL BE MADE FOR TRENCHES REQUIRING CMSC ITEM 911, COMPACTED BACKFILL. THE COST FOR BACKFILLING TRENCHES WITH CMSC ITEM 912, COMPACTED GRANULAR MATERIAL SHALL BE PAID FOR UNDER THE APPLICABLE "ITEM 901 - XX" PIPE, WITH TYPE I BEDDING, INCLUDING ITEM 912 BACKFILL", NO SEPARATE PAYMENT SHALL BE MADE FOR ITEM 912. COMPACTED GRANULAR MATERIAL.

AT ALL POINTS OF CROSSING WATER MAINS OR OTHER SEWERS, THE BACKFILL SHALL BE OF GRANULAR MATERIAL BETWEEN THE DEEPER AND SHALLOWER PIPES.

ALL TRENCHES WITHIN THE ROAD RIGHT-OF-WAY SHALL BE BACKFILLED OR SECURELY PLATED DURING NON-WORKING HOURS.

THE CONTRACTOR SHALL BE RESPONSIBLE FOR THE CONDITION OF THE TRENCHES FOR A PERIOD OF ONE (1) YEAR FROM THE DATE OF FINAL INSPECTION. THE COST OF THIS WORK SHALL BE INCLUDED IN THE UNIT PRICE BID FOR CMSC ITEM 901.

17. STORMWATER FACILITIES: BEFORE ANY WORK IS STARTED ON THE PROJECT AND AGAIN BEFORE FINAL ACCEPTANCE BY THE OWNER. THE ENGINEER AND THE CONTRACTOR SHALL MAKE AN INSPECTION OF ALL EXISTING SEWERS WHICH ARE TO REMAIN IN SERVICE AND WHICH MAY BE AFFECTED BY THE WORK. THE CONDITION OF THE EXISTING CONDUITS AND THEIR APPURTENANCES SHALL BE DETERMINED FROM FIELD OBSERVATIONS. THE ENGINEER SHALL KEEP RECORDS OF THE INSPECTION IN WRITING.

ALL NEW CONDUITS, INLETS, CATCH BASINS, AND MANHOLES CONSTRUCTED OR RECONSTRUCTED AS A PART OF THE PROJECT SHALL BE FREE OF ALL FOREIGN MATTER AND IN A CLEAN CONDITION BEFORE THE PROJECT WILL BE ACCEPTED BY THE OWNER.

ALL EXISTING MANHOLES, CATCH BASINS, DRAINS, SEWERS, AND APPURTENANCES INSPECTED INITIALLY BY THE ABOVE MENTIONED PARTIES SHALL BE MAINTAINED AND LEFT IN A CONDITION REASONABLY COMPARABLE TO THAT DETERMINED BY THE ORIGINAL INSPECTION. THE CONTRACTOR SHALL CORRECT ANY CHANGE IN THE CONDITION RESULTING FROM THE CONTRACTOR'S OPERATIONS TO THE SATISFACTION OF THE ENGINEER. THE ABOVE IS NOT APPLICABLE FOR STRUCTURES TO BE ABANDONED. THE CONTRACTOR SHALL REMOVE DEBRIS, SILT, ETC. FROM THE EXISTING MANHOLES AND CATCH BASINS THAT HAVE BEEN AFFECTED BY CONSTRUCTION OPERATIONS. THE CONTRACTOR SHALL MAINTAIN SERVICE IN EXISTING SEWERS DURING CONSTRUCTION.

18. EXISTING DRAINAGE SYSTEMS: EXISTING DRAINAGE SYSTEMS (FIELD TILES, ROOF DRAIN OUTLETS, SUMP PUMPS, ETC.) ENCOUNTERED DURING CONSTRUCTION OF THE NEW SEWER SHALL BE EXTENDED AS NECESSARY AND BLIND TAPPED TO THE NEW SEWER PER DIVISION OF SEWERAGE AND DRAINAGE STANDARD DRAWING AA-S159 OR CONNECTED TO THE NEAREST STRUCTURE AS DIRECTED BY THE ENGINEER. ALL COSTS ASSOCIATED WITH THIS WORK SHALL BE INCLUDED IN THE UNIT PRICE BID FOR CMSC ITEM 901.

IF THE CONTRACTOR ENCOUNTERS A PIPE OR CONNECTION TO THE STORM SEWER THAT IN THE ESTIMATE OF THE ENGINEER MAY BE AN ILLICIT CONNECTION FROM AN ON-SITE SEWAGE DISPOSAL SYSTEM, COLUMBUS PUBLIC HEALTH SHALL BE CONTACTED AT 645-6448 TO DETERMINE WHETHER THE PIPE MAY BE RECONNECTED TO THE CITY'S STORM SEWER SYSTEM.

- 19. CERTIFICATION OF PIPE AND STRUCTURES: ALL CONCRETE PIPE, STORM AND SANITARY STRUCTURES WILL BE STAMPED OR HAVE SUCH IDENTIFICATION NOTING THAT SAID PIPE, STORM AND SANITARY STRUCTURES HAVE BEEN INSPECTED BY THE DESIGNATED REPRESENTATIVE OF THE CITY OF COLUMBUS AND MEETS THEIR SPECIFICATIONS. PIPE AND STRUCTURES WITHOUT PROPER IDENTIFICATION WILL NOT BE PERMITTED FOR INSTALLATION.
- 20. MANHOLE STEPS: MANHOLE STEPS SHALL BE REINFORCED POLYPROPYLENE PLASTIC PER DOSD STD. CONSTRUCTION DRAWING AA-S119. PAYMENT FOR MANHOLE STEPS SHALL BE INCLUDED IN THE UNIT PRICE BID FOR CMSC ITEM 604, MANHOLE.
- 21. STORM STRUCTURE ADJUSTMENT: THE CONTRACTOR SHALL FIELD VERIFY THE TOP OF CASTING ELEVATION OF ALL NEW STORMWATER STRUCTURES. IF PRECAST STRUCTURES ARE UTILIZED, THE TOP 6 INCHES MINIMUM SHALL BE FIELD PLACED EITHER WITH GRADE RINGS OR BRICK AND MORTAR TO ALLOW FOR FIELD ADJUSTMENT. THE COST FOR THIS WORK SHALL BE INCLUDED IN THE UNIT PRICE BID FOR THE APPLICABLE CMSC ITEM 604.

IF THE ENGINEER DETERMINES THAT AN INLET IS TOO LOW/HIGH AFTER IT HAS BEEN PLACED AND ROUGH GRADING PERFORMED, THE CONTRACTOR SHALL ADJUST THE INLET AS DIRECTED BY THE ENGINEER AND REGRADE THE AREA ACCORDINGLY. FOR ADJUSTMENTS OF +/- 6 INCHES, THE COST TO ADJUST THE INLET SHALL BE INCLUDED IN THE UNIT PRICE BID FOR THE APPLICABLE CMSC ITEM 604. FOR ADJUSTMENTS GREATER THAN +/- 6 INCHES, THE COST TO ADJUST THE INLET SHALL BE PAID FOR IN THE UNIT PRICE BID FOR CMSC ITEM SPECIAL - INLET ADJUSTED, AS DIRECTED BY ENGINEER, AND SHALL CONSTITUTE FULL PAYMENT FOR ADJUSTING THE INLET INCLUDING GRADE RINGS, CONCRETE SAWING, MORTAR, EXCAVATION, BACKFILL, REGRADING, ETC.

22. END TREATMENT: IMMEDIATELY AFTER PLACEMENT OF ANY CONDUITS, THE CONTRACTOR SHALL CONSTRUCT THE END TREATMENTS REQUIRED BY THE PLANS AT BOTH THE OUTLET AND INLET ENDS. THIS SHALL INCLUDE HEADWALLS, CONCRETE, RIPRAP, ROCK CHANNEL PROTECTION, SODDING, ETC.

23. CITY OF COLUMBUS PARK PROPERTY: THE CONTRACTOR SHALL CONTACT THE CITY FORESTER OF THE RECREATION AND PARKS DEPARTMENT (PHONE: (614) 645-3350) 24 HOURS PRIOR TO ANY CONSTRUCTION IN OR NEAR CITY OF COLUMBUS PARK

24. TREE PRESERVATION: ALL TREES, WHETHER SHOWN OR NOT SHOWN ON THE PLANS, ARE TO BE PRESERVED UNLESS APPROVAL TO REMOVE IS GIVEN IN WRITING BY THE CITY FORESTER OR THEIR REMOVAL HAS BEEN DESIGNATED ON THE PLAN. TREES REMOVED BY EITHER OF THE TWO PRECEDING AUTHORITIES SHALL BE PAID FOR UNDER CMSC ITEM 201, CLEARING AND GRUBBING, UNLESS OTHERWISE PROVIDED FOR BY UNIT PRICE BID UNDER ITEM 201, TREE REMOVED, XX" SIZE. THE CONTRACTOR SHALL USE SPECIAL PRECAUTIONS TO AVOID DAMAGE TO ALL OTHER TREES. ALL TREES REMOVED SHALL INCLUDE STUMP REMOVAL TO 6 INCHES BELOW GRADE. ALL WOOD OVER 4-INCH DIAMETER SHALL, AT THE PROPERTY OWNER'S DISCRETION, BE CUT INTO LENGTHS NOT EXCEEDING 16 INCHES AND STACKED ON THE OWNER'S PROPERTY ADJACENT TO THE PERMANENT EASEMENT. THE COST FOR TREE, BRUSH, AND STUMP REMOVAL SHALL BE INCLUDED IN THE PRICE BID FOR CMSC ITEM 201, CLEARING AND GRUBBING. THE CONTRACTOR IS TO WORK WITH STAFF FROM THE DIVISION OF PARKS AND RECREATION (614-645-6640) ON ALL TREE REMOVALS.

PRUNING: BRANCHES OR GROWTH THAT INTERFERES WITH THE FREE CONSTRUCTION OF THE PROJECT MAY BE REMOVED FROM TREES/BUSHES THAT ARE TO BE SAVED BY THE USE OF PRUNING TOOLS WITH PRIOR APPROVAL FROM THE CITY FORESTER. ALL PRUNING TOOLS USED AND METHODS EMPLOYED SHALL MEET THE APPROVAL OF THE CITY FORESTER THE COST OF ALL WORK AND EXPENSES CONNECTED WITH TREE PRUNING SHALL BE INCLUDED IN THE PRICE BID FOR CMSC ITEM 201, CLEARING AND GRUBBING. NO EXTRA PAYMENT SHALL BE MADE.

TREES DAMAGED OR DESTROYED THAT WERE NOT DESIGNATED FOR REMOVAL OR APPROVED BY THE CITY FORESTER FOR REMOVAL SHALL BE REPLACED AT THE CONTRACTOR'S EXPENSE. IF SUITABLE REPLACEMENT CANNOT BE DETERMINED, COMPENSATION BY THE CONTRACTOR FOR UNAUTHORIZED TREE REMOVAL SHALL INCLUDE SUFFICIENT ADDITIONAL LANDSCAPING AS DETERMINED BY RECREATION AND PARKS AND THE CITY FORESTER.

PROTECTION DURING CONSTRUCTION: PUBLIC TREES WILL BE PROTECTED AGAINST INJURY OR DAMAGE TO BRANCHES, TRUNKS OR ROOTS FROM CONSTRUCTION AND EXCAVATION. CITY OF COLUMBUS FORESTRY SECTION CAN BE CONTACTED @ 614-645-6640.

- A. ALL TREE PRUNING AND REMOVAL MUST BE DONE IN ACCORDANCE TO ANSI A300 AND ANSI Z133.1 STANDARDS. THE CONTRACTOR PERFORMING THE WORK MUST BE A PROFESSIONAL TREE CARE COMPANY WITH A CERTIFIED ARBORIST ON STAFF AND AVAILABLE TO DIRECT THE ON-SITE CREW.
- HEAVY EQUIPMENT WILL NOT BE ALLOWED TO COMPACT THE SOIL OVER THE ROOT ZONE OF EXISTING TREES. RESTRICTED EQUIPMENT ACCESS ROUTES WILL BE ESTABLISHED BEFORE WORK IS BEGUN. TEMPORARY PAVING MATERIALS SUCH AS PLYWOOD, LUMBER OR RUBBER MATTING SPREAD OVER THE ROOT ZONE MAY BE REQUIRED TO PREVENT COMPACTION.
- INSTALLATION OF UTILITIES UNDER THE DRIPLINE OF EXISTING TREES MUST BE DIRECTIONALLY BORED OR DRILLED BELOW THE ROOT ZONE. TOP OF THE BORE OR TUNNEL SHOULD BE NO HIGHER THAN 3 FEET DEEP. OPEN TRENCHES WITHIN THE ROOT ZONE MUST BE AVOIDED.
- D. WHERE GRADE CHANGE IS REQUIRED WITHIN THE ROOT ZONE OF PUBLIC TREES, A SUFFICIENT RESIDUAL ROOT ZONE TO PROVIDE FOR THE GOOD HEALTH OF THE TREES SHOULD REMAIN UNDISTURBED AND PROTECTED BY EITHER A DRY WELL OR RETAINING WALL IF THE GRADE IS TO BE RAISED OR LOWERED.
- CONSTRUCTION MATERIALS, EXCAVATION DEBRIS, CHEMICALS, FUEL, EQUIPMENT OR VEHICLES ARE NOT TO BE STOCKPILED, STORED, DUMPED OR PARKED WITHIN THE DRIPLINE OF PUBLIC TREES.
- FIRES ARE NOT PERMITTED WITHIN THE DRIPLINE OF ANY TREES.
- ALL EXISTING TREES DESIGNATED FOR PRESERVATION WILL BE PROTECTED WITH A GOOD, SUBSTANTIAL FENCE, FRAME OR BOX NOT LESS THAN FOUR FEET HIGH AND AS FAR FROM THE TREE AS POSSIBLE. DRIPLINE IS PREFERABLE, HOWEVER, ACTUAL LOCATION WILL BE DETERMINED BY SITE LIMITATIONS.
- FENCING WILL BE INSTALLED BEFORE COMMENCING SITE PREPARATION WORK. FENCE MUST BE MAINTAINED DURING THE FULL CONSTRUCTION PERIOD.
- INTERFERING BRANCHES OF TREES MAY BE REMOVED WHEN ACCEPTABLE TO THE CITY FORESTER AND SHALL BE PRUNED IN ACCORDANCE WITH THESE STANDARDS.
- ANY TREES DAMAGED OR DESTROYED DUE TO CONTRACTOR NEGLIGENCE WILL BE TREATED OR REMOVED AT THE CONTRACTOR'S EXPENSE. IF DAMAGED BEYOND REPAIR, THE CITY WILL REQUIRE REIMBURSEMENT FOR THE VALUE OF THE TREE AS DETERMINED BY THE CURRENT EDITION OF THE 'GUIDE FOR PLANT APPRAISAL' PUBLISHED BY THE INTERNATIONAL SOCIETY OF ARBORICULTURE.

EASEMENT REFERENCE **REVISIONS** COUNTY RECORDER DESCRIPTION APPROVAL/DATE CITY NO. **GRANTOR** PAGE VOL.

PREPARED BY: Stantec Consulting Services Inc. 1500 Lake Shore Drive, Suite 100 Columbus, Ohio 43204 (614) 486-4383 (614) 486-4387

GENERAL NOTES

PROJECT TITLE: CITY OF COLUMBUS DEPARTMENT OF PUBLIC UTILITIES COLUMBUS DOWNTOWN DEVELOPMENT CORPORATION DIVISION OF SEWERAGE AND DRAINAGE SCIOTO GREENWAYS PROJECT CITY OF COLUMBUS, OHIO DMSION USE ONLY DIVISION USE ONLY OWNER CONTRACTOR INSPECTOR SHEET: GN-102SCALE: NONE COMPLETED AGREEMENT RPD | CKD | CLD | CON. DF CONTRACT DRAWING NO. RECORD PLAN NO. RECORD CC - 16423

DETAIL

26. TEMPORARY SOIL EROSION AND SEDIMENT CONTROL EROSION AND SEDIMENT CONTROL MEASURES ARE REQUIRED AS A PART OF THIS PROJECT. THE EROSION AND SEDIMENTATION CONTROL REFLECTS A SCHEMATIC DIAGRAM OF THE INTENDED MEASURES FOR COMPLIANCE WITH THE REQUIRED STANDARDS. GENERAL PRACTICE AND/OR SITE FIELD CONDITIONS MAY WARRANT VARIATION IN THE PLACEMENT OR USE OF THE SPECIFIED CONTROLS. THE CONTRACTOR SHALL BE SOLELY RESPONSIBLE FOR PROVIDING NECESSARY AND ADEQUATE MEASURES FOR PROPER CONTROL OF EROSION AND SEDIMENT RUNOFF FOR THE SITE ALONG WITH PROPER MAINTENANCE AND INSPECTION IN COMPLIANCE WITH THE NPDES GENERAL PERMIT FOR STORM WATER DISCHARGES ASSOCIATED WITH

CONSTRUCTION ACTIVITY.

LAND-DISTURBING ACTIVITIES MUST COMPLY WITH ALL PROVISIONS OF THE DIVISION OF SEWERAGE AND DRAINAGE EROSION AND SEDIMENT CONTROL REGULATION. ALL LAND-DISTURBING ACTIVITIES SHALL BE SUBJECT TO INSPECTION AND SITE INVESTIGATION BY THE CITY OF COLUMBUS AND/OR THE OHIO EPA. FAILURE TO COMPLY WITH THESE REGULATIONS IS SUBJECT TO LEGAL ENFORCEMENT ACTION.

IT IS THE RESPONSIBILITY OF THE CONTRACTOR TO NOTIFY THE CITY OF COLUMBUS 48 HOURS PRIOR TO COMMENCEMENT OF INITIAL SITE LAND DISTURBANCE ON ANY SITE OF TWO OR MORE ACRES. THIS INCLUDES SITE CLEARING, GRUBBING AND ANY EARTH MOVING. PRIMARY EROSION AND SEDIMENT CONTROL PRACTICES ARE MANDATED BY REGULATION TO BE IN PLACE FROM THE BEGINNING OF THE CONSTRUCTION ACTIVITY. PLEASE CONTACT STORMWATER MANAGEMENT DIVISION BY PHONE @ 614-645-6700 OR FAX @ 614-645-1840. DETAILS OF THIS REQUIREMENT MAY BE FOUND IN THE EROSION AND SEDIMENT POLLUTION CONTROL REGULATION (ADOPTED JUNE 1, 1994). FAILURE TO COMPLY MAY RESULT IN ENFORCEMENT ACTION AS DETAILED IN THE COLUMBUS CITY CODES SECTION 1145.80.

- 27. SOIL STOCKPILES: ALL SOIL STOCKPILES SHALL BE PROTECTED FROM EROSION BY PERIMETER CONTROL DEVICES SUCH AS STRAW BALE DIKES OR SILT FENCES. THESE PERIMETER CONTROL DEVICES SHALL BE MAINTAINED THROUGHOUT THE LIFE OF THE PROJECT. EXCAVATED MATERIALS SHALL NOT BE STORED ON EXISTING PUBLIC ROADWAY PAVEMENTS. THIS INCLUDES EXCESS OR UNUSABLE EXCAVATED SOIL.
- 28. STORM SEWER INLET PROTECTION: ALL STORM SEWER INLETS SHALL BE PROTECTED FROM EXCESSIVE AMOUNTS OF SEDIMENTS USING ADEQUATE FILTERING DEVICES AS APPROVED BY THE DIVISION OF SEWERAGE AND DRAINAGE. THESE DEVICES SHALL BE MAINTAINED UNTIL THE DENUDED AREA HAS BEEN STABILIZED, OR AS DIRECTED BY THE ENGINEER. THE COST OF THIS WORK SHALL BE INCLUDED IN THE UNIT PRICE BID FOR CMSC ITEM 207 - INLET PROTECTION. STRAW OR HAY BALES ARE NOT APPROVED FOR INLET PROTECTION.
- 29. DISPOSAL OF EXCESS EXCAVATION: THE CONTRACTOR SHALL DISPOSE OF ALL EXCESS EXCAVATION. DISPOSAL OF EXCESS SOIL, DEBRIS AND MATERIALS MUST BE DONE IN AN ENVIRONMENTALLY SOUND MANNER IN ACCORDANCE WITH LOCAL, STATE, AND FEDERAL REGULATIONS. THERE SHALL BE NO DISPOSAL IN OR NEAR ANY WATER BODY, FLOODPLAIN, WETLAND, DRAINAGE COURSE OR ENVIRONMENTALLY SENSITIVE AREA, EVEN WITH PERMISSION OF THE PROPERTY OWNER. IF MATERIALS ARE DISPOSED ON PROPERTY WITHIN CITY LIMITS, THE CONTRACTOR SHALL PROVIDE A COPY OF THE SIGNED AGREEMENT AND A COPY OF THE GRADE AND FILL PERMIT OBTAINED FROM THE DEVELOPMENT DEPARTMENT.
- 30. STREET CLEANING: THE CONTRACTOR SHALL KEEP STREETS AFFECTED BY HIS CONSTRUCTION FREE OF DIRT, SEDIMENT OR MUD. THE ENGINEER MAY DIRECT THE CONTRACTOR TO PERFORM STREET CLEANING (ON AN AS-NEEDED BASIS) IS REQUIRED THROUGH THE DURATION OF THIS CONSTRUCTION PROJECT. THIS INCLUDES SWEEPING, POWER CLEANING AND (IF NECESSARY) MANUAL REMOVAL OF DIRT OR MUD IN THE STREET GUTTERS. THE COST OF THIS WORK SHALL BE INCLUDED IN THE UNIT PRICE BID FOR CMSC ITEM 207, UNLESS OTHERWISE SPECIFIED.
- 31. NON-PERFORMANCE: IN THE EVENT THAT IT BECOMES NECESSARY FOR THE CITY TO PERFORM WORK OF AN IMMEDIATE NATURE (SUCH AS THE PLACEMENT OF BARRICADES OR REPLACEMENT OF SIGNS OR OTHER WARNING OR PROTECTIVE DEVICES) REQUIRED OF THE CONTRACTOR BY THIS CONTRACT BECAUSE OF FAILURE OR REFUSAL OF THE CONTRACTOR TO PERFORM SUCH WORK, THE CONTRACTOR SHALL REIMBURSE THE CITY AT THE RATE OF 2.5 TIMES THE ACTUAL COST OF LABOR, MATERIALS, AND EQUIPMENT NECESSARY TO PERFORM SUCH WORK. IF THE CONTRACTOR REFUSES OR FAILS WITHIN A REASONABLE TIME TO PERFORM OR CAUSE THE PERFORMANCE OF SUCH WORK. THE CITY SHALL BE REIMBURSED BY THE CONTRACTOR IN THE AMOUNT PROVIDED HEREIN BY WAY OF A DEDUCTION FROM THE CONTRACTOR'S NET PAYMENT UNDER THE CONTRACT. REASONABLE TIME

FOR ALL STREETS INVOLVED ON THIS CONTRACT IS 1 HOUR FROM THE TIME OF NOTIFICATION BY THE CITY.

32. FOR AMERICAN ELECTRIC POWER (AEP) TRANSMISSION: THE CONTRACTOR SHALL CONTACT AEP TRANSMISSION'S FIELD REPRESENTATIVE, DINO JULIAN, AT 740-503-2819 PRIOR TO THE PRE-CONSTRUCTION MEETING AND A MINIMUM OF 48 HOURS PRIOR TO ANY CONSTRUCTION ACTIVITY IN THE VICINITY OF AEP'S BURIED TRANSMISSION LINES.

THE CONTRACTOR SHALL USE EXTREME CAUTION WHILE WORKING IN THE VICINITY OF AEP'S BURIED TRANSMISSION LINES. THE CONTRACTOR SHALL ALSO UTILIZE THE FOLLOWING CONSTRUCTION PRACTICES:

DO NOT INSTALL TREES OR SHRUBS WITHIN 10 FEET ON EITHER SIDE OF THE BURIED TRANSMISSION LINES.

33. FOR THE DIVISION OF POWER: THE DIVISION OF POWER (DOP) HAS UNDERGROUND PRIMARY, SECONDARY AND STREET LIGHTING AT THIS WORK SITE. THE CONTRACTOR IS HEREBY REQUIRED TO CONTACT OUPS AT 1-800-362-2764 FOURTY-EIGHT HOURS PRIOR TO CONDUCTING ANY ACTIVITY WITHIN THE CONSTRUCTION AREA. THE DOP DISPATCH OFFICE NUMBER IS (614) 645-7627 (VOICE).

ANY REQUIRED RELOCATION, SUPPORT, PROTECTION, OR ANY OTHER ACTIVITY CONCERNED WITH THE CITY'S ELECTRICAL FACILITIES IN THE CONSTRUCTION AREA IS TO BE PERFORMED BY THE CONTRACTOR UNDER THE DIRECTION OF DOP PERSONNEL AND AT THE EXPENSE OF THE PROJECT. DOP SHALL MAKE ALL FINAL CONNECTIONS TO DOP'S EXISTING ELECTRICAL SYSTEM AT THE EXPENSE OF THE PROJECT. THE CONTRACTOR SHALL USE MATERIALS AND MAKE REPAIRS TO A CITY OF COLUMBUS STREET LIGHTING SYSTEM BY FOLLOWING DOP'S "MATERIAL AND INSTALLATION SPECIFICATIONS" (MIS) AND THE CITY OF COLUMBUS "CONSTRUCTION AND MATERIAL SPECIFICATIONS" (CMS). ANY NEW OR RE-INSTALLED UNDERGROUND STREETLIGHT SYSTEM SHALL REQUIRE TESTING AS REFERRED TO IN SECTION 1000.18 OF THE CMS MANUAL. THE CONTRACTOR SHALL CONFORM TO DOP'S EXISTING CONDUCTOR SAFETY POLICY AND HOLD CARD SYSTEM, MIS-95, COPIES OF WHICH ARE AVAILABLE FROM DOP. IF YOU HAVE ANY QUESTIONS, CALL MIHAI ORBOCEA AT (614) 645-6851 OR CHRIS VOGEL AT (614) 645-6963.

IF ANY ELECTRIC FACILITY BELONGING TO DOP IS DAMAGED IN ANY MANNER BY THE CONTRACTOR. ITS AGENTS. SERVANTS. OR EMPLOYEES. AND REQUIRES EMERGENCY REPAIRS, DOP SHALL MAKE ALL NECESSARY REPAIRS, AND THE EXPENSE OF SUCH REPAIRS AND OTHER RELATED COSTS SHALL BE PAID BY THE CONTRACTOR TO THE DIVISION OF POWER, CITY OF COLUMBUS, OHIO.

34. FOR CSX AND NORFOLK SOUTHERN RAILROAD:

- A. THE OHIO UTILITIES PROTECTION SERVICE (OUPS) DOES NOT LOCATE BURIED RAILROAD SIGNAL AND COMMUNICATIONS LINES. THE CONTRACTOR SHALL CONTACT THE RAILROAD'S REPRESENTATIVE TWO (2) DAYS IN ADVANCE OF THOSE PLACES WHERE EXCAVATION, PILE DRIVING, OR HEAVY LOADS MAY DAMAGE RAILROAD UNDERGROUND LINES ON RAILROAD PROPERTY. UPON REQUEST FROM THE CONTRACTOR OR AGENCY, RAILROAD SIGNAL FORCES WILL LOCATE AND PAINT MARK OR FLAG RAILROAD UNDERGROUND SIGNAL, COMMUNICATION, AND POWER LINES IN THE AREA TO BE DISTURBED FOR THE CONTRACTOR. THE CONTRACTOR SHALL AVOID EXCAVATION OR OTHER DISTURBANCE OF THESE LINES WHICH ARE CRITICAL TO THE SAFETY OF THE RAILROAD AND THE PUBLIC. IF DISTURBANCE OR EXCAVATION IS REQUIRED NEAR A BURIED RAILROAD SIGNAL, COMMUNICATION OR POWER LINE, THE LINE SHALL BE POTHOLED MANUALLY WITH CAREFUL HAND EXCAVATION BY THE CONTRACTOR AND PROTECTED BY THE CONTRACTOR DURING THE COURSE OF THE DISTURBANCE UNDER THE SUPERVISION AND DIRECTION OF A RAILROAD SIGNAL REPRESENTATIVE.
- ALL WORK ON, OVER, UNDER, OR ADJACENT TO NORFOLK SOUTHERN OR CSX RIGHT-OF-WAY SHALL BE DONE IN ACCORDANCE WITH THE NORFOLK SOUTHERN "SPECIAL PROVISIONS FOR THE PROTECTION OF RAILWAY INTERESTS" (NS SPECIAL PROVISIONS), OR WITH THE CSXT "SPECIAL PROVISIONS."
- THE PROPOSED RIVERBED GRADING SHALL NOT REDUCE THE AMOUNT OF COVER AGAINST THE RAILROAD BRIDGE PIERS. ANY ACTIVITY THAT MAY EXPOSE THE BRIDGE PIER PILINGS SHALL BE AVOIDED.

35. SITE DATA

COLUMBUS DOWNTOWN DEVELOPMENT CORPORATION OWNER/DEVELOPER:

150 SOUTH FRONT STREET, SUITE 210

COLUMBUS, OHIO 43215

PLAN DESIGNER:

STANTEC CONSULTING SERVICES INC. 1500 LAKE SHORE DRIVE, SUITE 100 COLUMBUS, OHIO 43204 CONTACT: BRYON RINGLEY EMAIL: BRYON.RINGLEY@STANTEC.COM PHONE: 614-486-4383 FAX: 614-486-1351

OHIO EPA NOI: OHC 000004

PROJECT TYPE: DAM REMOVAL/STREAM RESTORATION

SCIOTO RIVER

ADJACENT AREAS: SITE IS BOUNDED ON THE EAST BY CIVIC CENTER DRIVE AND MARCONI BOULEVARD AND, ON THE WEST BY VETERANS MEMORIAL AND WASHINGTON BOULEVARD, AND EXTENDS NORTH AND SOUTH ALONG THE SCIOTO RIVER.

UW - URBAN LAND-GENESEE COMPLEX. OCCASIONALLY FLOODED SOILS: UX - URBAN LAND-OCKLEY COMPLEX, 0-6% SLOPES

APPROXIMATE AREA OF DISTURBANCE: 75.1 ACRES

36. GENERAL LAND CONSERVATION NOTES

NO DISTURBED AREA WILL BE DENUDED FOR MORE THAN 7 DAYS IF IT IS TO REMAIN DORMANT FOR MORE THAN 21 DAYS UNLESS AUTHORIZED BY THE GOVERNING JURISDICTION'S INSPECTOR. PERMANENT OR TEMPORARY SOIL STABILIZATION SHALL BE APPLIED TO DISTURBED AREAS WITHIN 7 DAYS AFTER FINAL GRADE IS REACHED ON ANY PORTION OF THE SITE.

ALL STRUCTURAL EROSION AND SEDIMENT CONTROL PRACTICES SHALL BE PLACED PRIOR TO OR AS THE FIRST STEP IN GRADING FOR ALL SITES.

ALL STORM SEWER, SANITARY SEWER, WATER MAIN AND SERVICE TRENCHES SHALL BE MULCHED AND SEEDED WITHIN 14 DAYS AFTER BACKFILL IF INSTALLATION IS THROUGH STABILIZED AREAS. NO MORE THAN 500 FEET OF TRENCH WILL BE OPEN AT ANY ONE

ELECTRIC POWER, TELEPHONE, CATV AND GAS SUPPLY TRENCHES SHALL BE COMPACTED SEEDED AND MULCHED WITHIN 14 DAYS AFTER BACKFILL. IF INSTALLATION IS THROUGH STABILIZED AREAS.

ALL TEMPORARY DIVERSIONS. SEDIMENT BASIN EMBANKMENTS AND EARTH STOCKPILES SHALL BE SEEDED AND MULCHED FOR TEMPORARY VEGETATIVE COVER WITHIN 7 DAYS AFTER GRADING. STRAW, HAY MULCH OR EQUIVALENT IS REQUIRED.

ALL STORM SEWER INLETS SHALL BE PROTECTED BY SEDIMENT TRAPS (INLET PROTECTION) WHICH WILL BE MAINTAINED AND MODIFIED AS REQUIRED AS CONSTRUCTION PROGRESSES.

ANY DISTURBED AREA NOT STABILIZED WITH SEEDING, SODDING, PAVING OR BUILT UPON BY NOVEMBER 1ST, OR AREAS DISTURBED AFTER THAT DATE, SHALL BE MULCHED IMMEDIATELY WITH HAY OR STRAW AT THE RATE OF 2 TONS PER ACRE AND OVER-SEEDED BY APRIL 15TH.

AT THE COMPLETION OF CONSTRUCTION, ALL TEMPORARY SEDIMENT CONTROLS SHALL BE REMOVED AND ALL DENUDED AREAS SHALL BE STABILIZED.

MAINTENANCE NOTES

ALL EROSION AND SEDIMENT CONTROL MEASURES WILL BE CHECKED BY THE OWNER'S REPRESENTATIVE WEEKLY AND WITHIN 24 HOURS AFTER EACH RAINFALL TO ASSURE THAT THE MEASURES ARE FUNCTIONING ADEQUATELY. SEDIMENT THAT IS COLLECTED WILL BE DISTRIBUTED ON THE PROTECTED PORTION OF THE SITE AND STABILIZED. ALL STOCKPILES OF EARTH AND TOPSOILS WILL BE PROTECTED WITH TEMPORARY SEEDING OR OTHER MEANS TO PREVENT EROSION.

INLET PROTECTION (IP)

THE STRUCTURE SHALL BE INSPECTED AFTER EACH RAIN, AND REPAIRS MADE AS NEEDED. SEDIMENT SHALL BE REMOVED AND THE TRAP RESTORED TO ITS ORIGINAL DIMENSIONS WHEN THE SEDIMENT HAS ACCUMULATED TO 1/2 THE DESIGN DEPTH OF THE TRAP. REMOVED SEDIMENT SHALL BE DEPOSITED IN A SUITABLE AREA AND IN SUCH A MANNER THAT IT WILL NOT ERODE.

STREET CLEANING

STREET CLEANING (ON AN AS-NEEDED BASIS) IS REQUIRED THROUGH THE DURATION OF THIS CONSTRUCTION PROJECT. THIS INCLUDES SWEEPING, POWER CLEANING AND (IF NECESSARY) MANUAL REMOVAL OF DIRT OR MUD IN THE STREET GUTTERS.

STRAW WATTLES

THE USE OF STRAW WATTLES HAS PROVEN TO BE A VERSATILE AND EFFECTIVE ESC. BMP. STRAW WATTLES MAY BE SUBSTITUTED FOR SILT FENCE IN LINEAR INSTALLATIONS.

PROJECT TITLE:

LEGEND

GAS VALVE SANITARY LINE SANITARY MANHOLE CLEANOUT STORM LINE

GAS LINE

CATCHBASIN

FIRE HYDRANT

STORM MANHOLE WATER LINE WATER VALVE

STATUE

OVERHEAD ELECTRIC LIGHTING UNDERGROUND ELECTRIC LIGHTING UNLESS OTHERWISE NOTED OVERHEAD ELECTRIC PRIMARY

ELECTRIC PULL BOX

NOTE: ALL ELECTRIC LINES,

ON THE PLANS, ARE OWNED

BY THE CITY OF COLUMBUS

DIVISION OF POWER.

UNDERGROUND ELECTRIC PRIMARY

ELECTRIC MANHOLE

LIGHT

POWER POLE FLOOD LIGHT

TRAFFIC MANHOLE

TRAFFIC POLE

DECIDUOUS TREE

CONIFEROUS TREE

FLAG POLE

BUSHES YARD DRAIN IRRAGATION VALVE

BOLLARD WITH LIGHT

SPRINKLER HEAD

BOLLARD SIGN ____

----- EDGE OF WATER $-\!\!\times\!\!-\!\!\times\!\!-\!\!\times\!\!-\!\!\times\!\!-\!\!\times\!\!-\!\!\times\!\!-\!\!\times\!\!-\!\!$

EX. FORCE MAIN

EX. CONTOUR (MAJOR) ----712---- EX. CONTOUR (MINOR) PROPERTY LINES

PROPERTY LOTS PROPERTY EASEMEN

RIGHT OF WAY PROP. FORCE MAIN

FLOODWAY 1% ANNUAL FLOOD BOUNDARY ---- 0.2% ANNUAL FLOOD BOUNDARY

10YR PROP. ANNUAL FLOOD BOUNDARY PROP. BANKFULL

.___.__. TOE WOOD WITH <u>/1</u> SOIL LIFTS CR-118 -x-x-x-x- ROCK TOE PROTECTION

WITH SOIL LIFTS SOIL LIFTS RIFFLE ARMOR

> PROP. RETAINING WALL (SEE SHEETS S-101 TO S-139)

Stantec Consulting Services Inc. 1500 Lake Shore Drive, Suite 100 Columbus, Ohio 43204 (614) 486-4383


GENERAL NOTES AND LEGEND


CITY OF COLUMBUS DEPARTMENT OF PUBLIC UTILITIES COLUMBUS DOWNTOWN DEVELOPMENT CORPORATION DIVISION OF SEWERAGE AND DRAINAGE SCIOTO GREENWAYS PROJECT CITY OF COLUMBUS, OHIO DMSION USE ONLY DIVISION USE ONLY OWNER CONTRACTOR INSPECTOR SHEET: GN-103 SCALE: NONE COMPLETED AGREEMENT RPD | CKD | CLD | CON. DF CONTRACT DRAWING NO. RECORD PLAN NO. RECORD CC - 16423DETAIL


SITE DRAINS TO: EASEMENT REFERENCE **REVISIONS** COUNTY RECORDER DESCRIPTION APPROVAL/DATE CITY NO. **GRANTOR** PAGE


PREPARED BY: (614) 486-4387



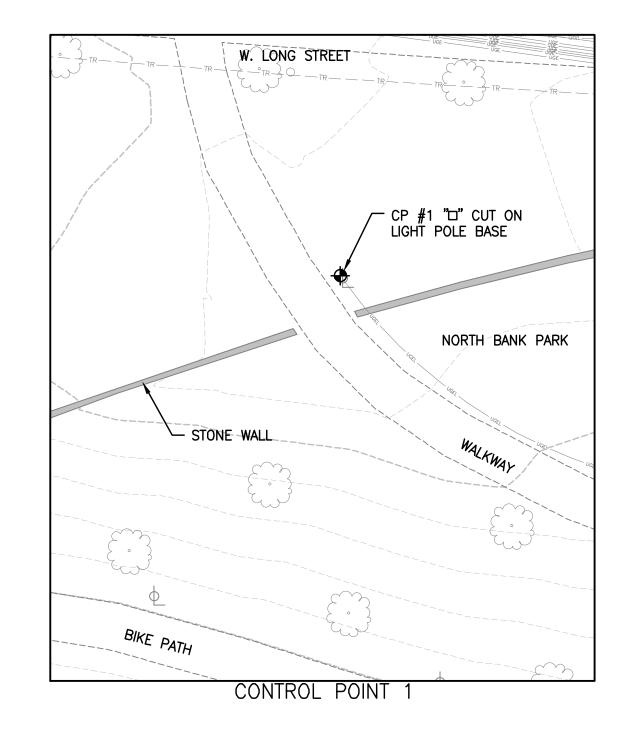

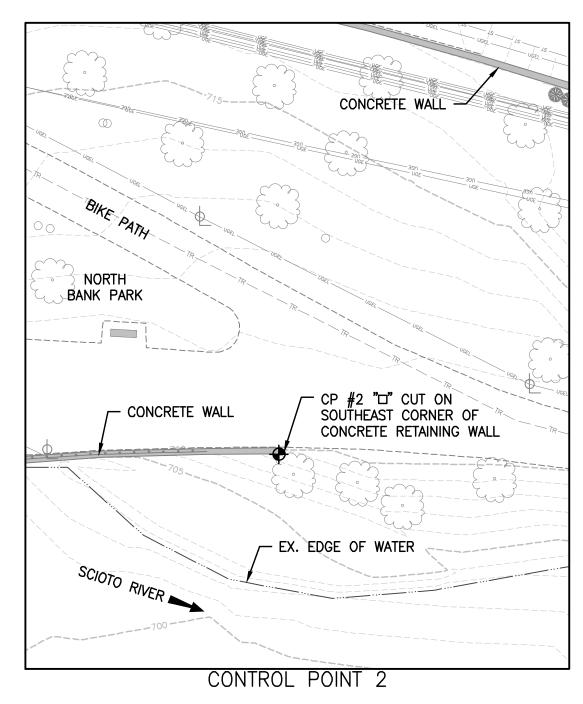


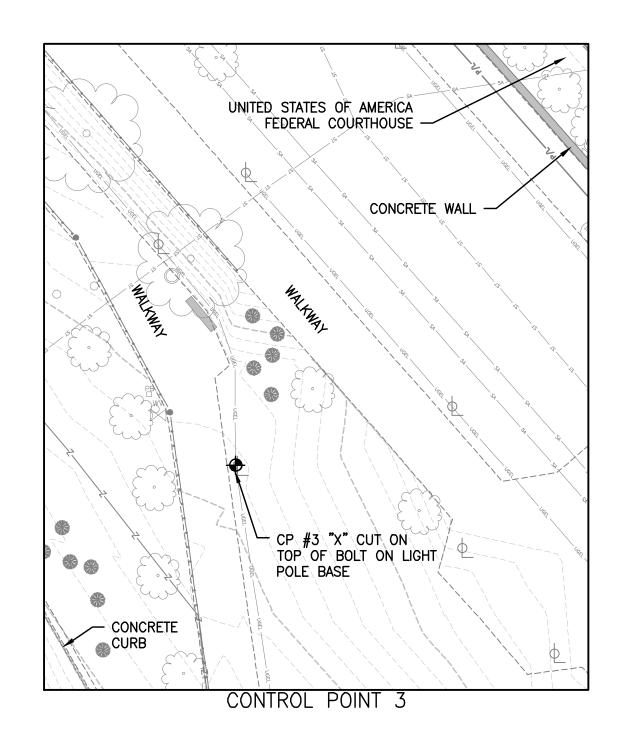


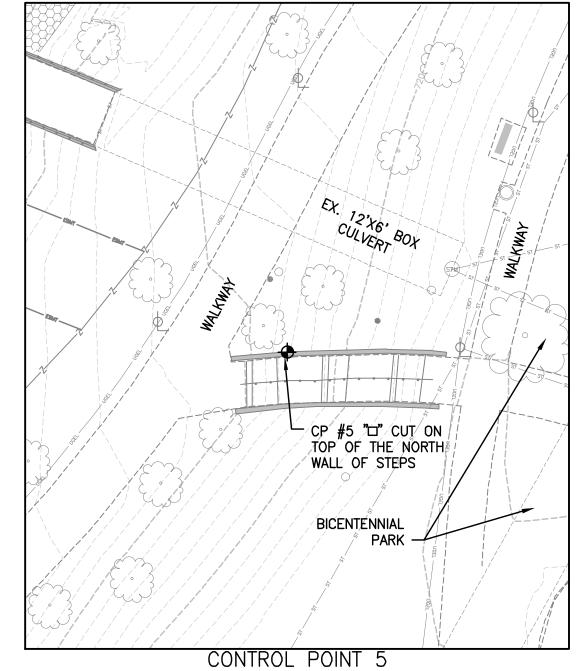



CONTROL POINT TABLE								
POINT NUMBER	NORTHING	EASTING	ELEVATION					
CP 1	716,187.42	1,824,912.34	716.99					
CP 2	716,098.69	1,825,908.79	711.29					
CP 3	715,561.67	1,826,686.79	716.32					
CP 5	712,876.21	1,826,970.29	719.30					
CP 6	713,029.09	1,826,294.26	724.72					
CP 8	715,591.35	1,825,438.69	719.28					
CP 9	715,515.40	1,824,180.09	730.90					
CP 10	715,439.84	1,823,183.91	720.69					

CONTROL POINTS SHOWN ARE BASED ON THE OHIO STATE PLANE, OHIO SOUTH ZONE (ZONE 3402) COORDINATE SYSTEM, REFERENCED TO THE NORTH AMERICAN DATUM OF 1983 (NAD83) WITH THE NSRS 2007 ADJUSTMENT. ALL ELEVATIONS ARE REFERENCED TO THE NORTH AMERICAN VERTICAL DATUM OF 1988 (NAVD88).

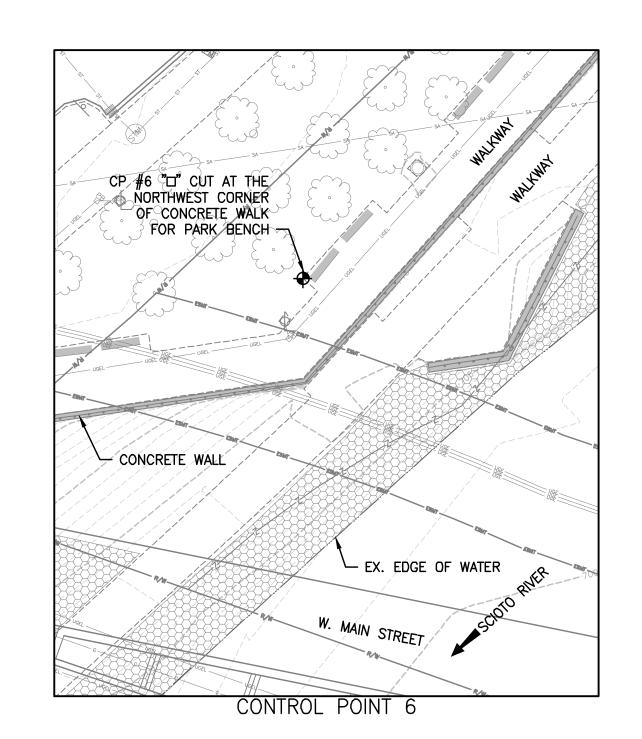

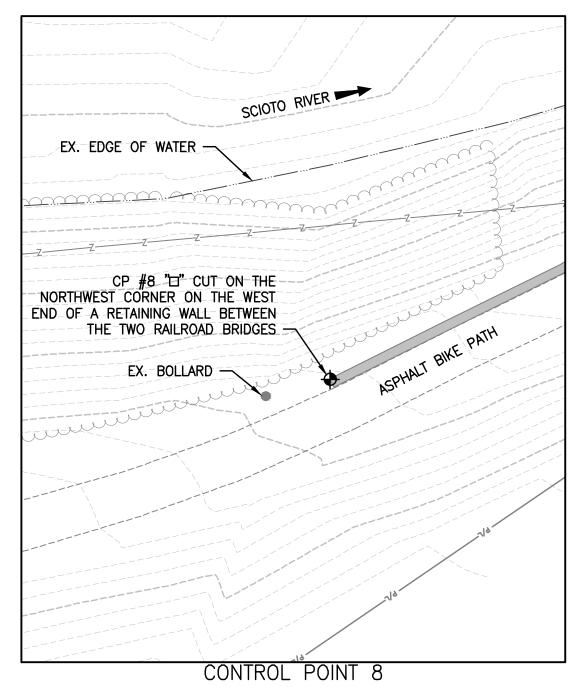

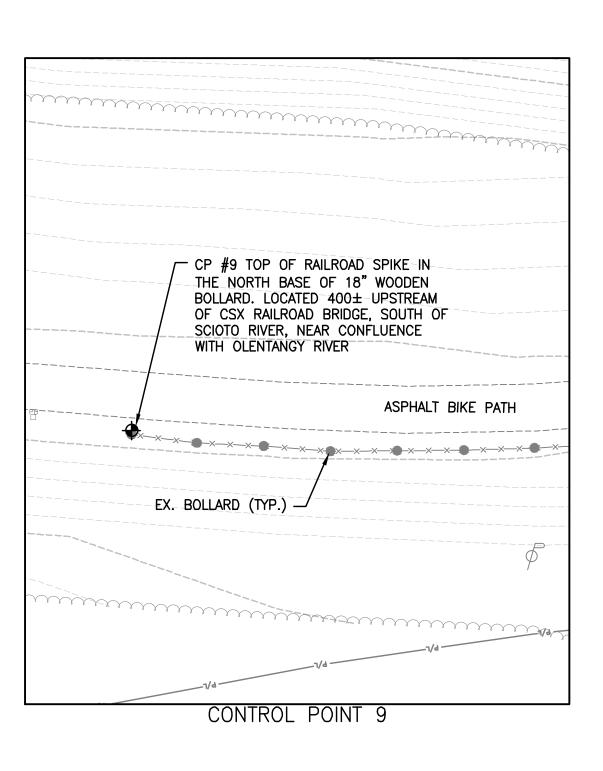

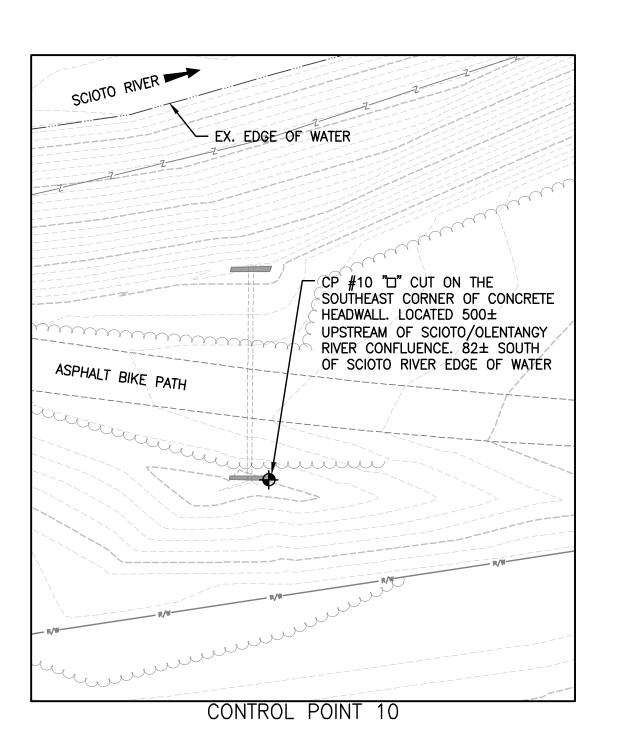



EASEMENT REFERENCE			REVISIONS			
CITY NO.	COUNTY F	RECORDER	GRANTOR	NO.	DESCRIPTION	APPROVAL/DATE
CIT NO.	VOL.	PAGE	GIOWION			


	PREPARED BY:	
Stantec	Stantec Consulting Services 1500 Lake Shore Drive, Suite 100 Columbus, Ohio 43204 (614) 486-4383 (614) 486-4387	Inc.
LANDSCAPE ARCHITECTURE 4		


CONTROL POINTS


				0 10' 20' 1"=20'
PROJECT TITLE: COLUMBUS DOWNTOWN DEVELOPMENT COR SCIOTO GREENWAYS PROJECT CITY OF COLUMBUS, OHIO	PORATION		DEPARTMENT OF DIVISION OF SEWER	COLUMBUS PUBLIC UTILITIES PAGE AND DRAINAGE USE ONLY
DIVISION USE ONLY	01	VNER		
	CONT	RACTOR		
	INSPECTOR		SCALE: 1" = 20'	surer. V 101
	AGREEMENT	COMPLETED	SCALE: I = 20	SHEET: V-101
	RPD CKD	CLD CON. DR.	CONTRACT DRAWING NO.	RECORD PLAN NO.
	INDEX DETAIL	RECORD FILE	CC-16423	

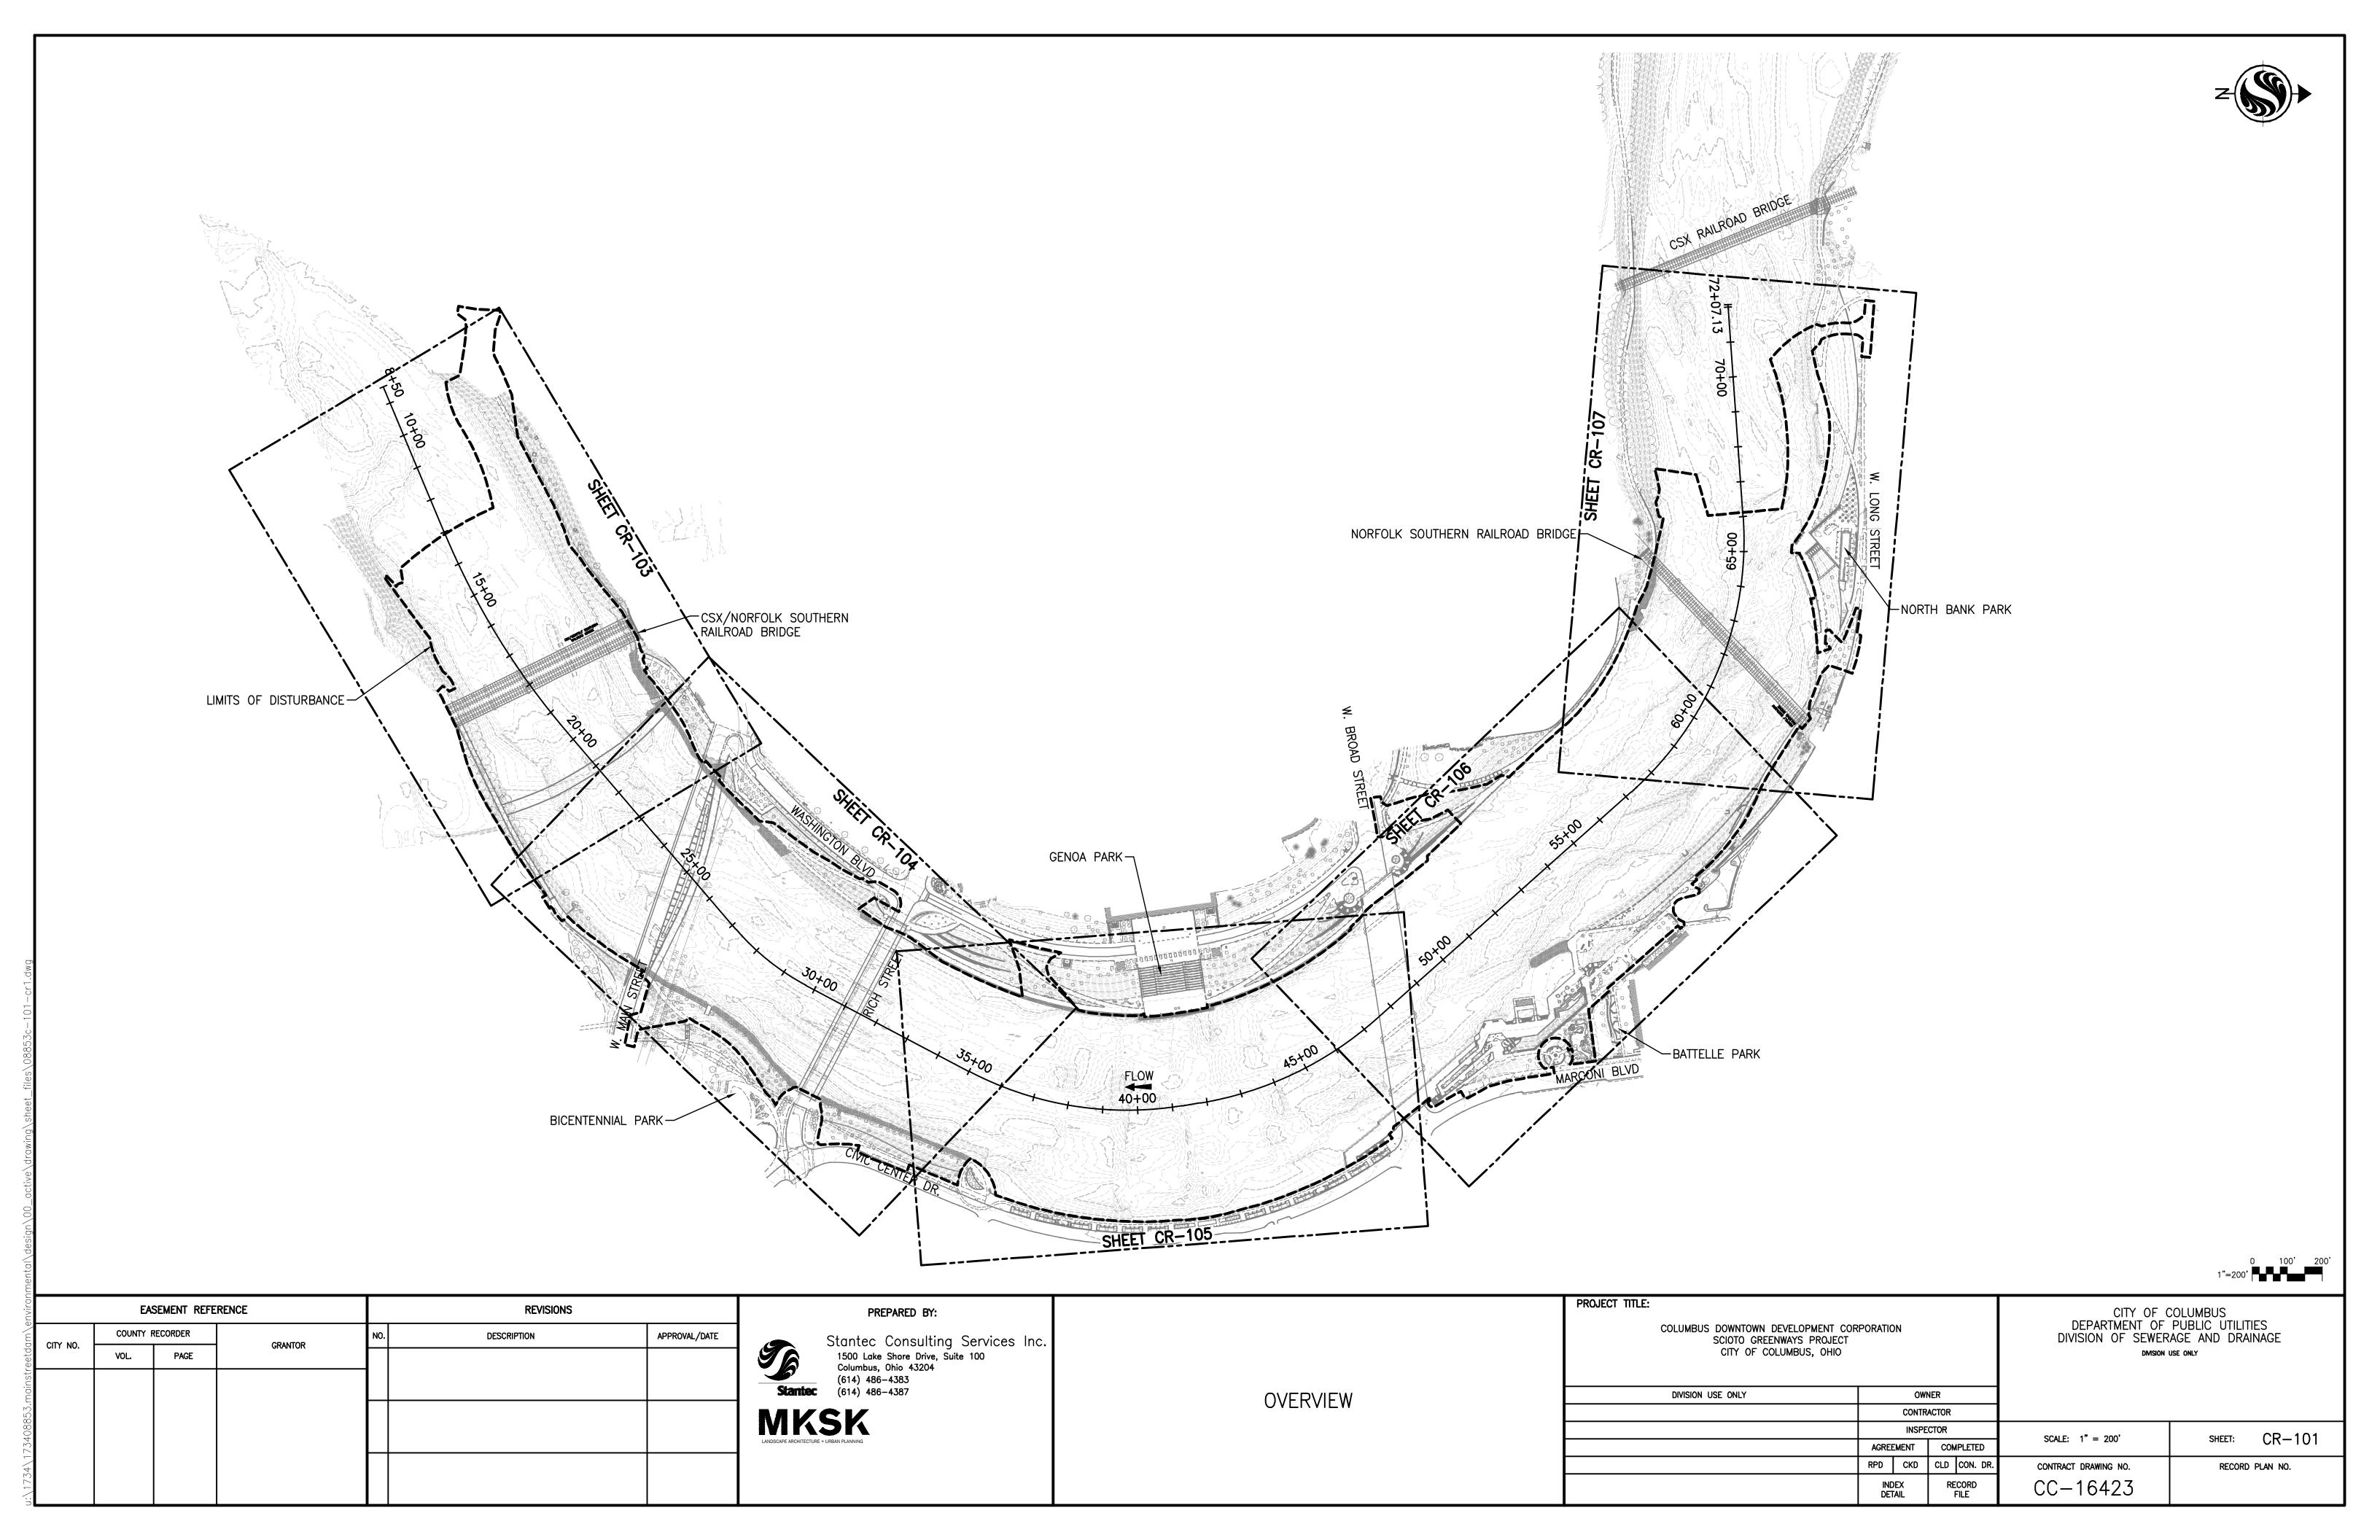


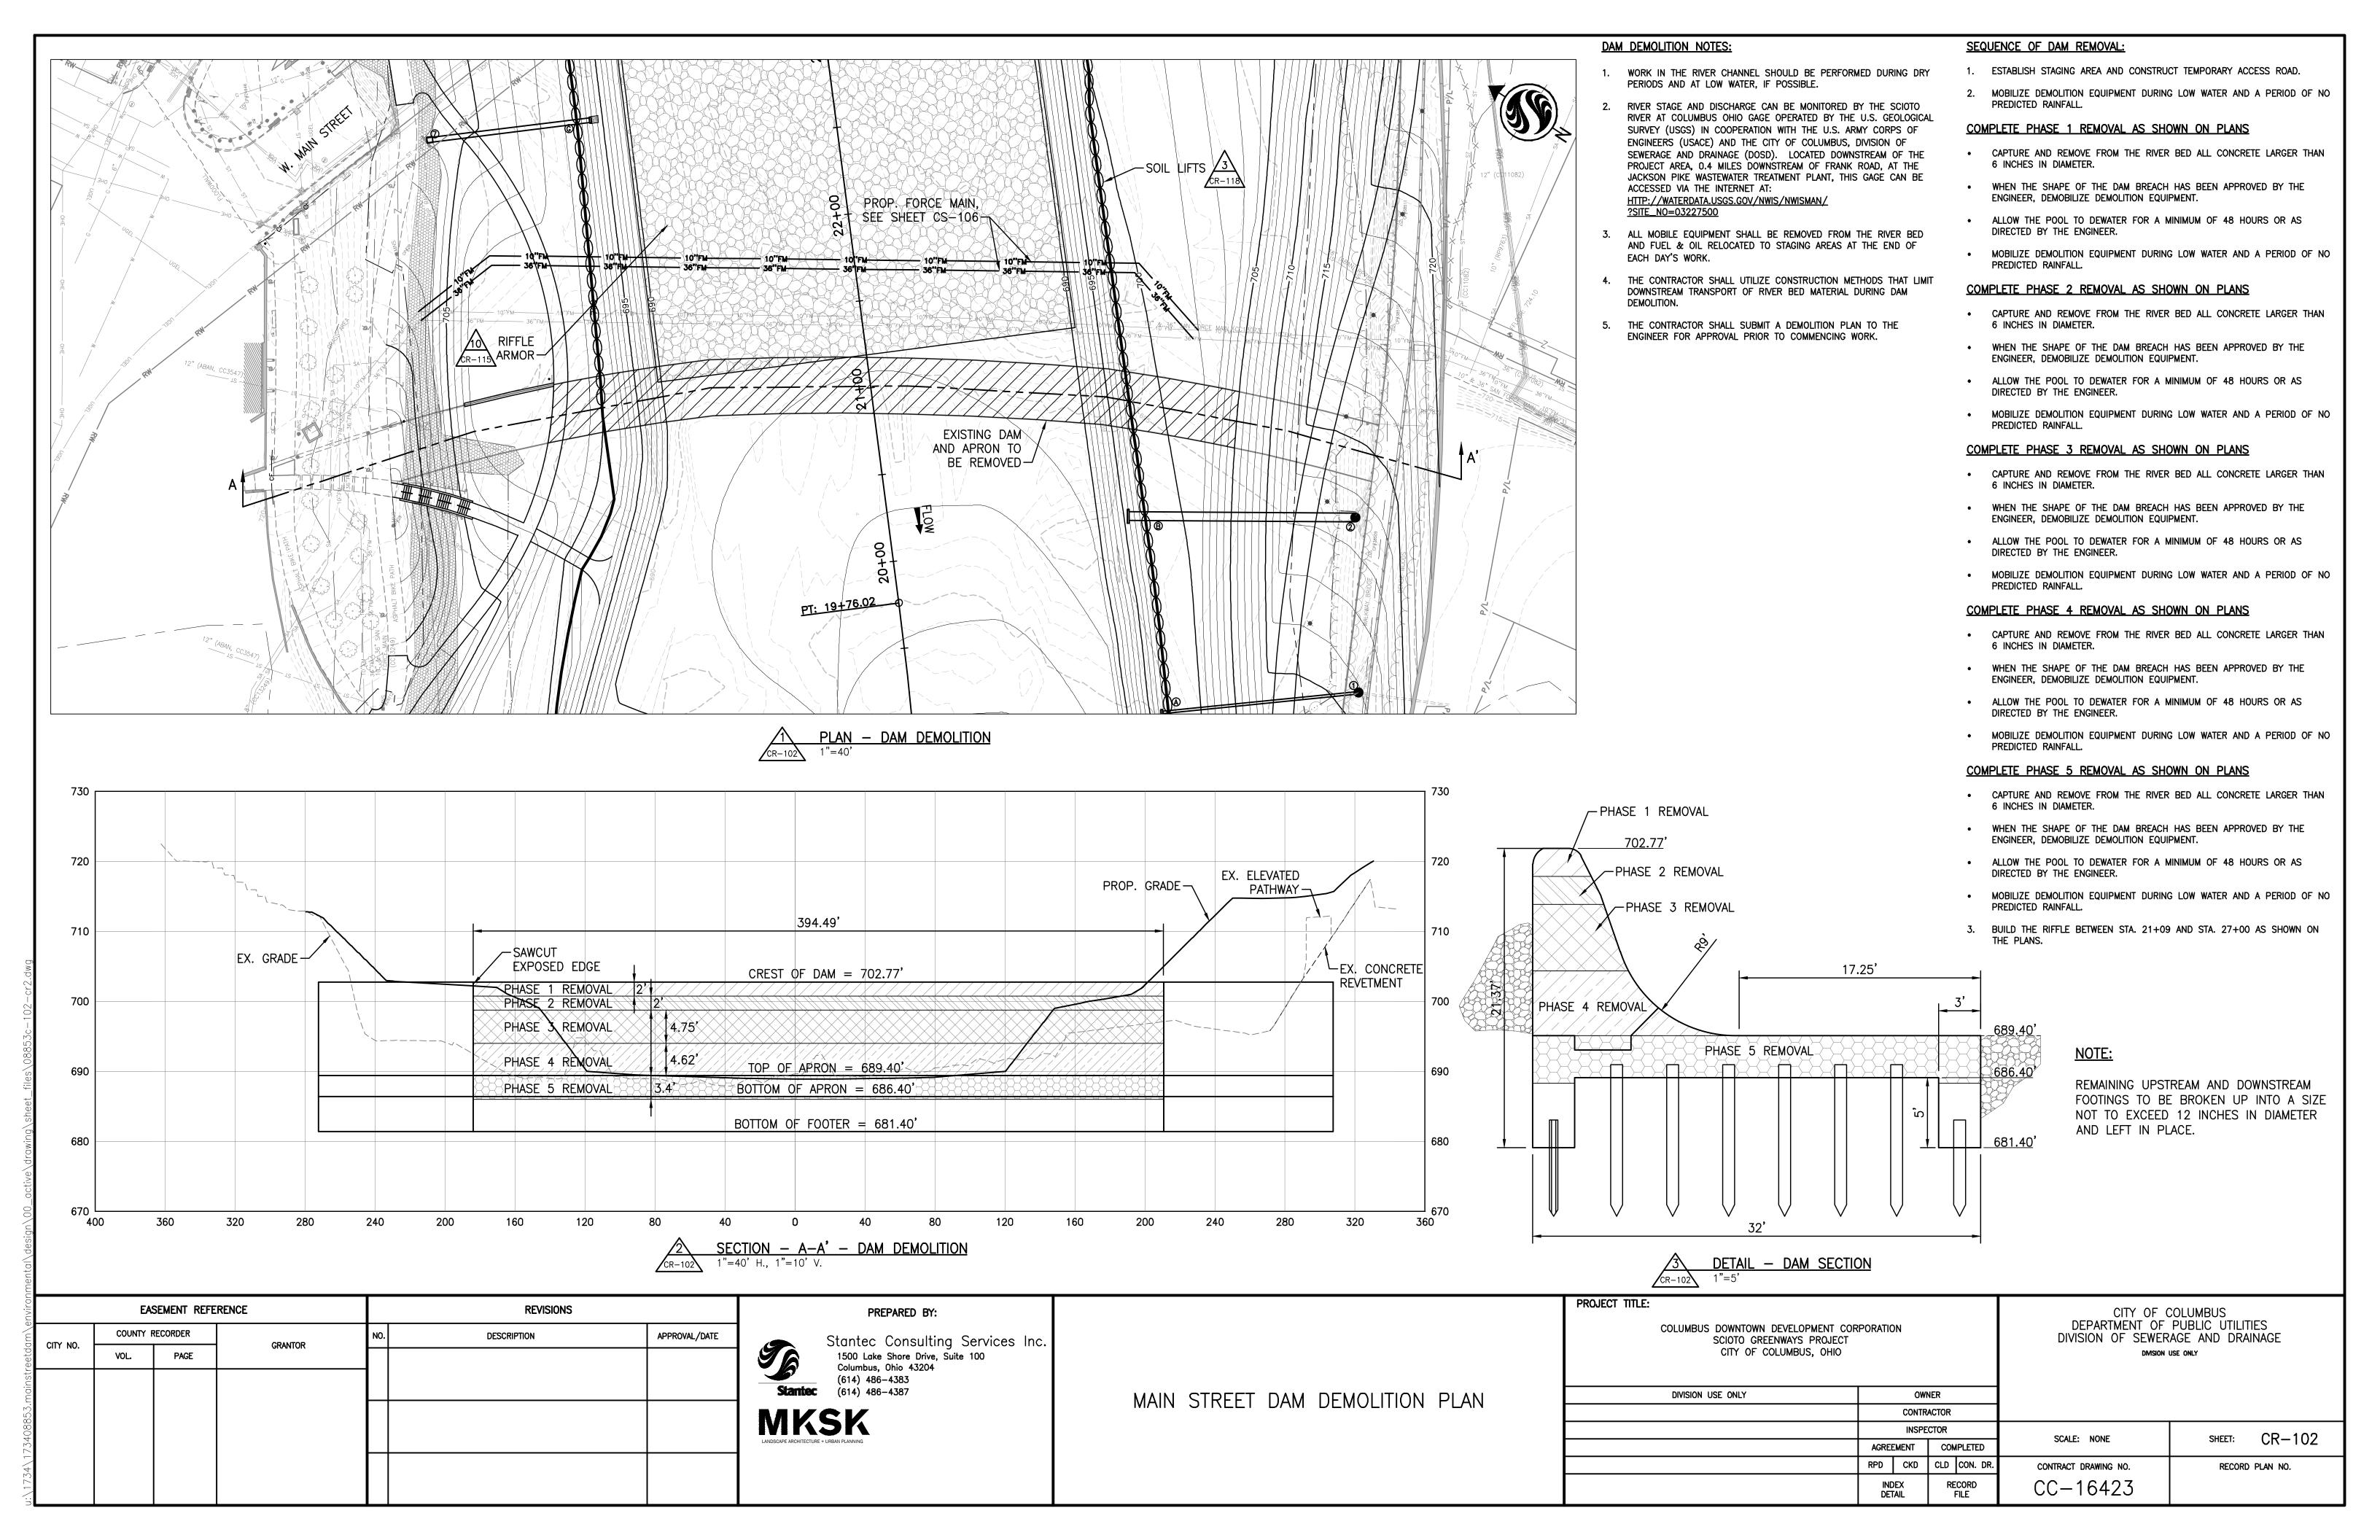


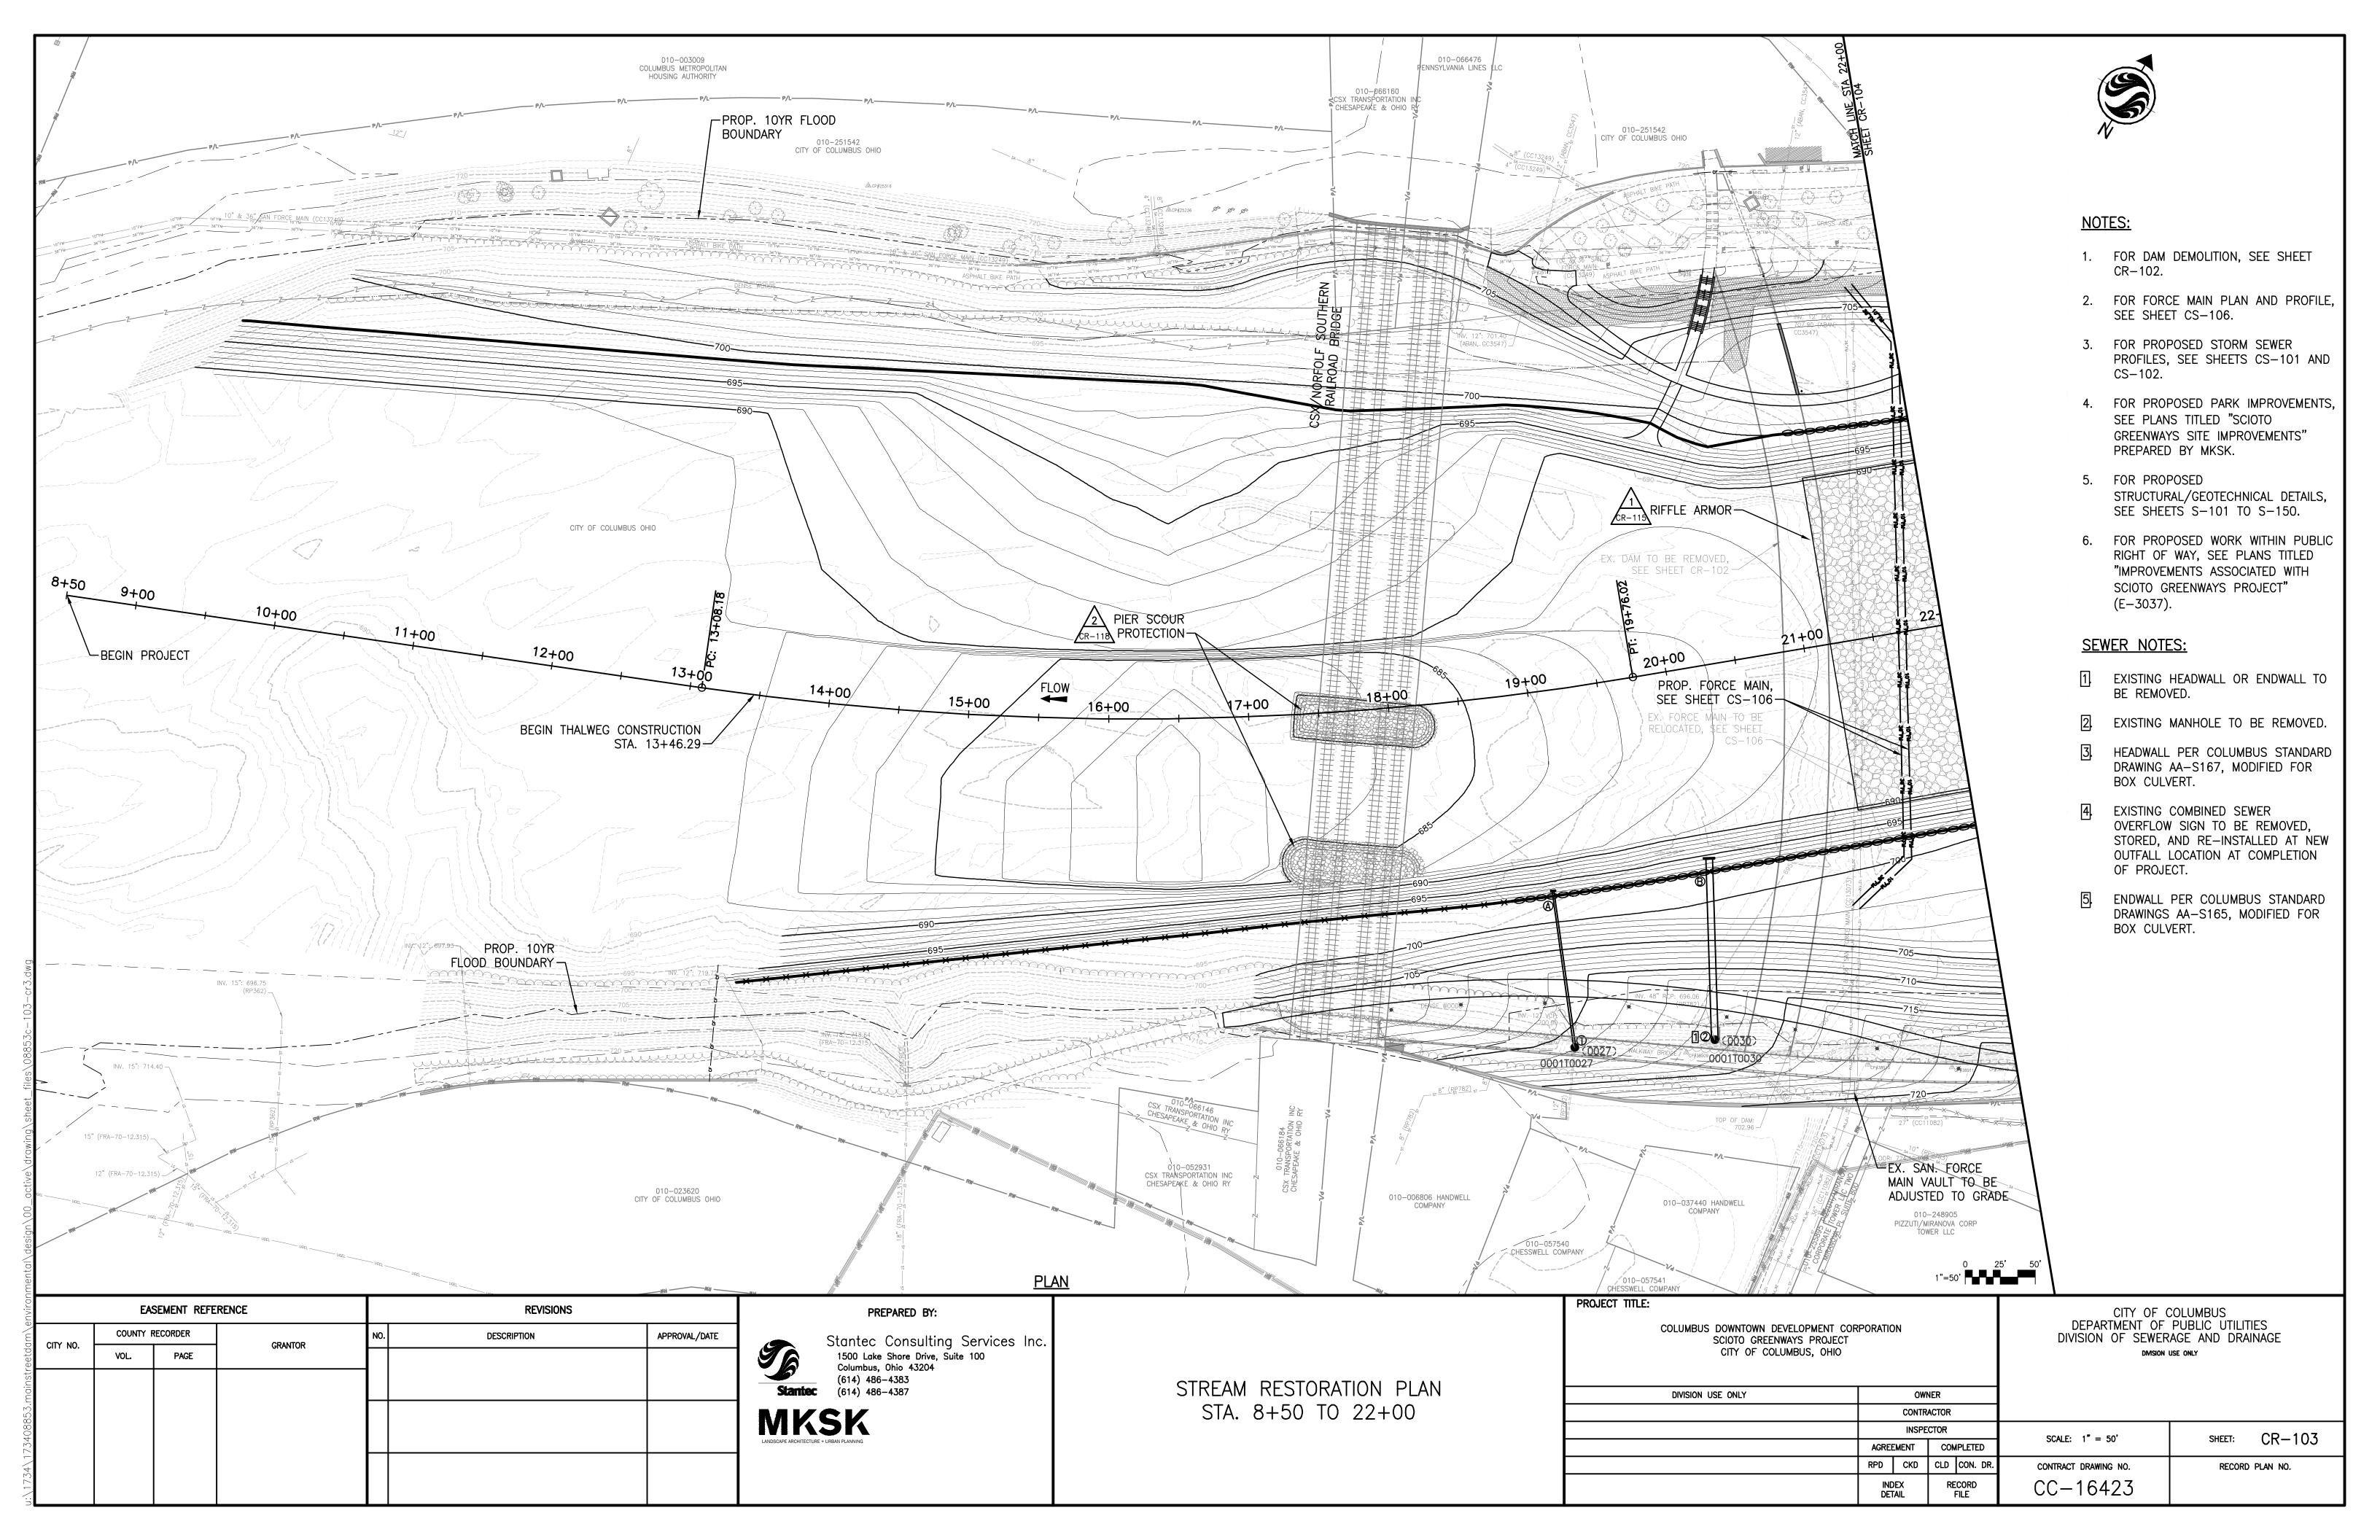


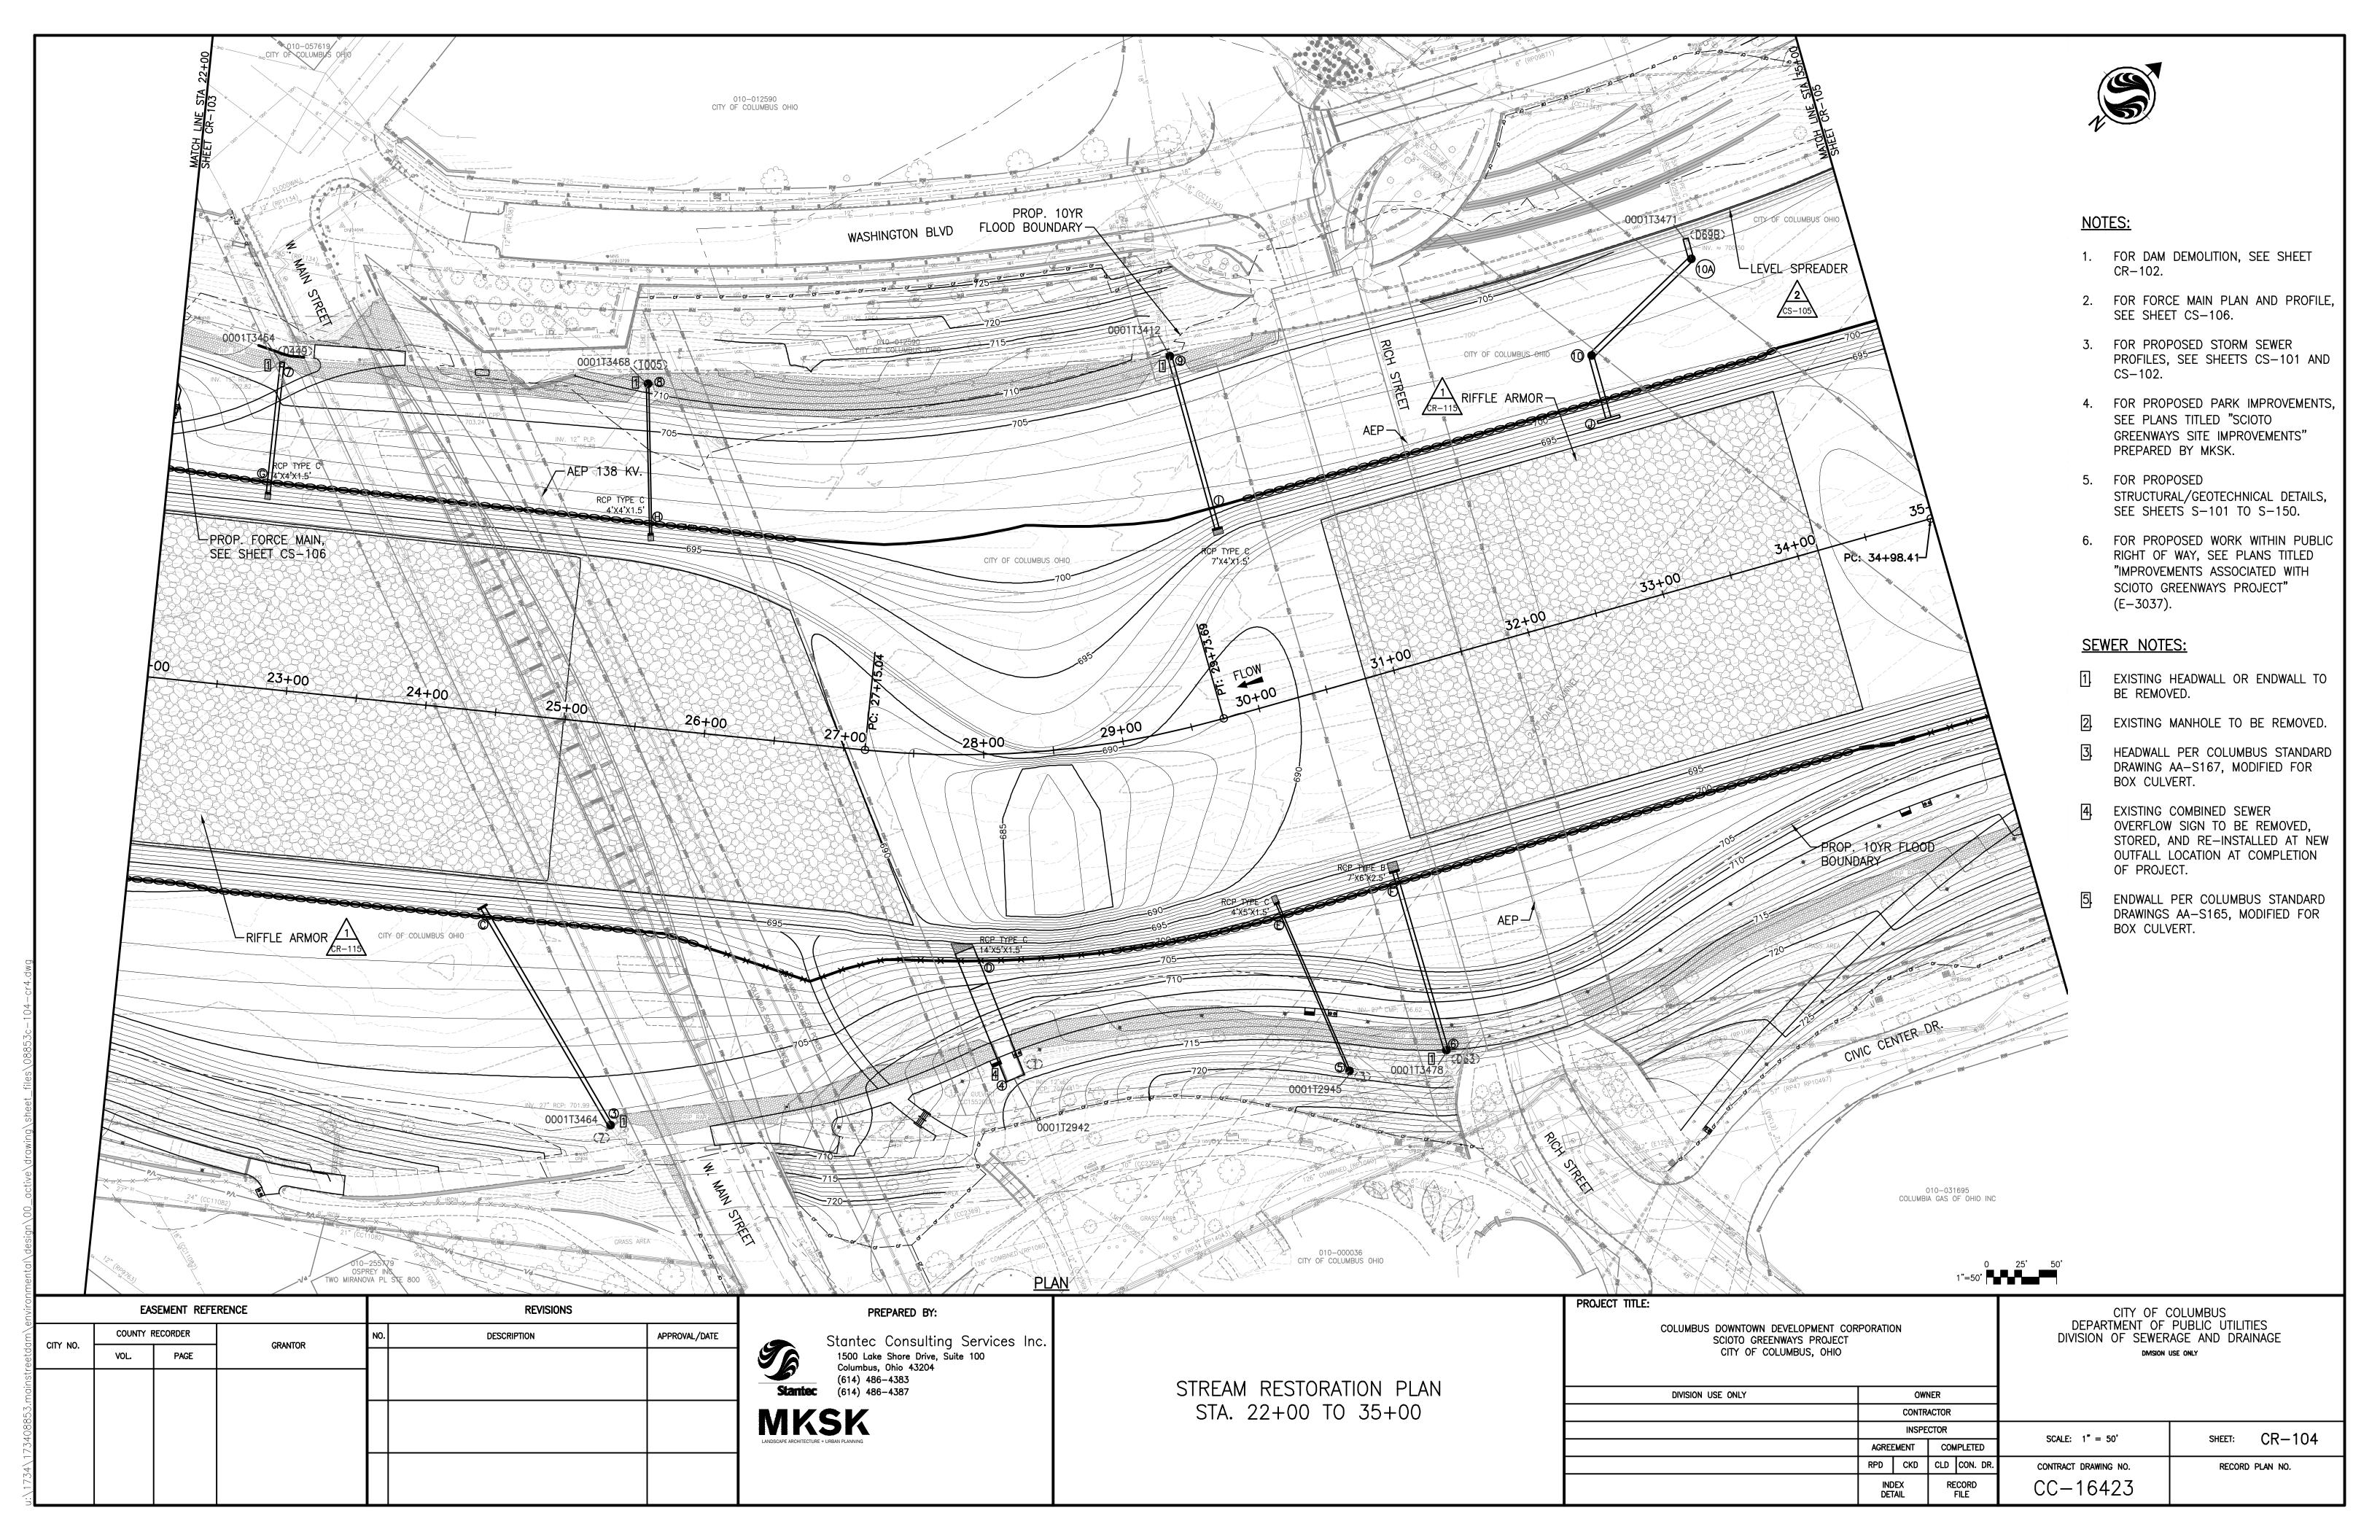


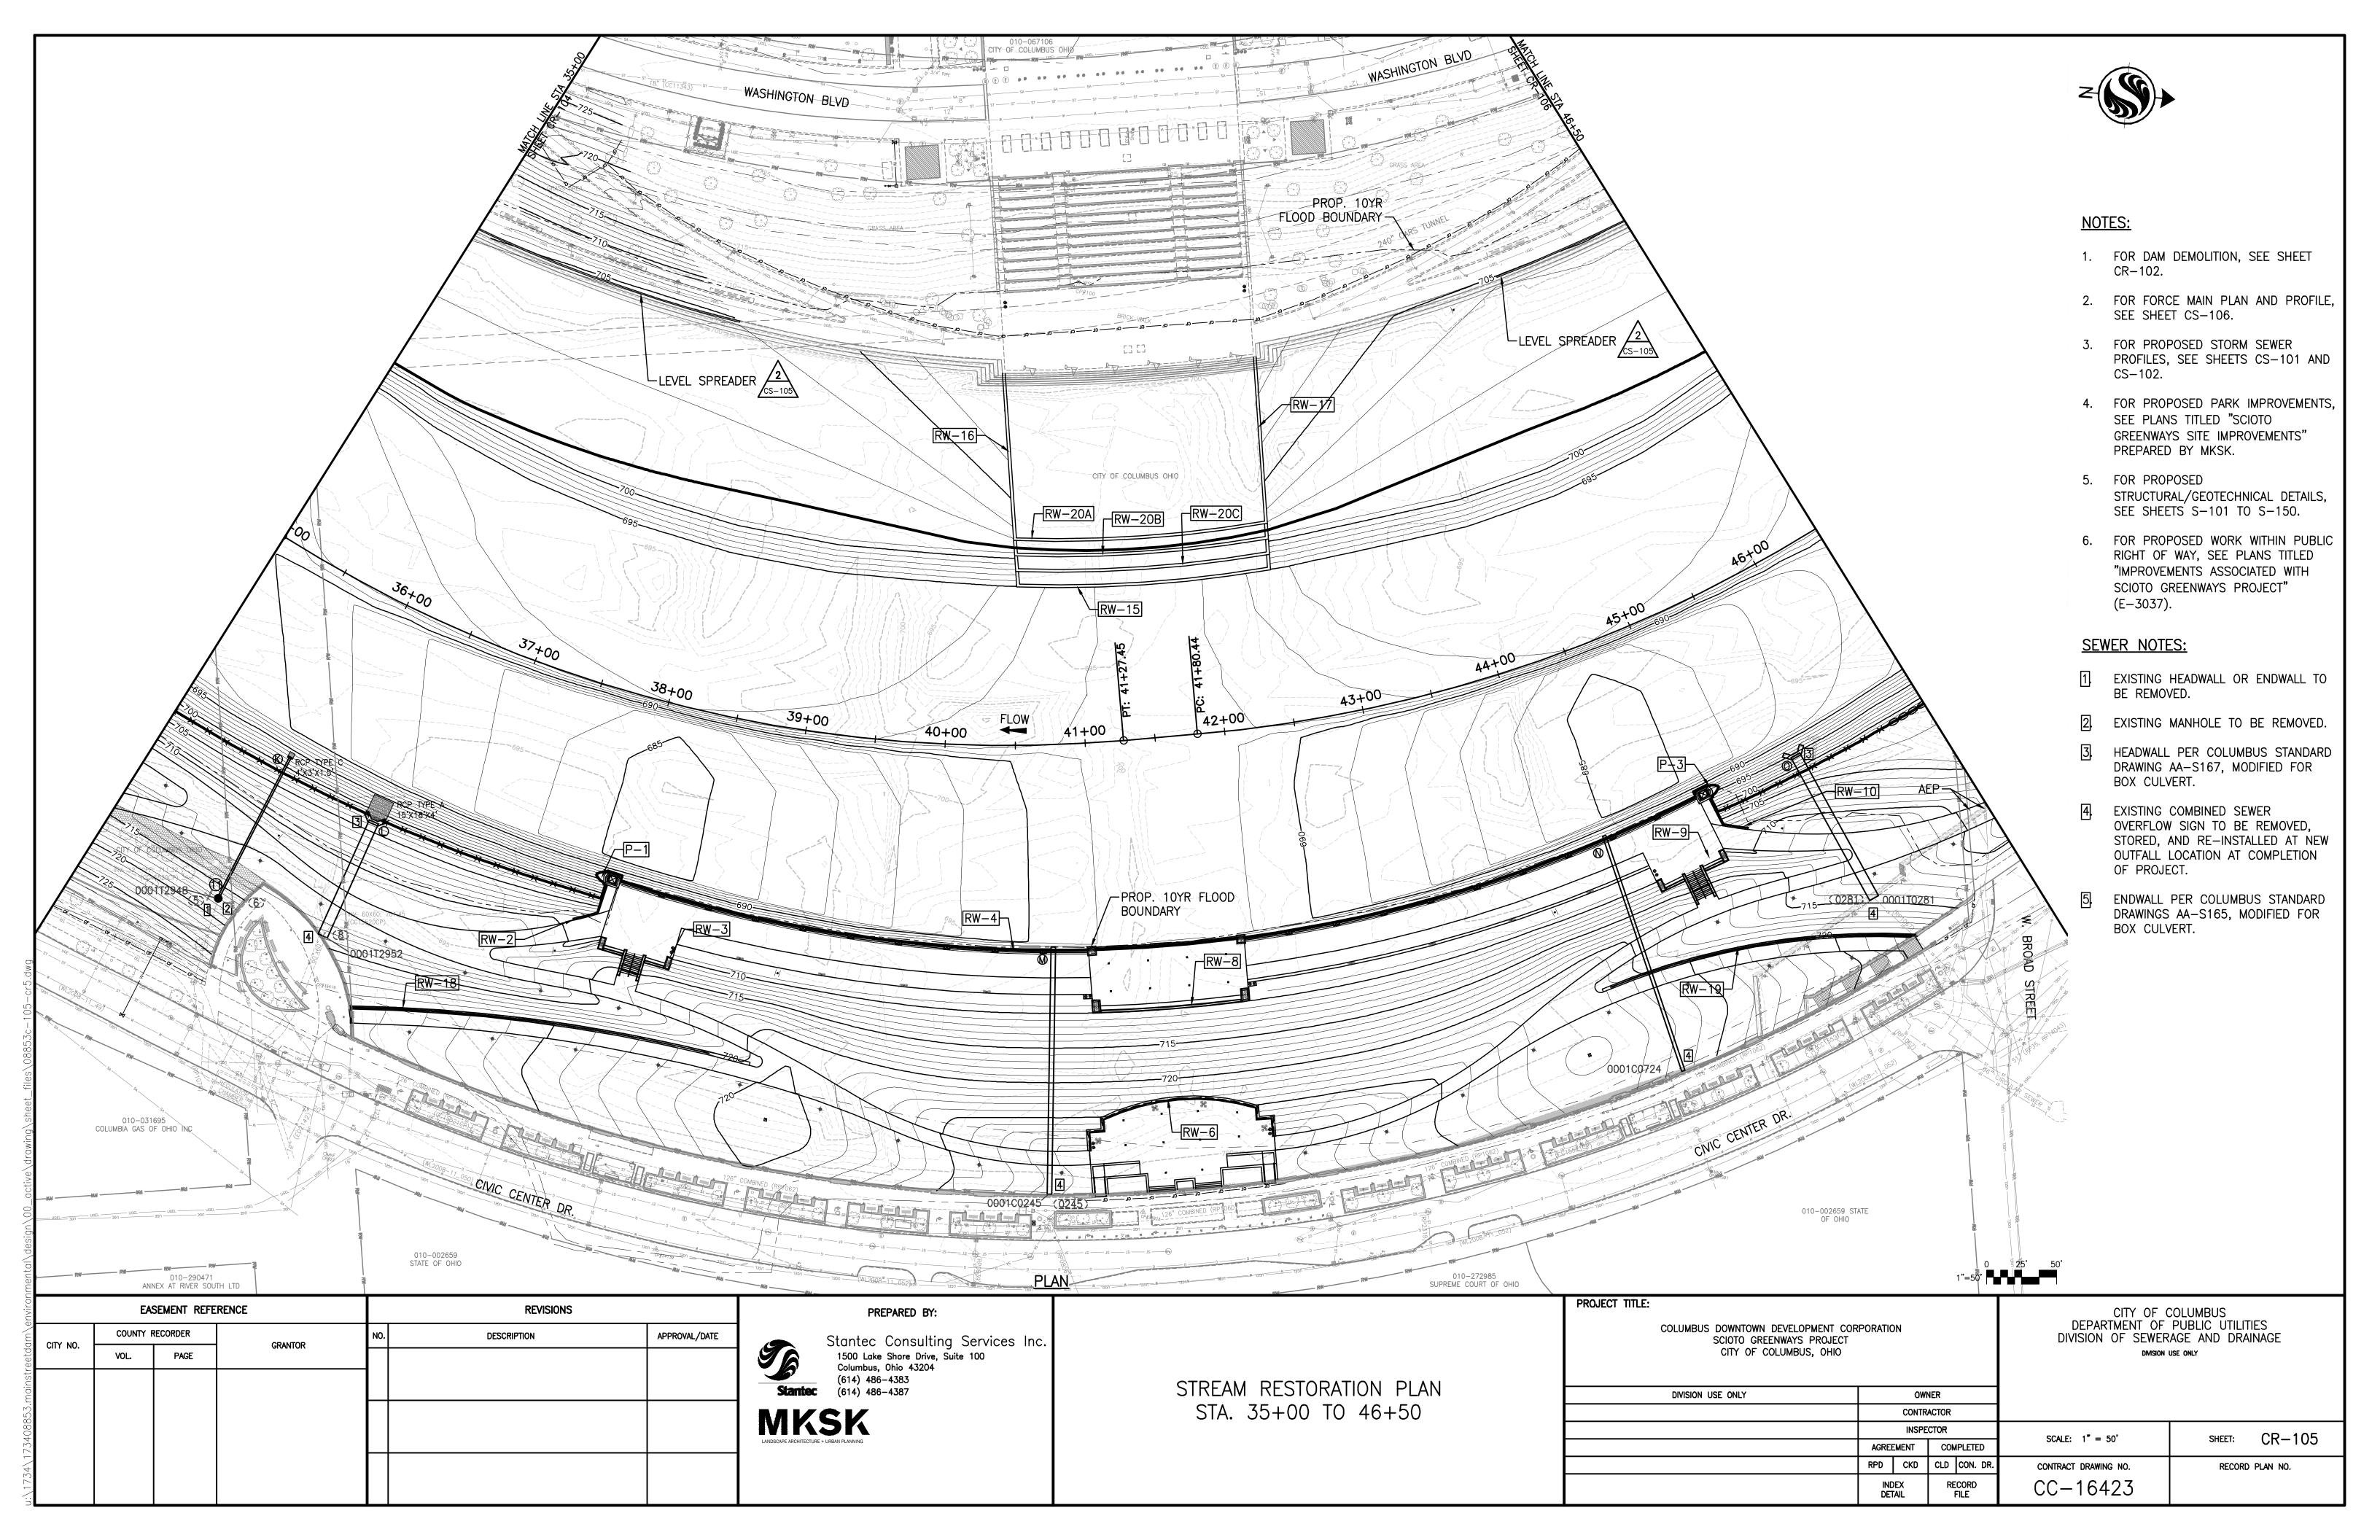

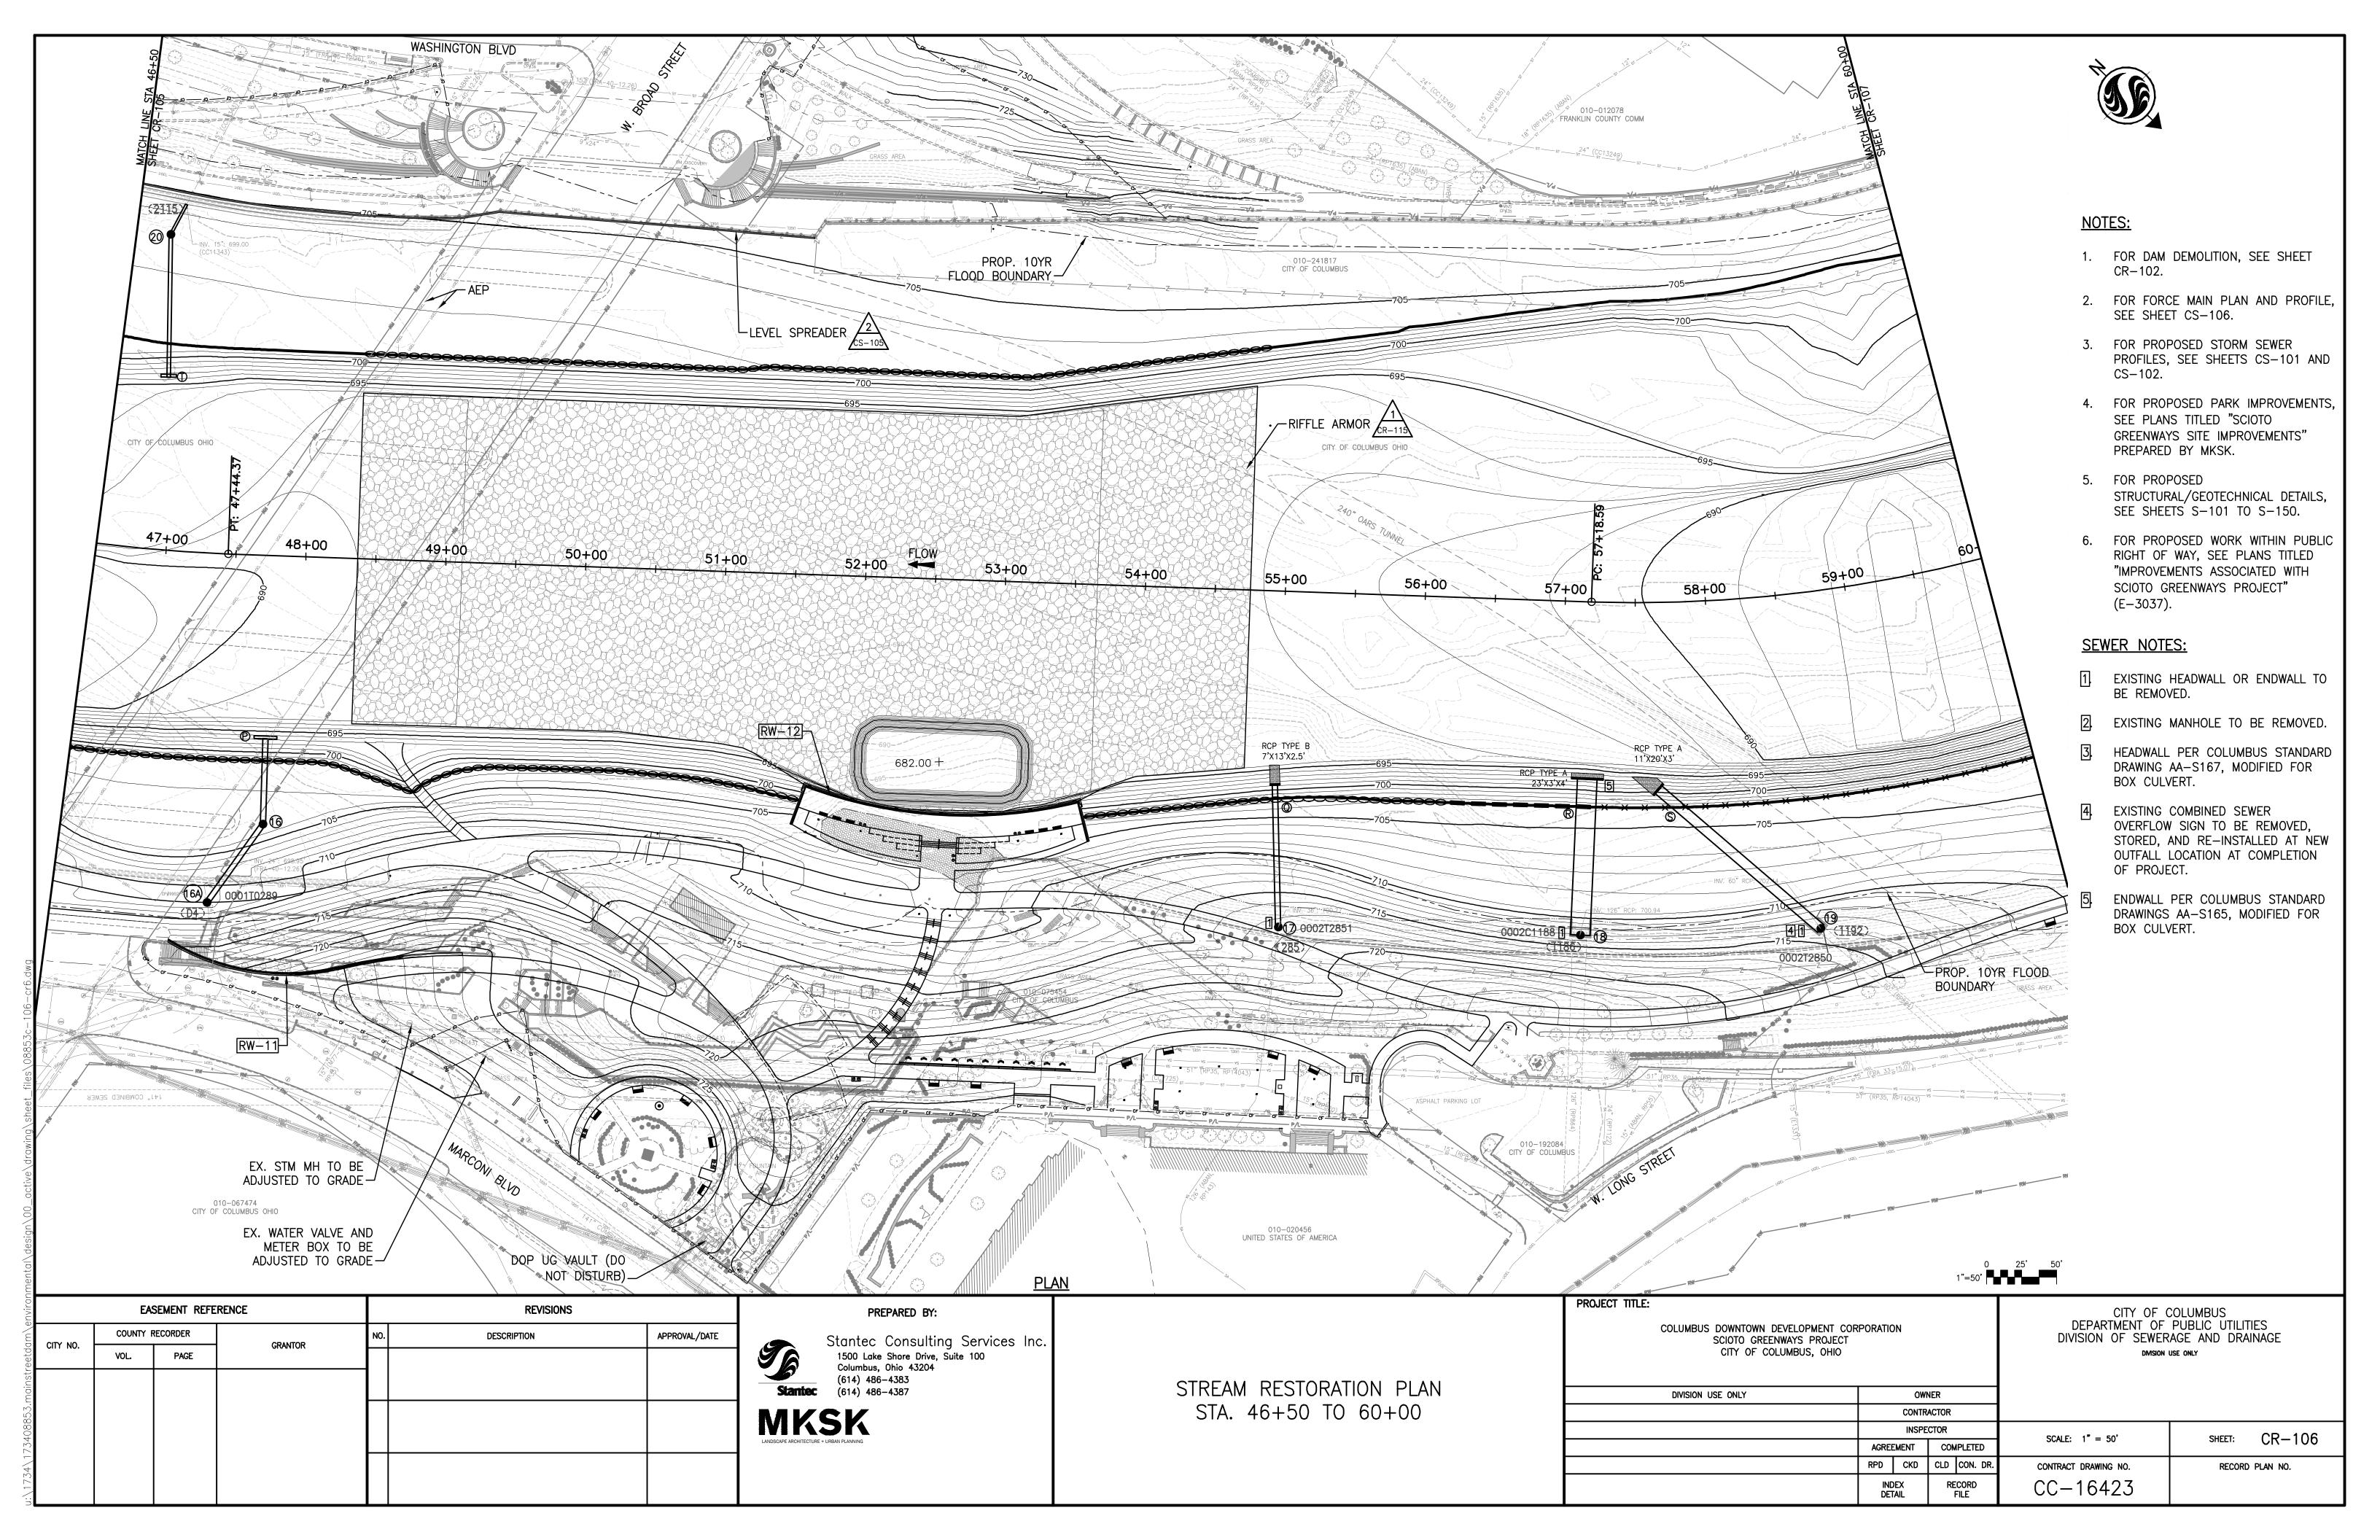

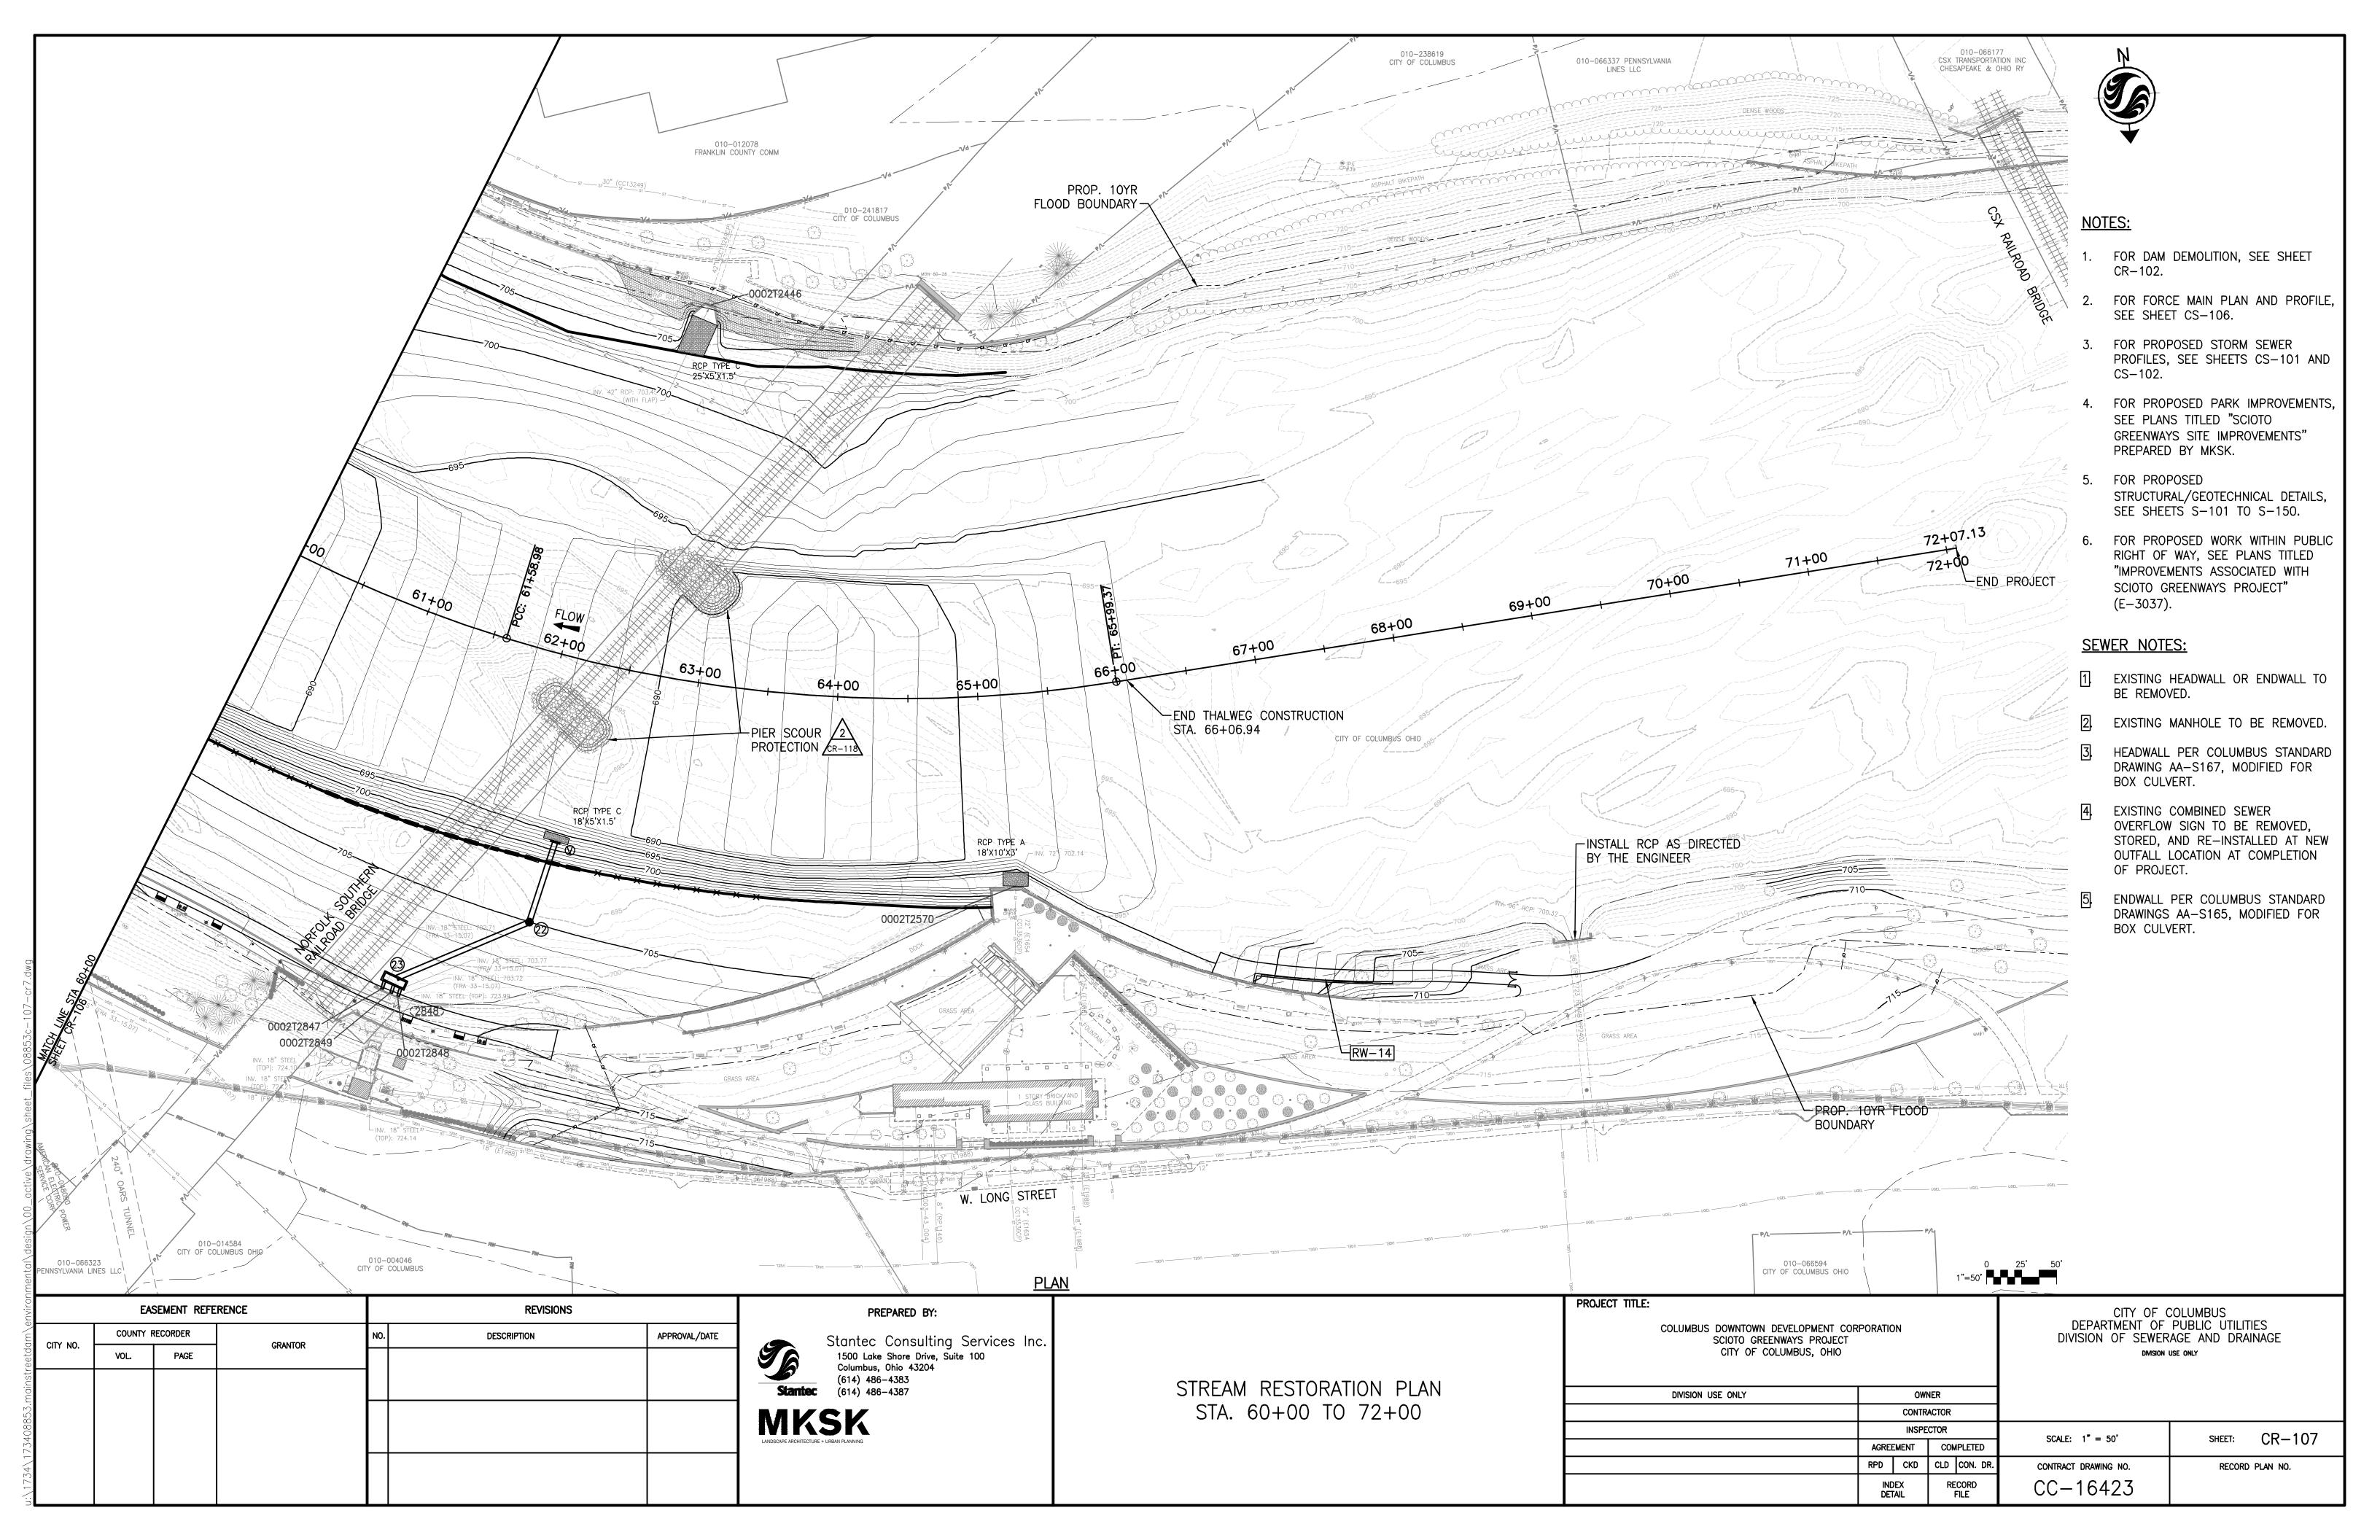

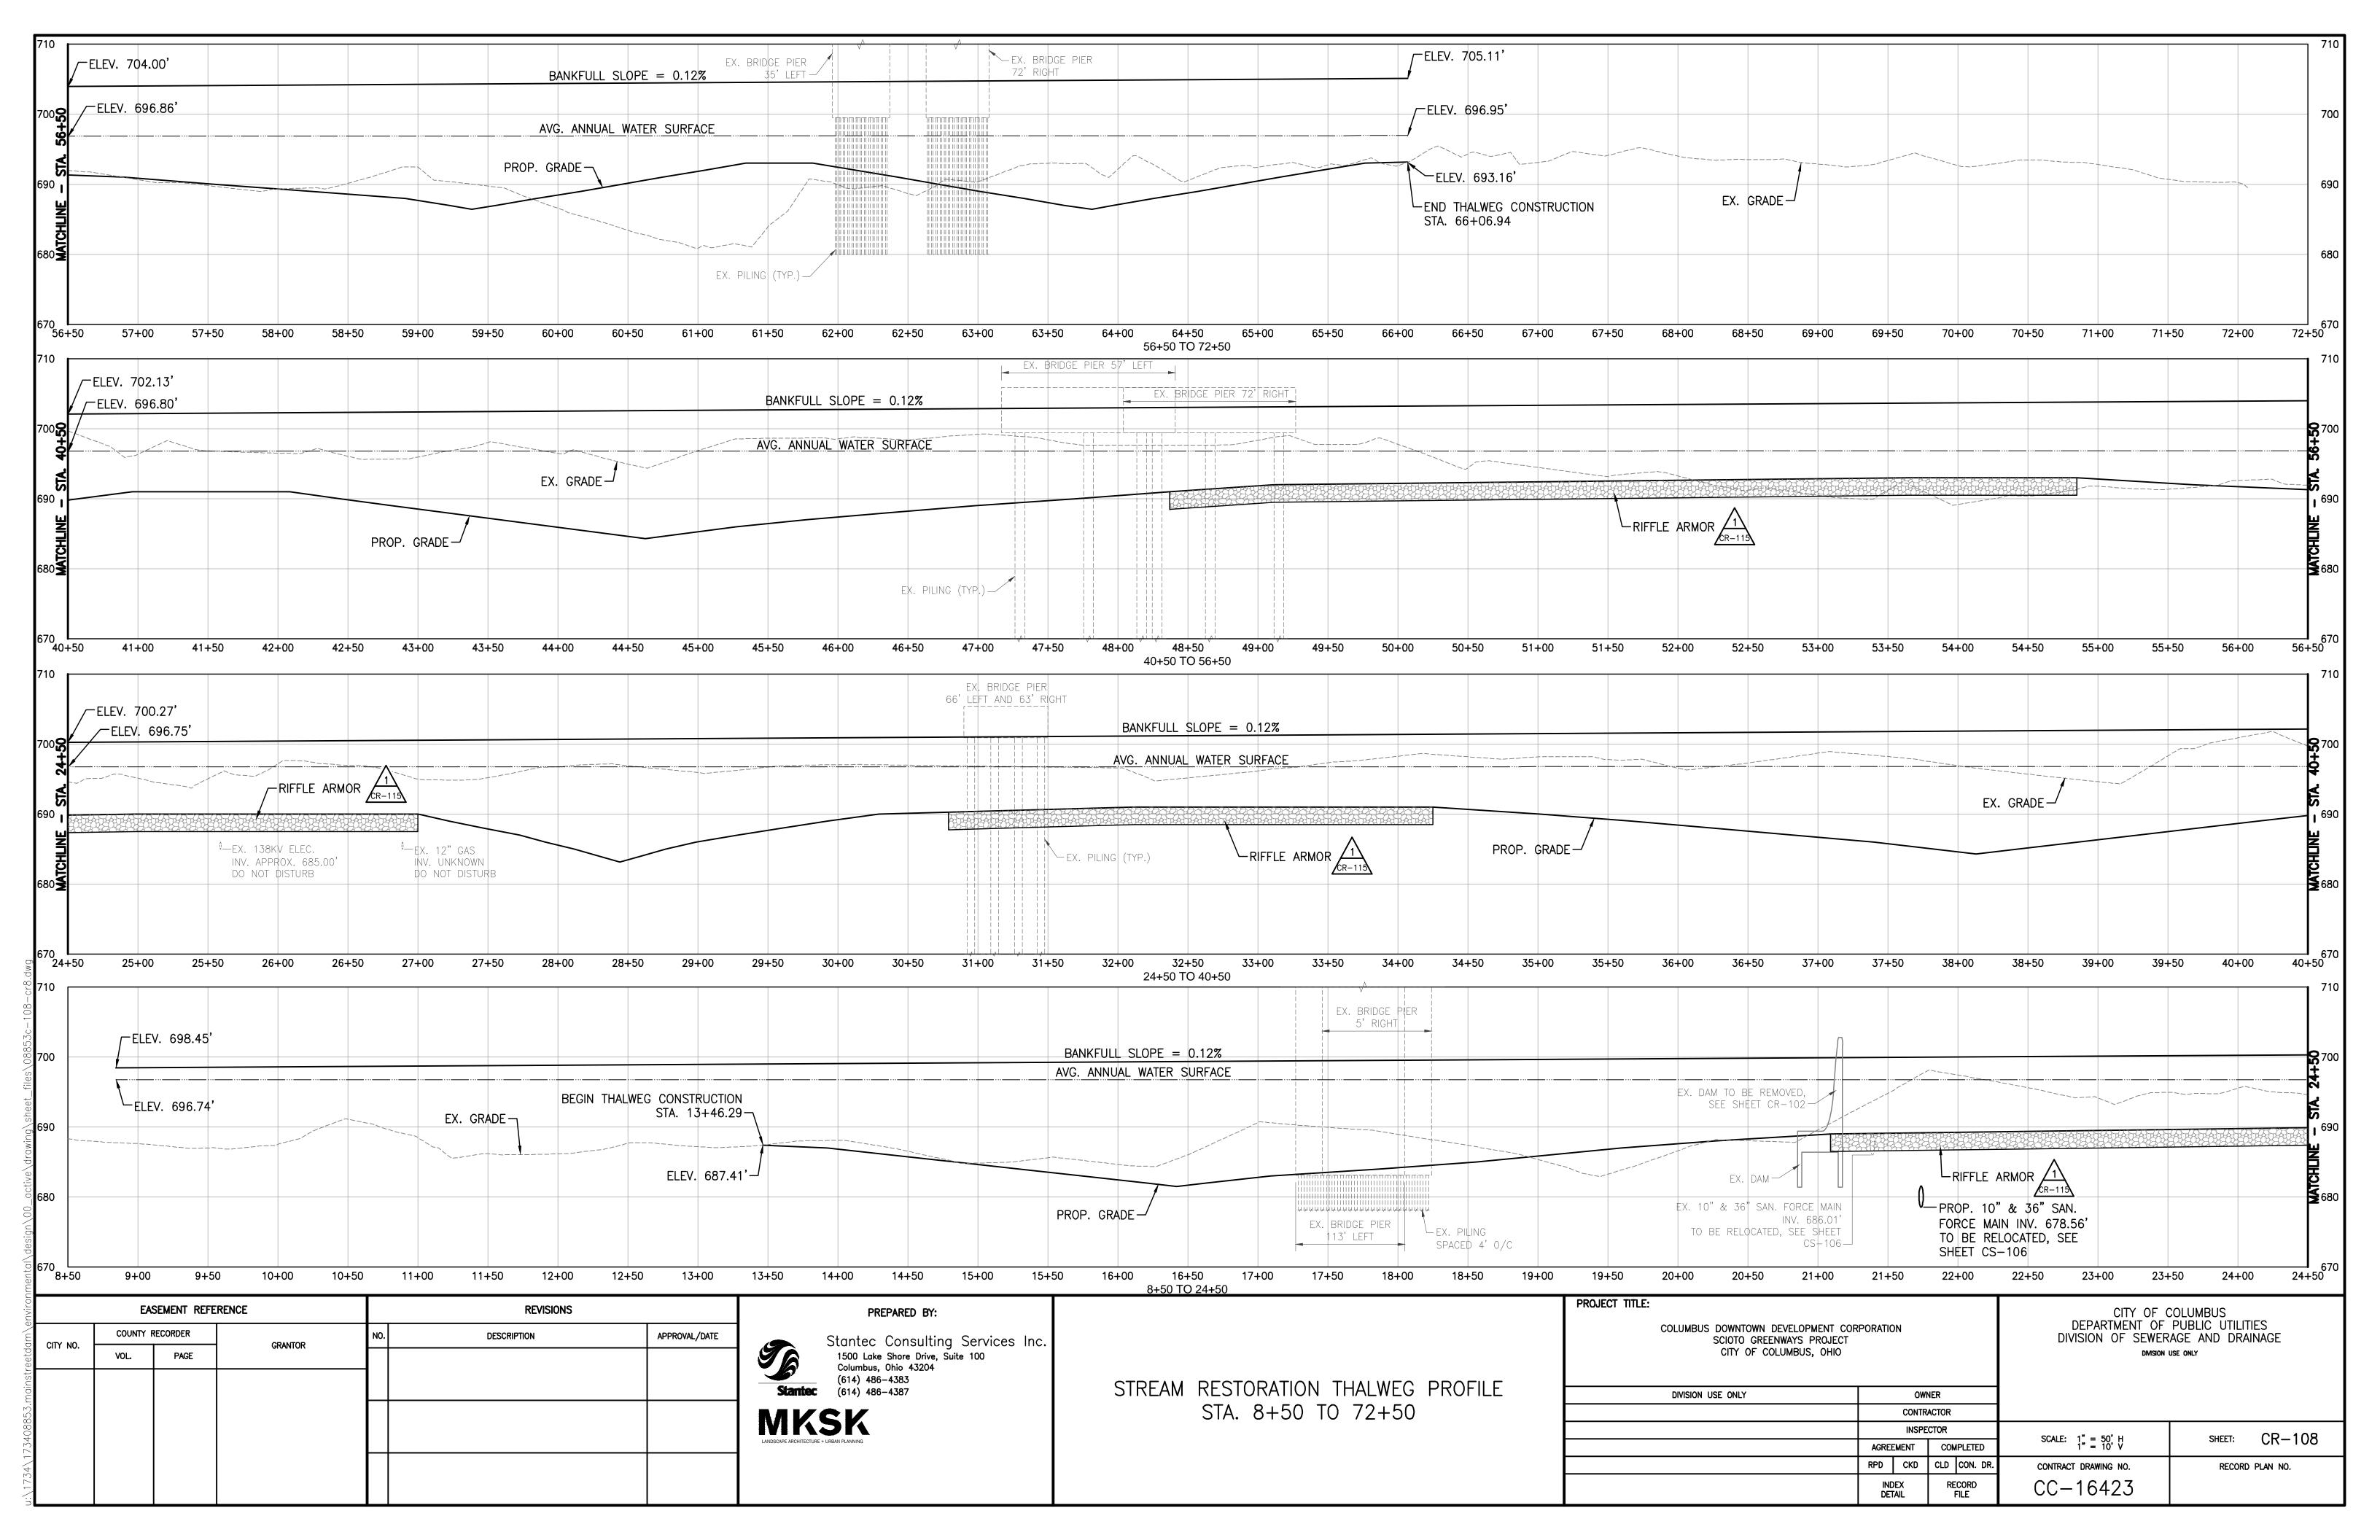

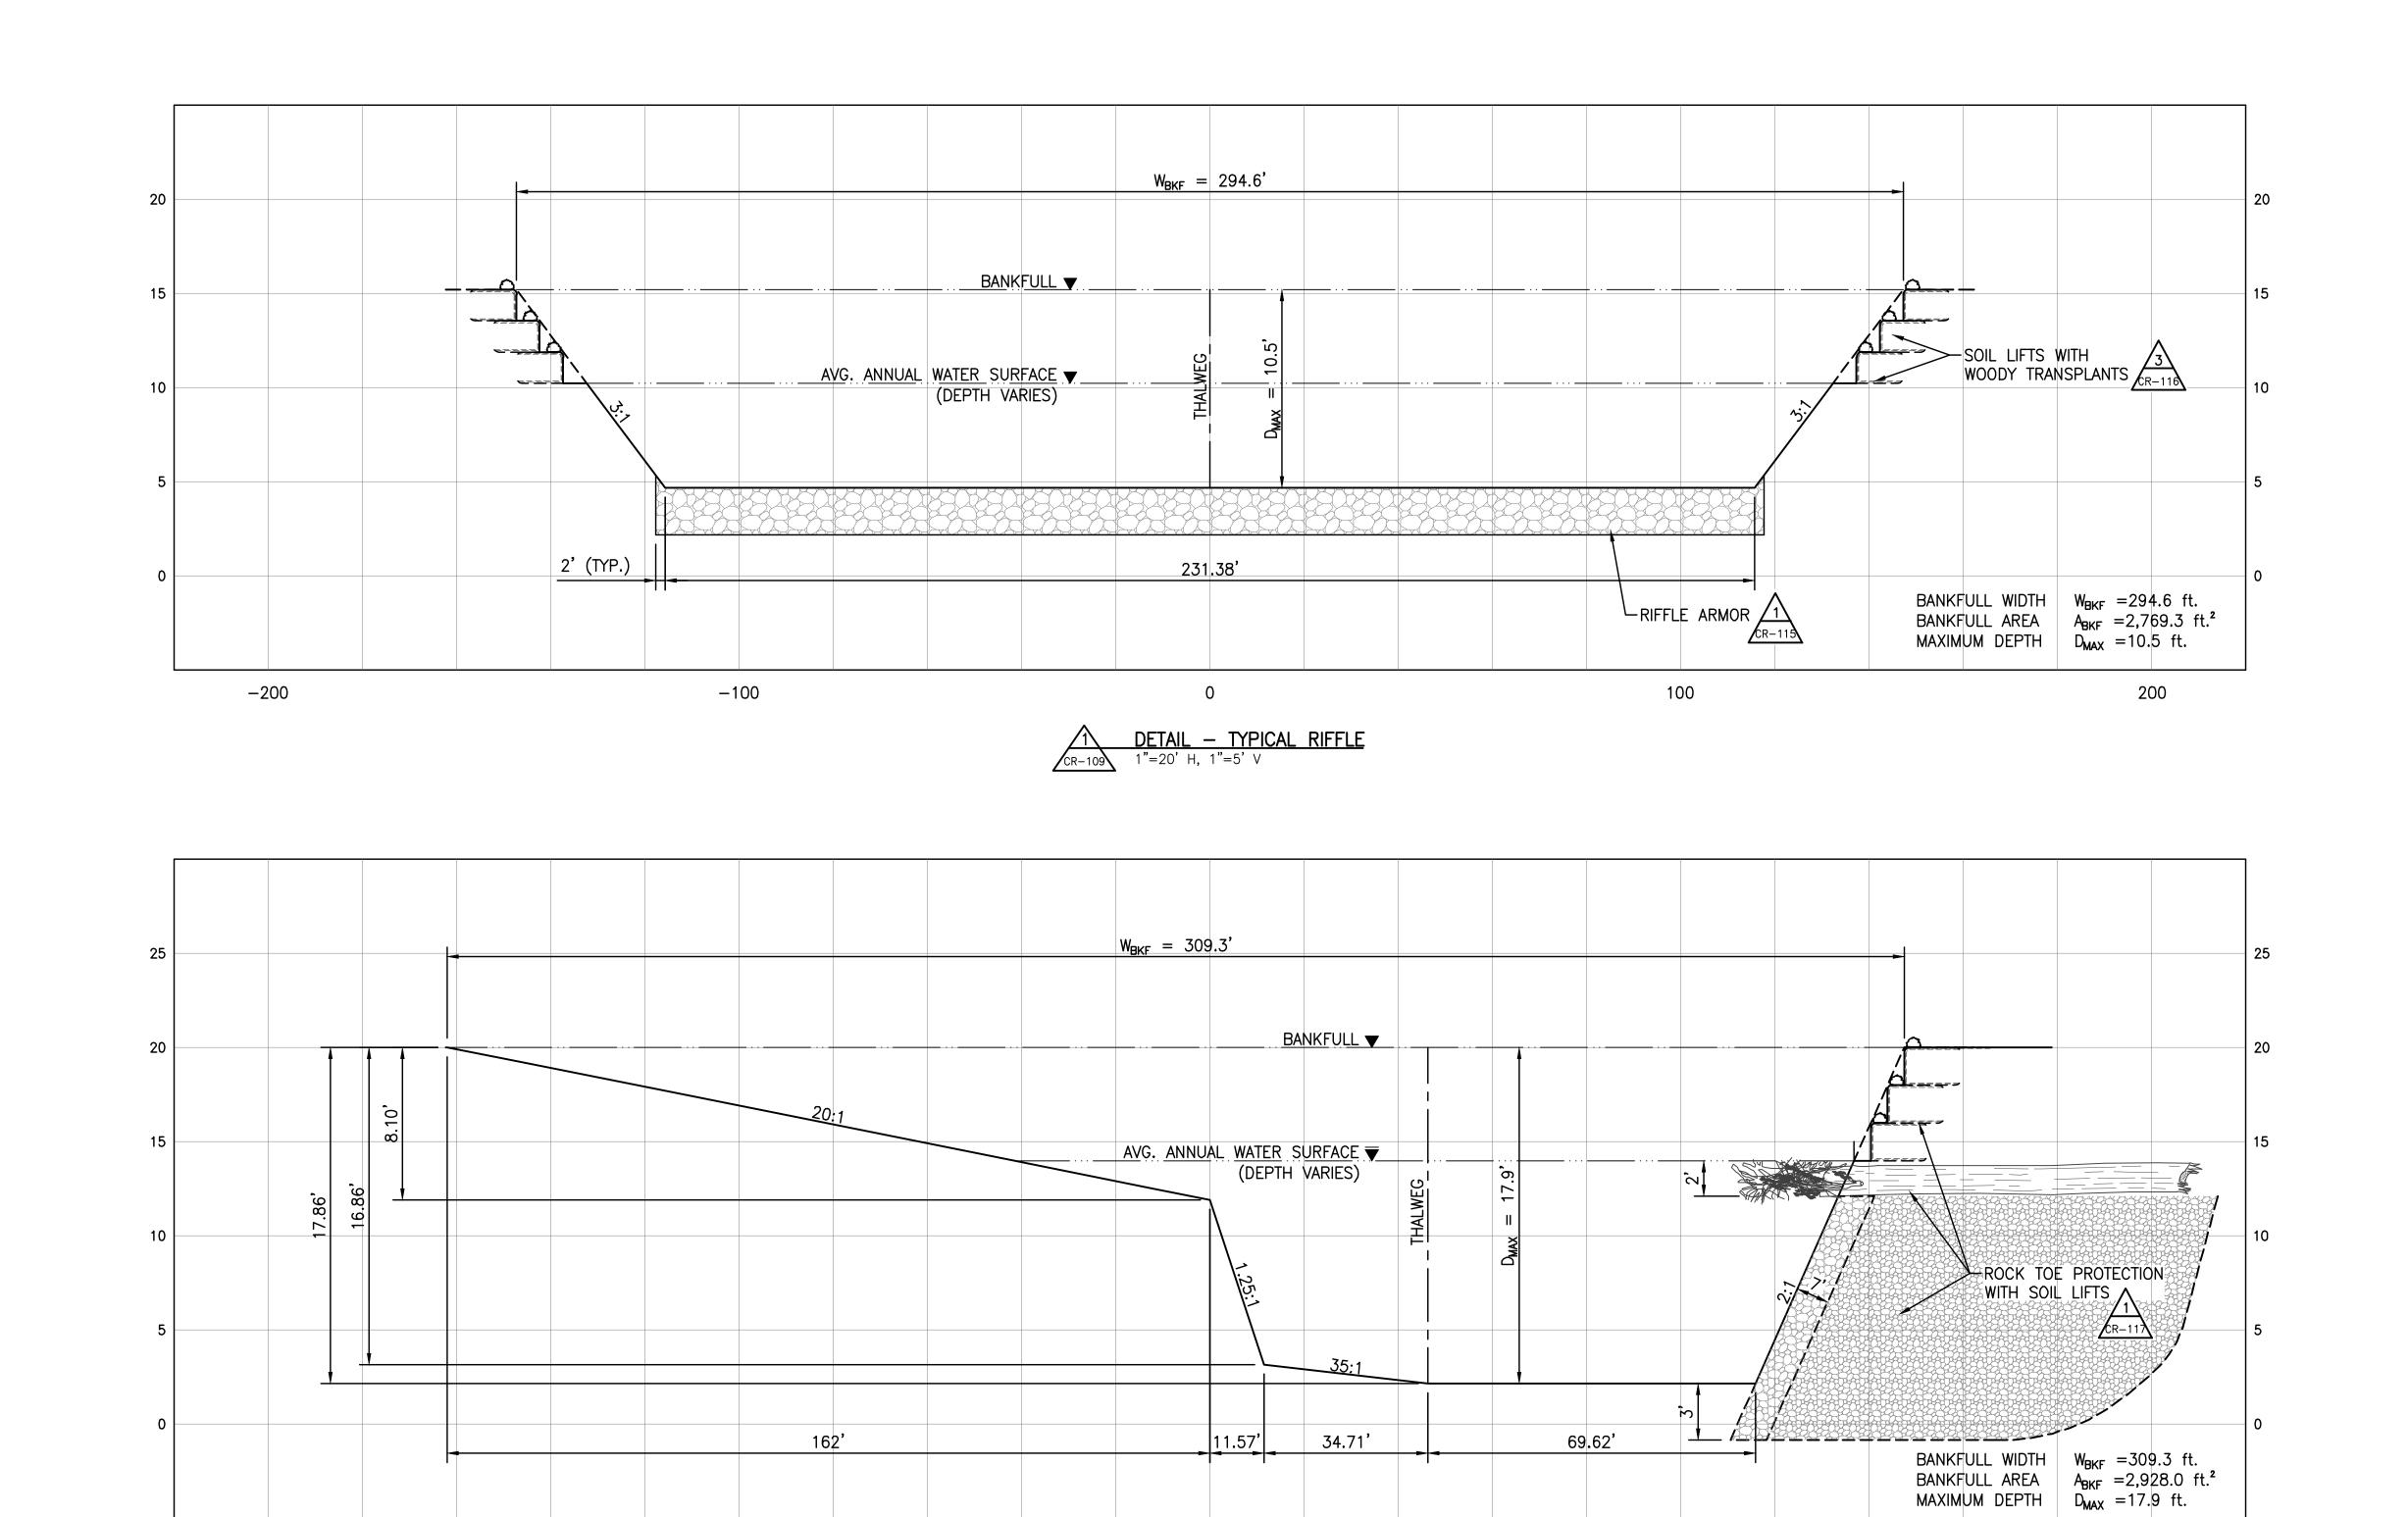

DETAIL - TYPICAL POOL

1"=20' H, 1"=5' V

\equiv										
nviror	EASEMENT REFERENCE					REVISIONS				
ım \e	OITY NO	COUNTY F	RECORDER	CDANITOD	NO.	DESCRIPTION	APPROVAL/DATE			
eerdo	CITY NO.	VOL.	PAGE	GRANTOR						
JILISU										
J										
.000.										
1/34										
/ 74/										
_							1	1		

-200

	PREPARED BY:	
Stantec Stantec LANDSCAPE ARCHITECTURE 4	-	Inc.


-100


STREAM RESTORATION TYPICAL SECTIONS


100


PROJECT TITLE: COLUMBUS DOWNTOWN DEVELOPMENT CO SCIOTO GREENWAYS PROJECT CITY OF COLUMBUS, OHIO		CITY OF ODEPARTMENT OF DIVISION OF SEWER	PUBLIC UTILITIES AGE AND DRAINAGE				
DIVISION USE ONLY		OWI	NER				
		CONTR	ACTOR				
		INSPE	CTOR		SCALE: NONE	SHEET: CR-109	
	AGRE	EMENT	CON	MPLETED	JUALE. NONE	SHEET: CR-109	
	RPD	CKD	CLD	CON. DR.	CONTRACT DRAWING NO.	RECORD PLAN NO.	
	INI DE	DEX TAIL		ECORD FILE	CC-16423		


200

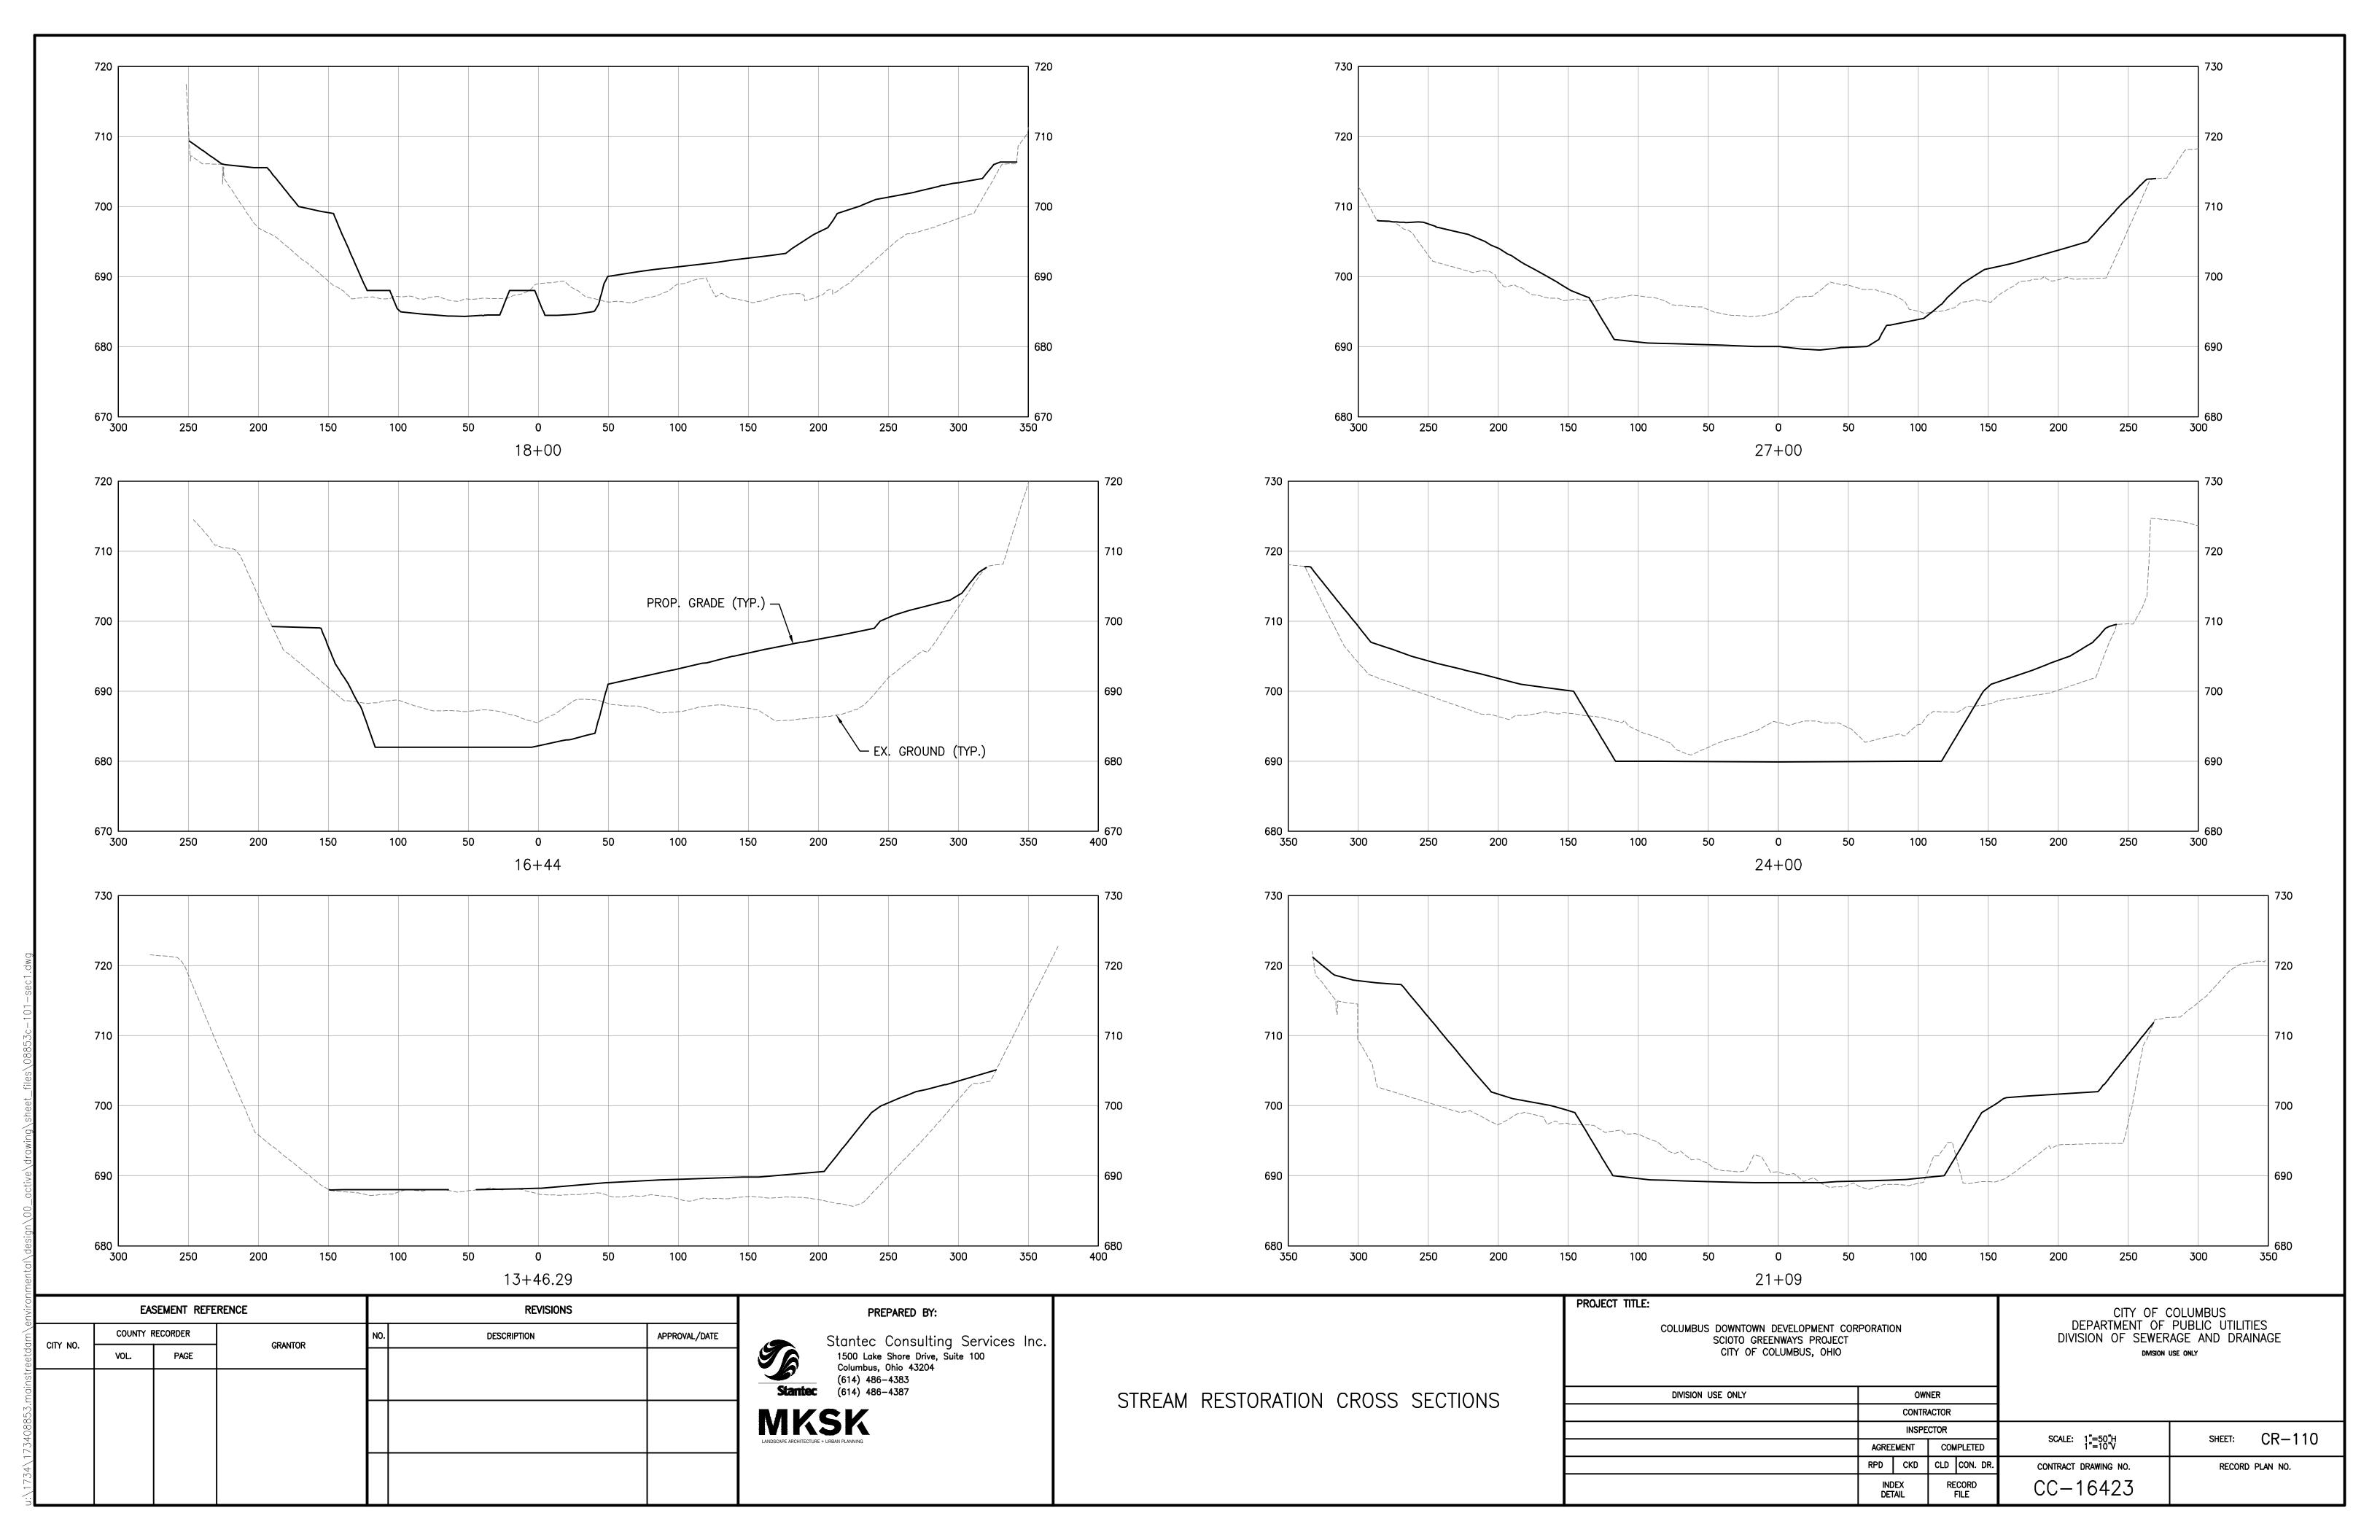


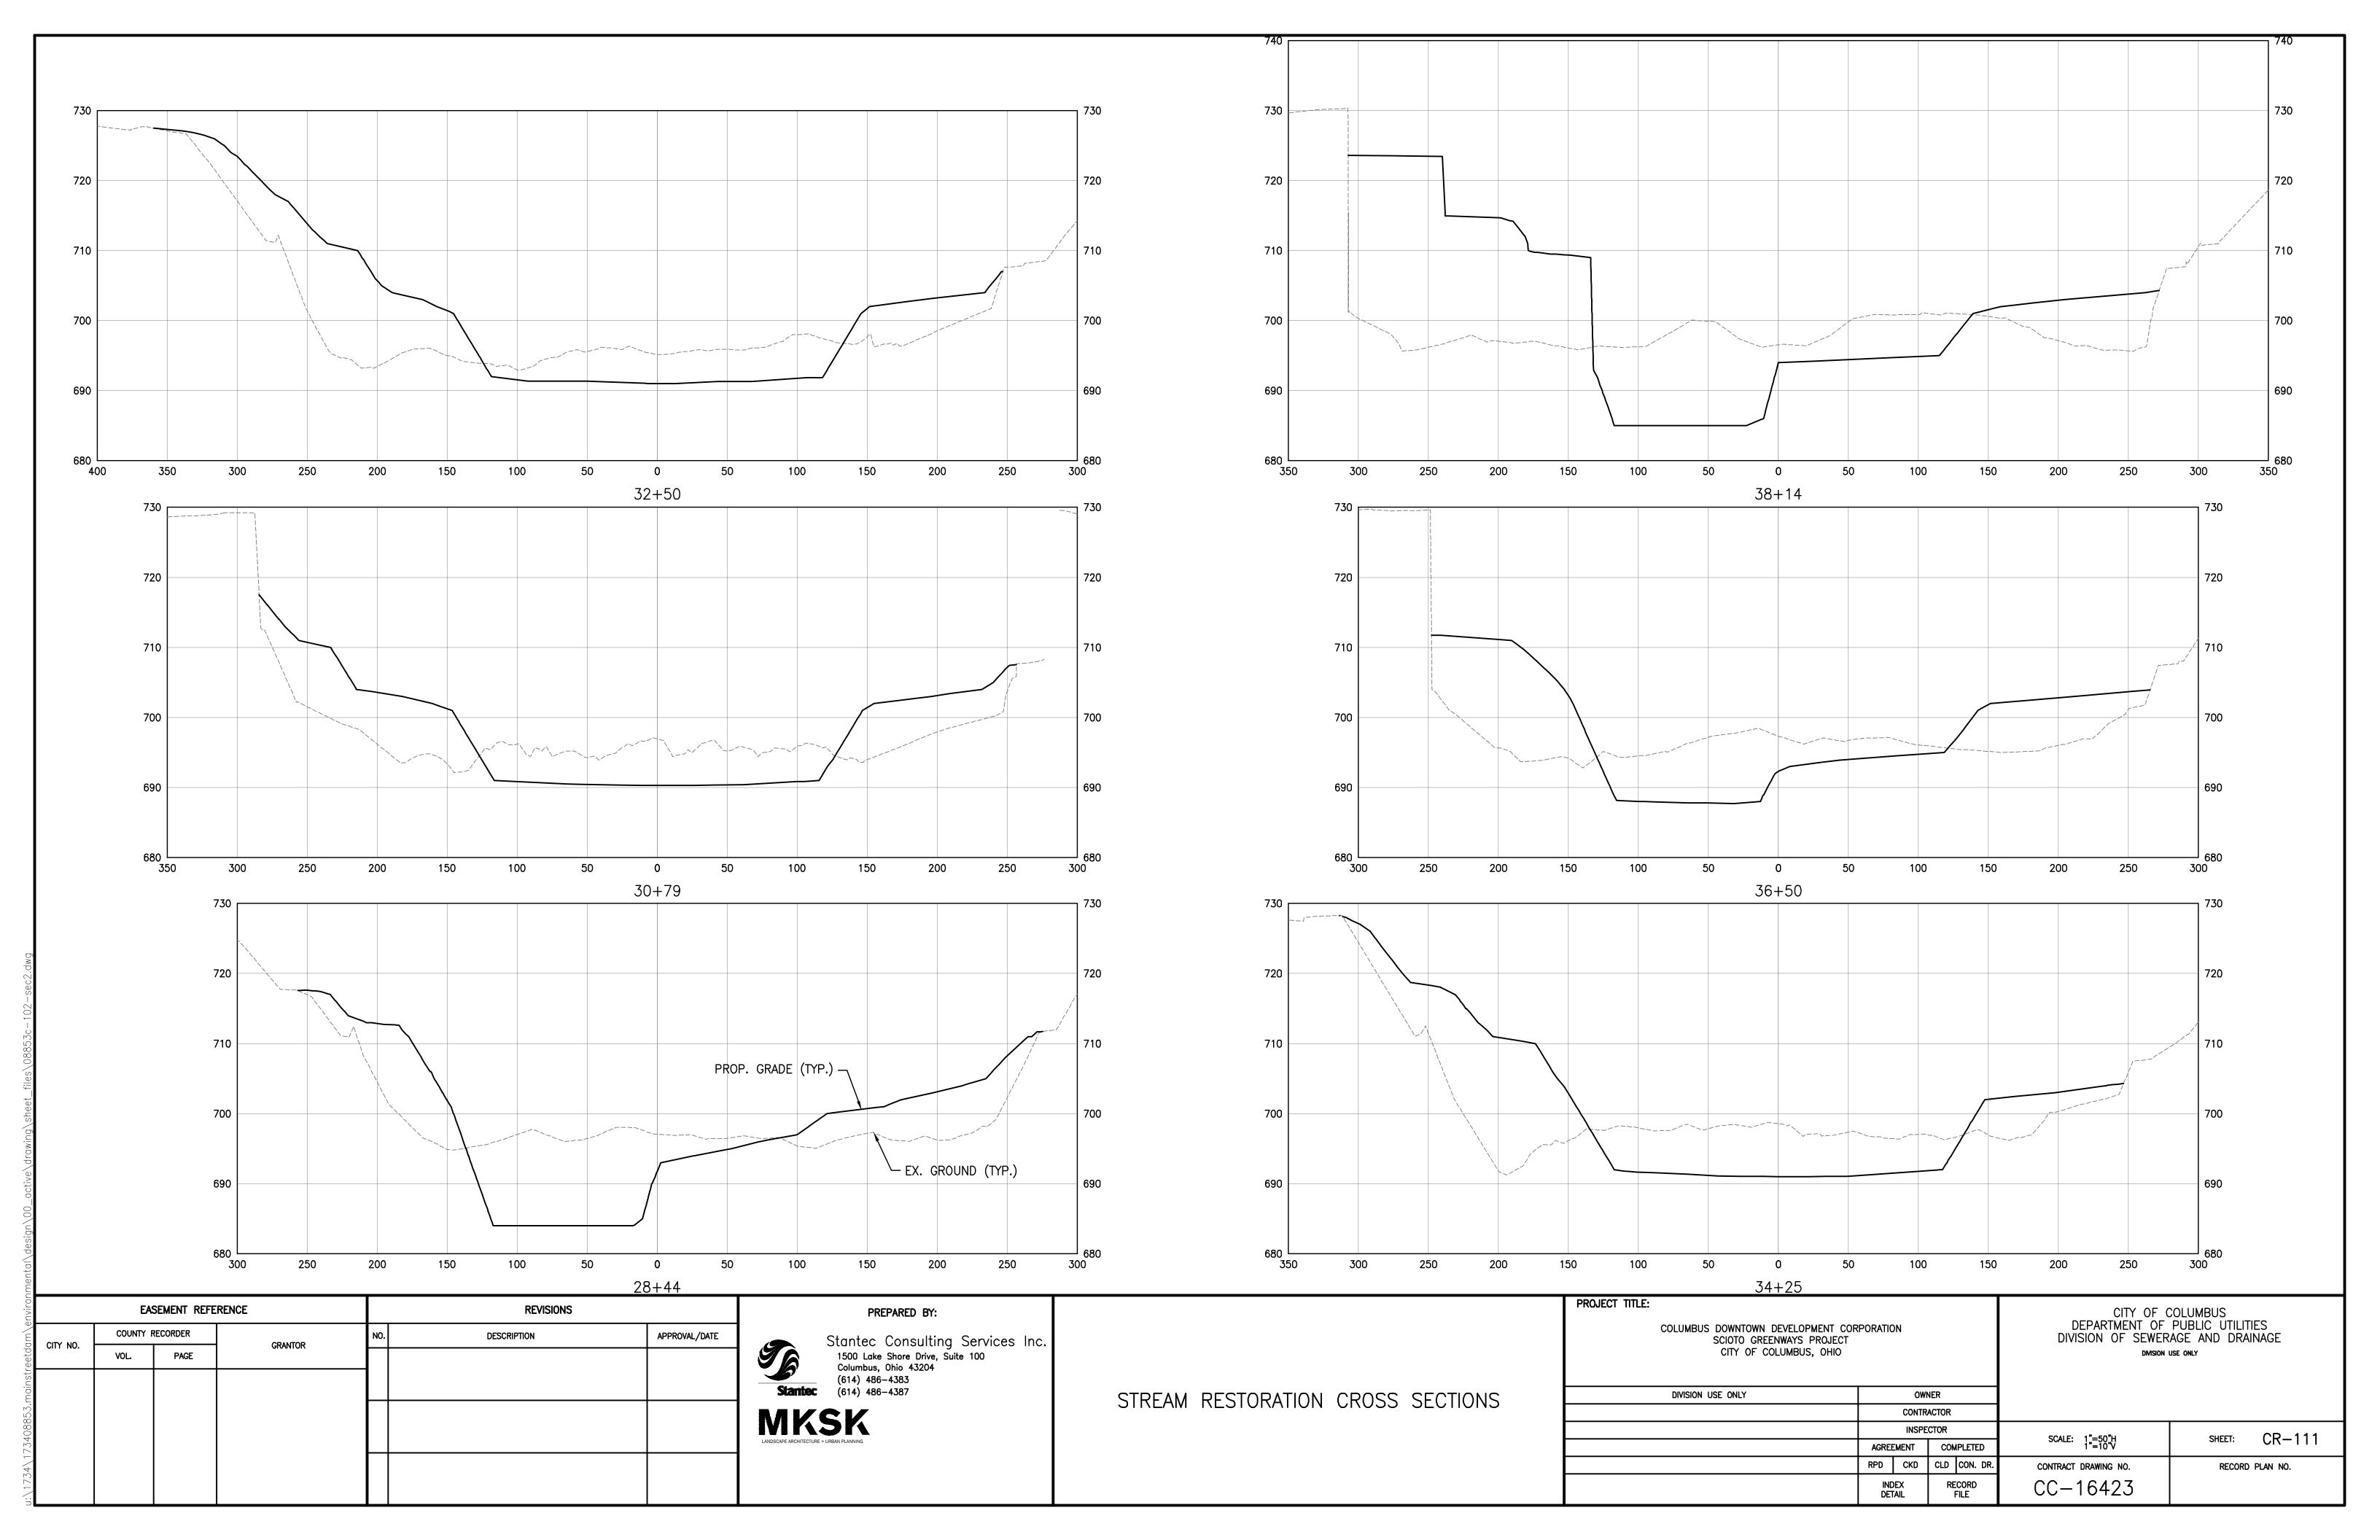

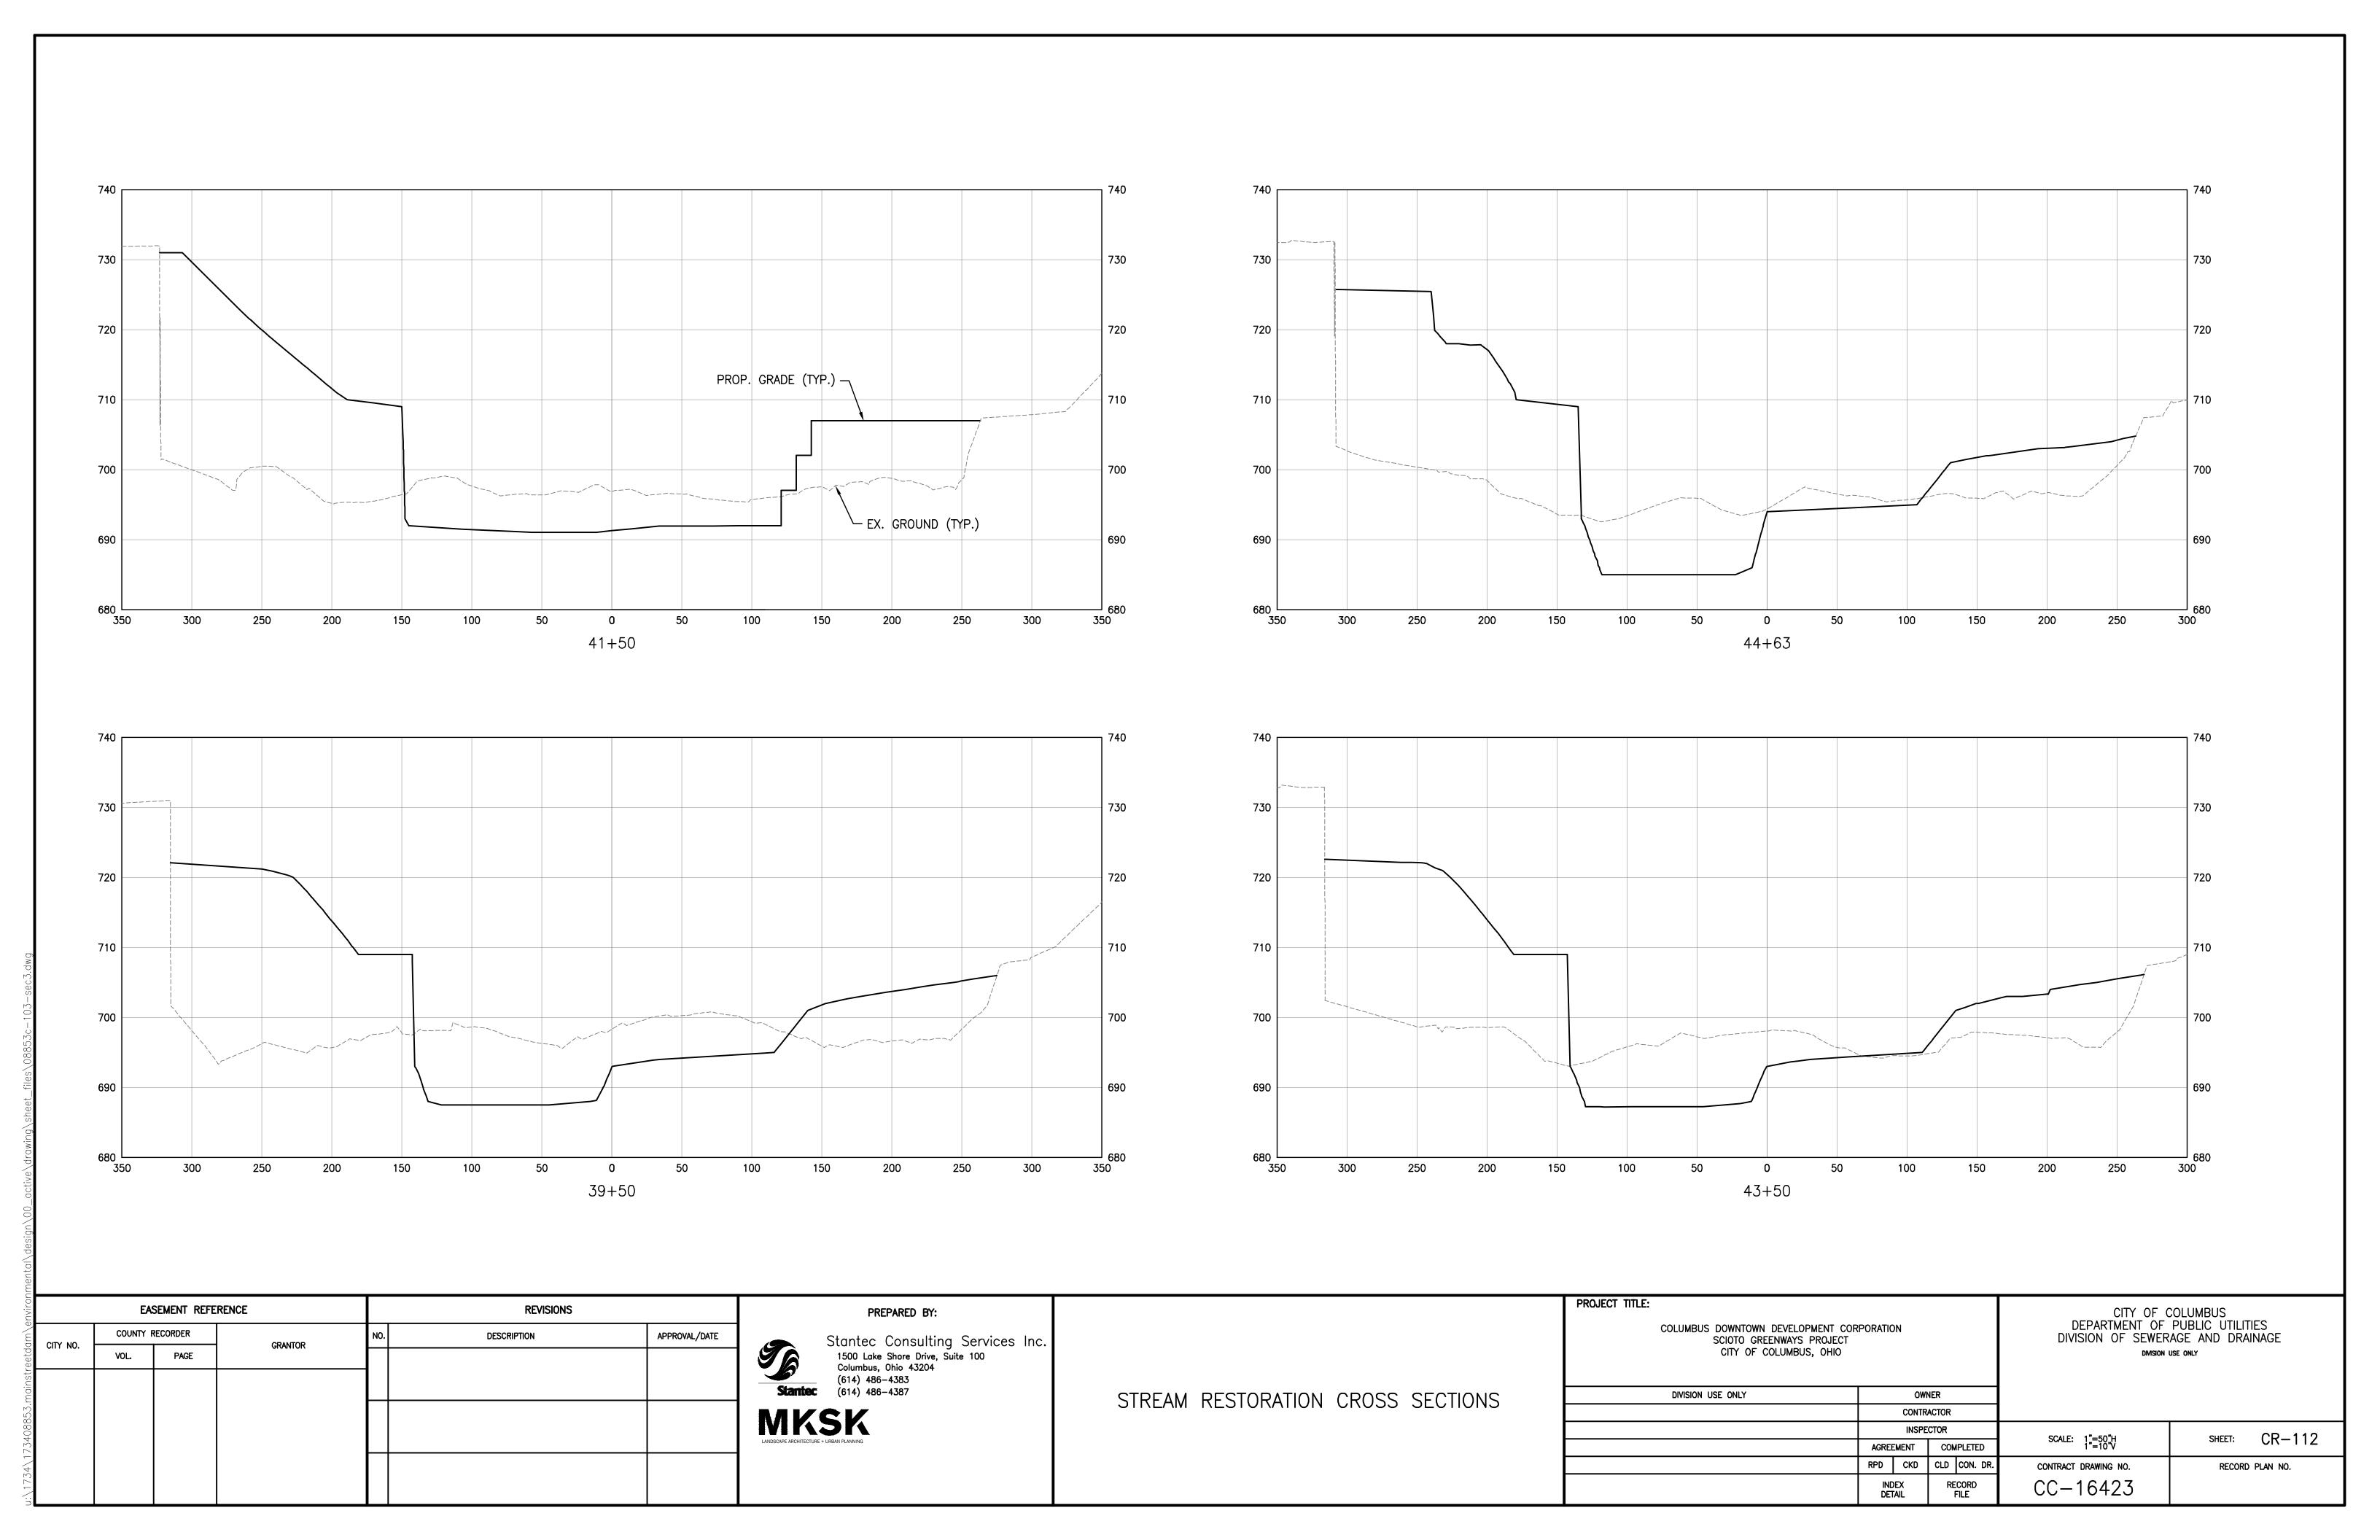

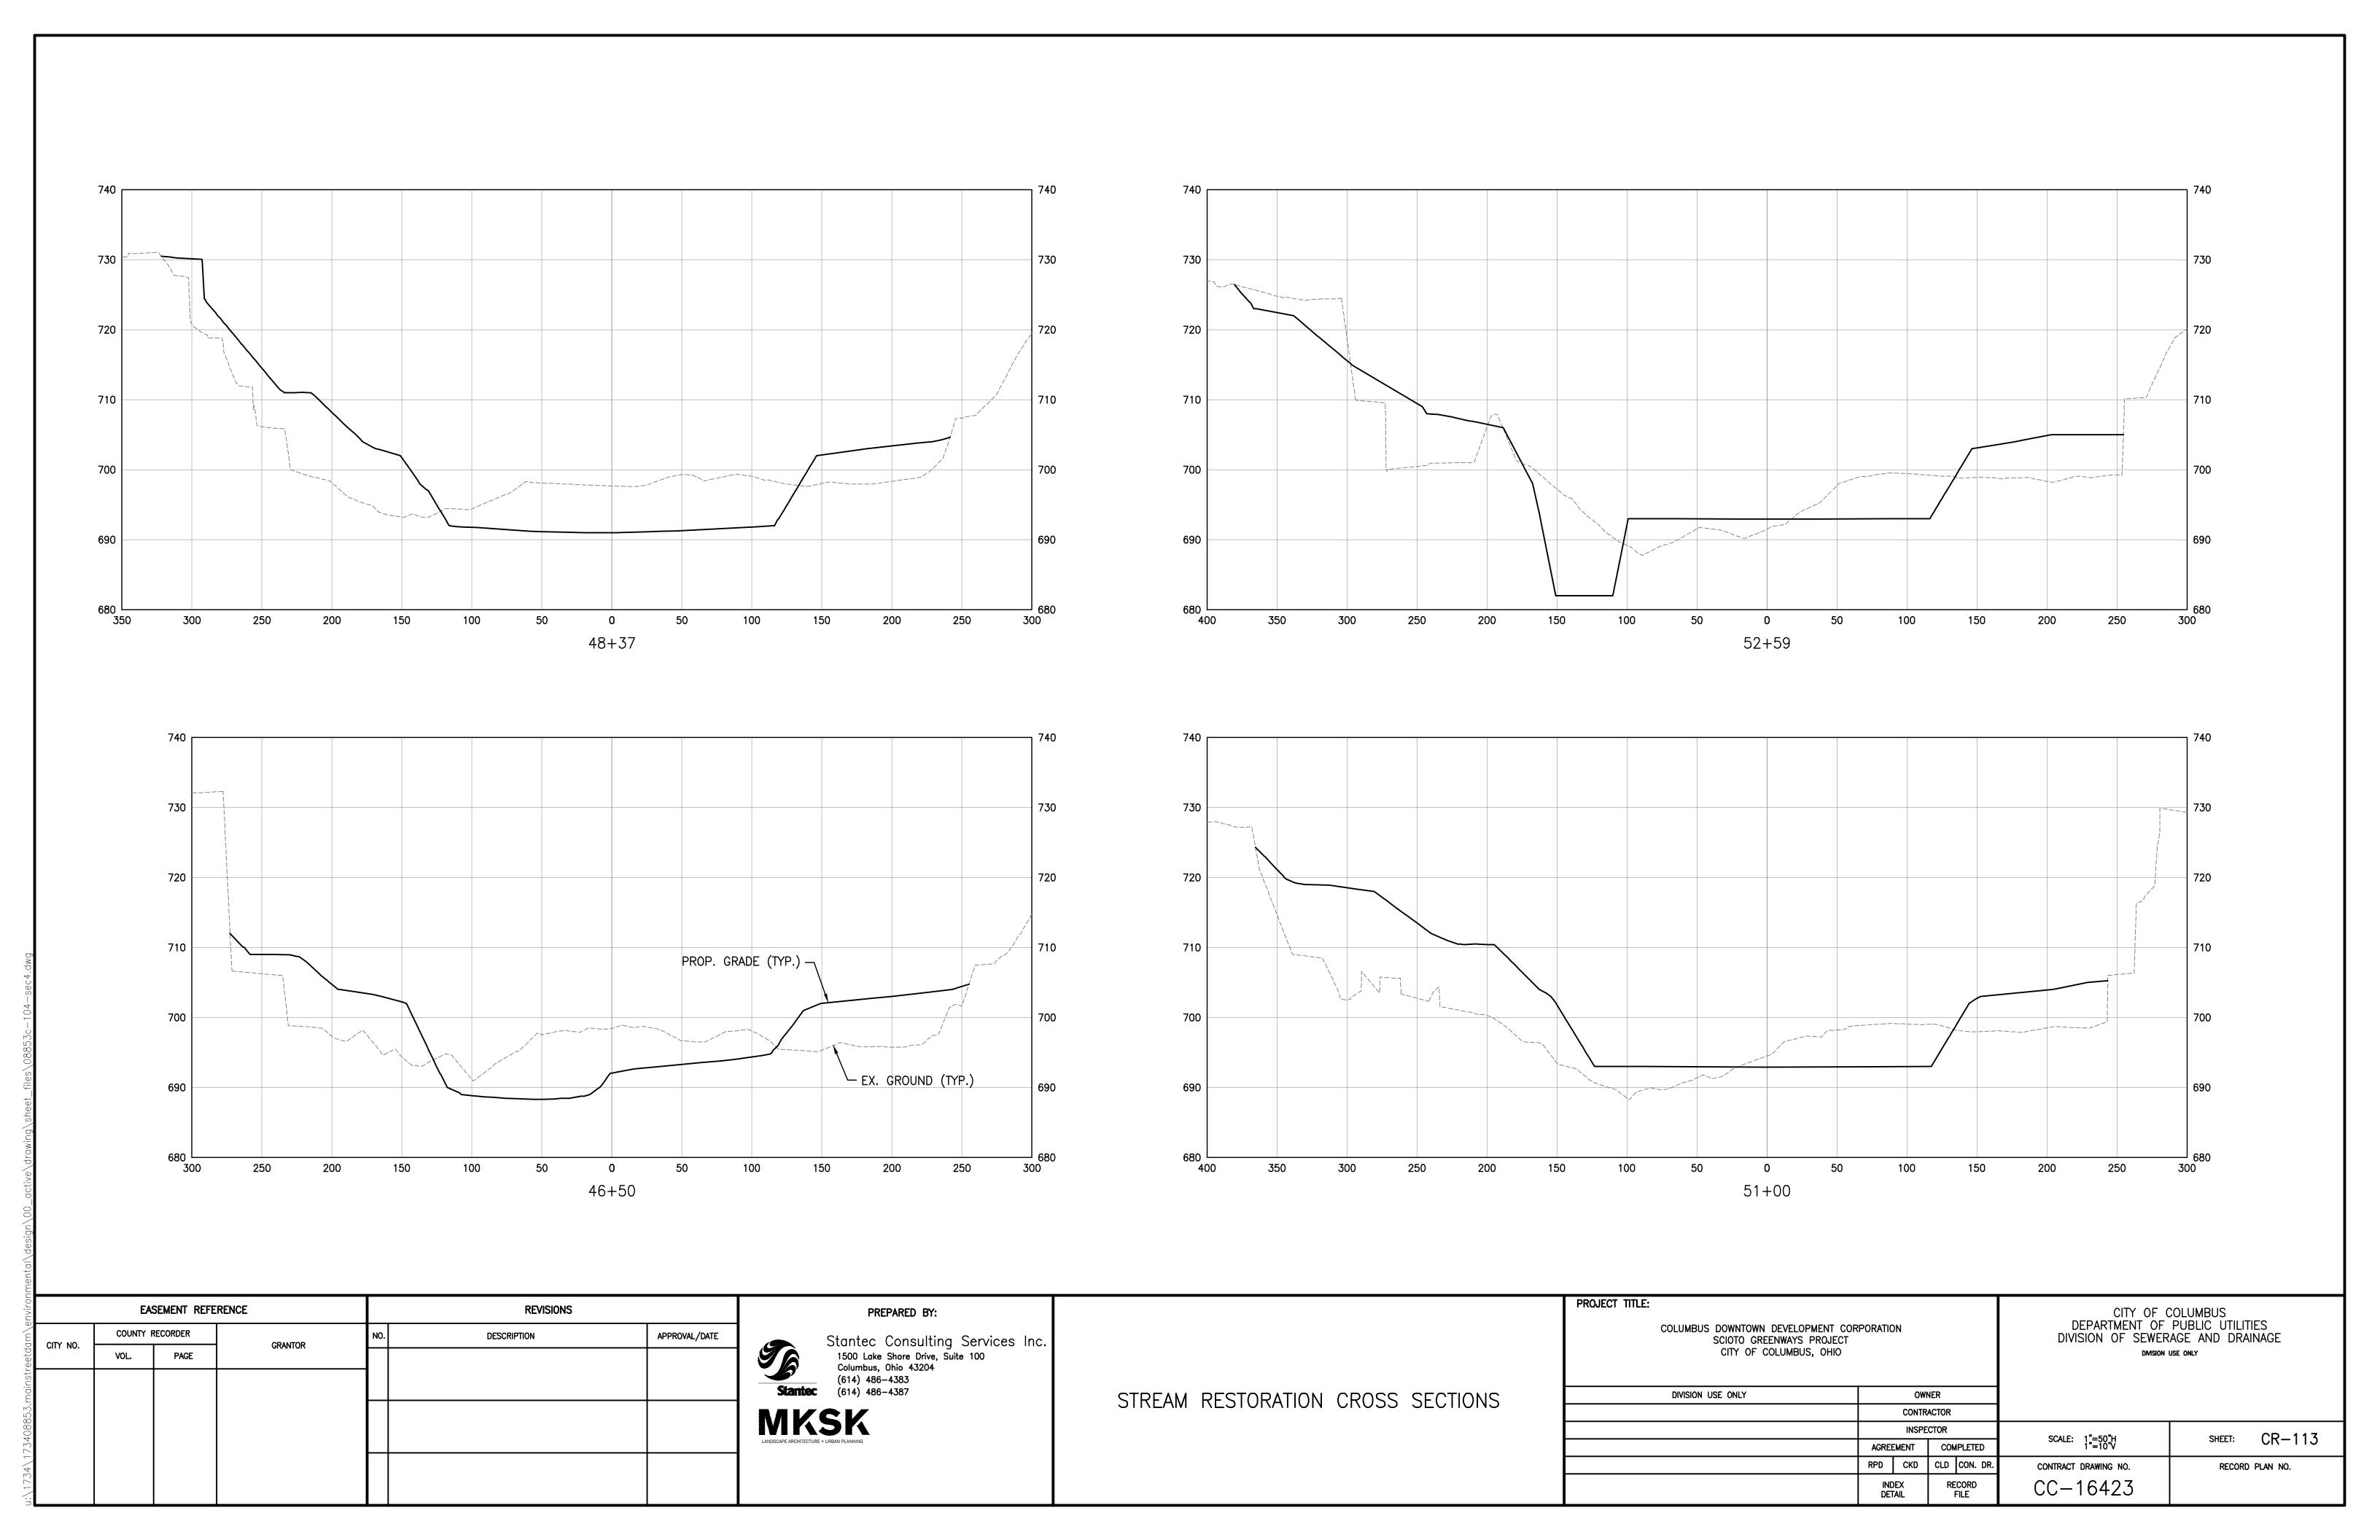


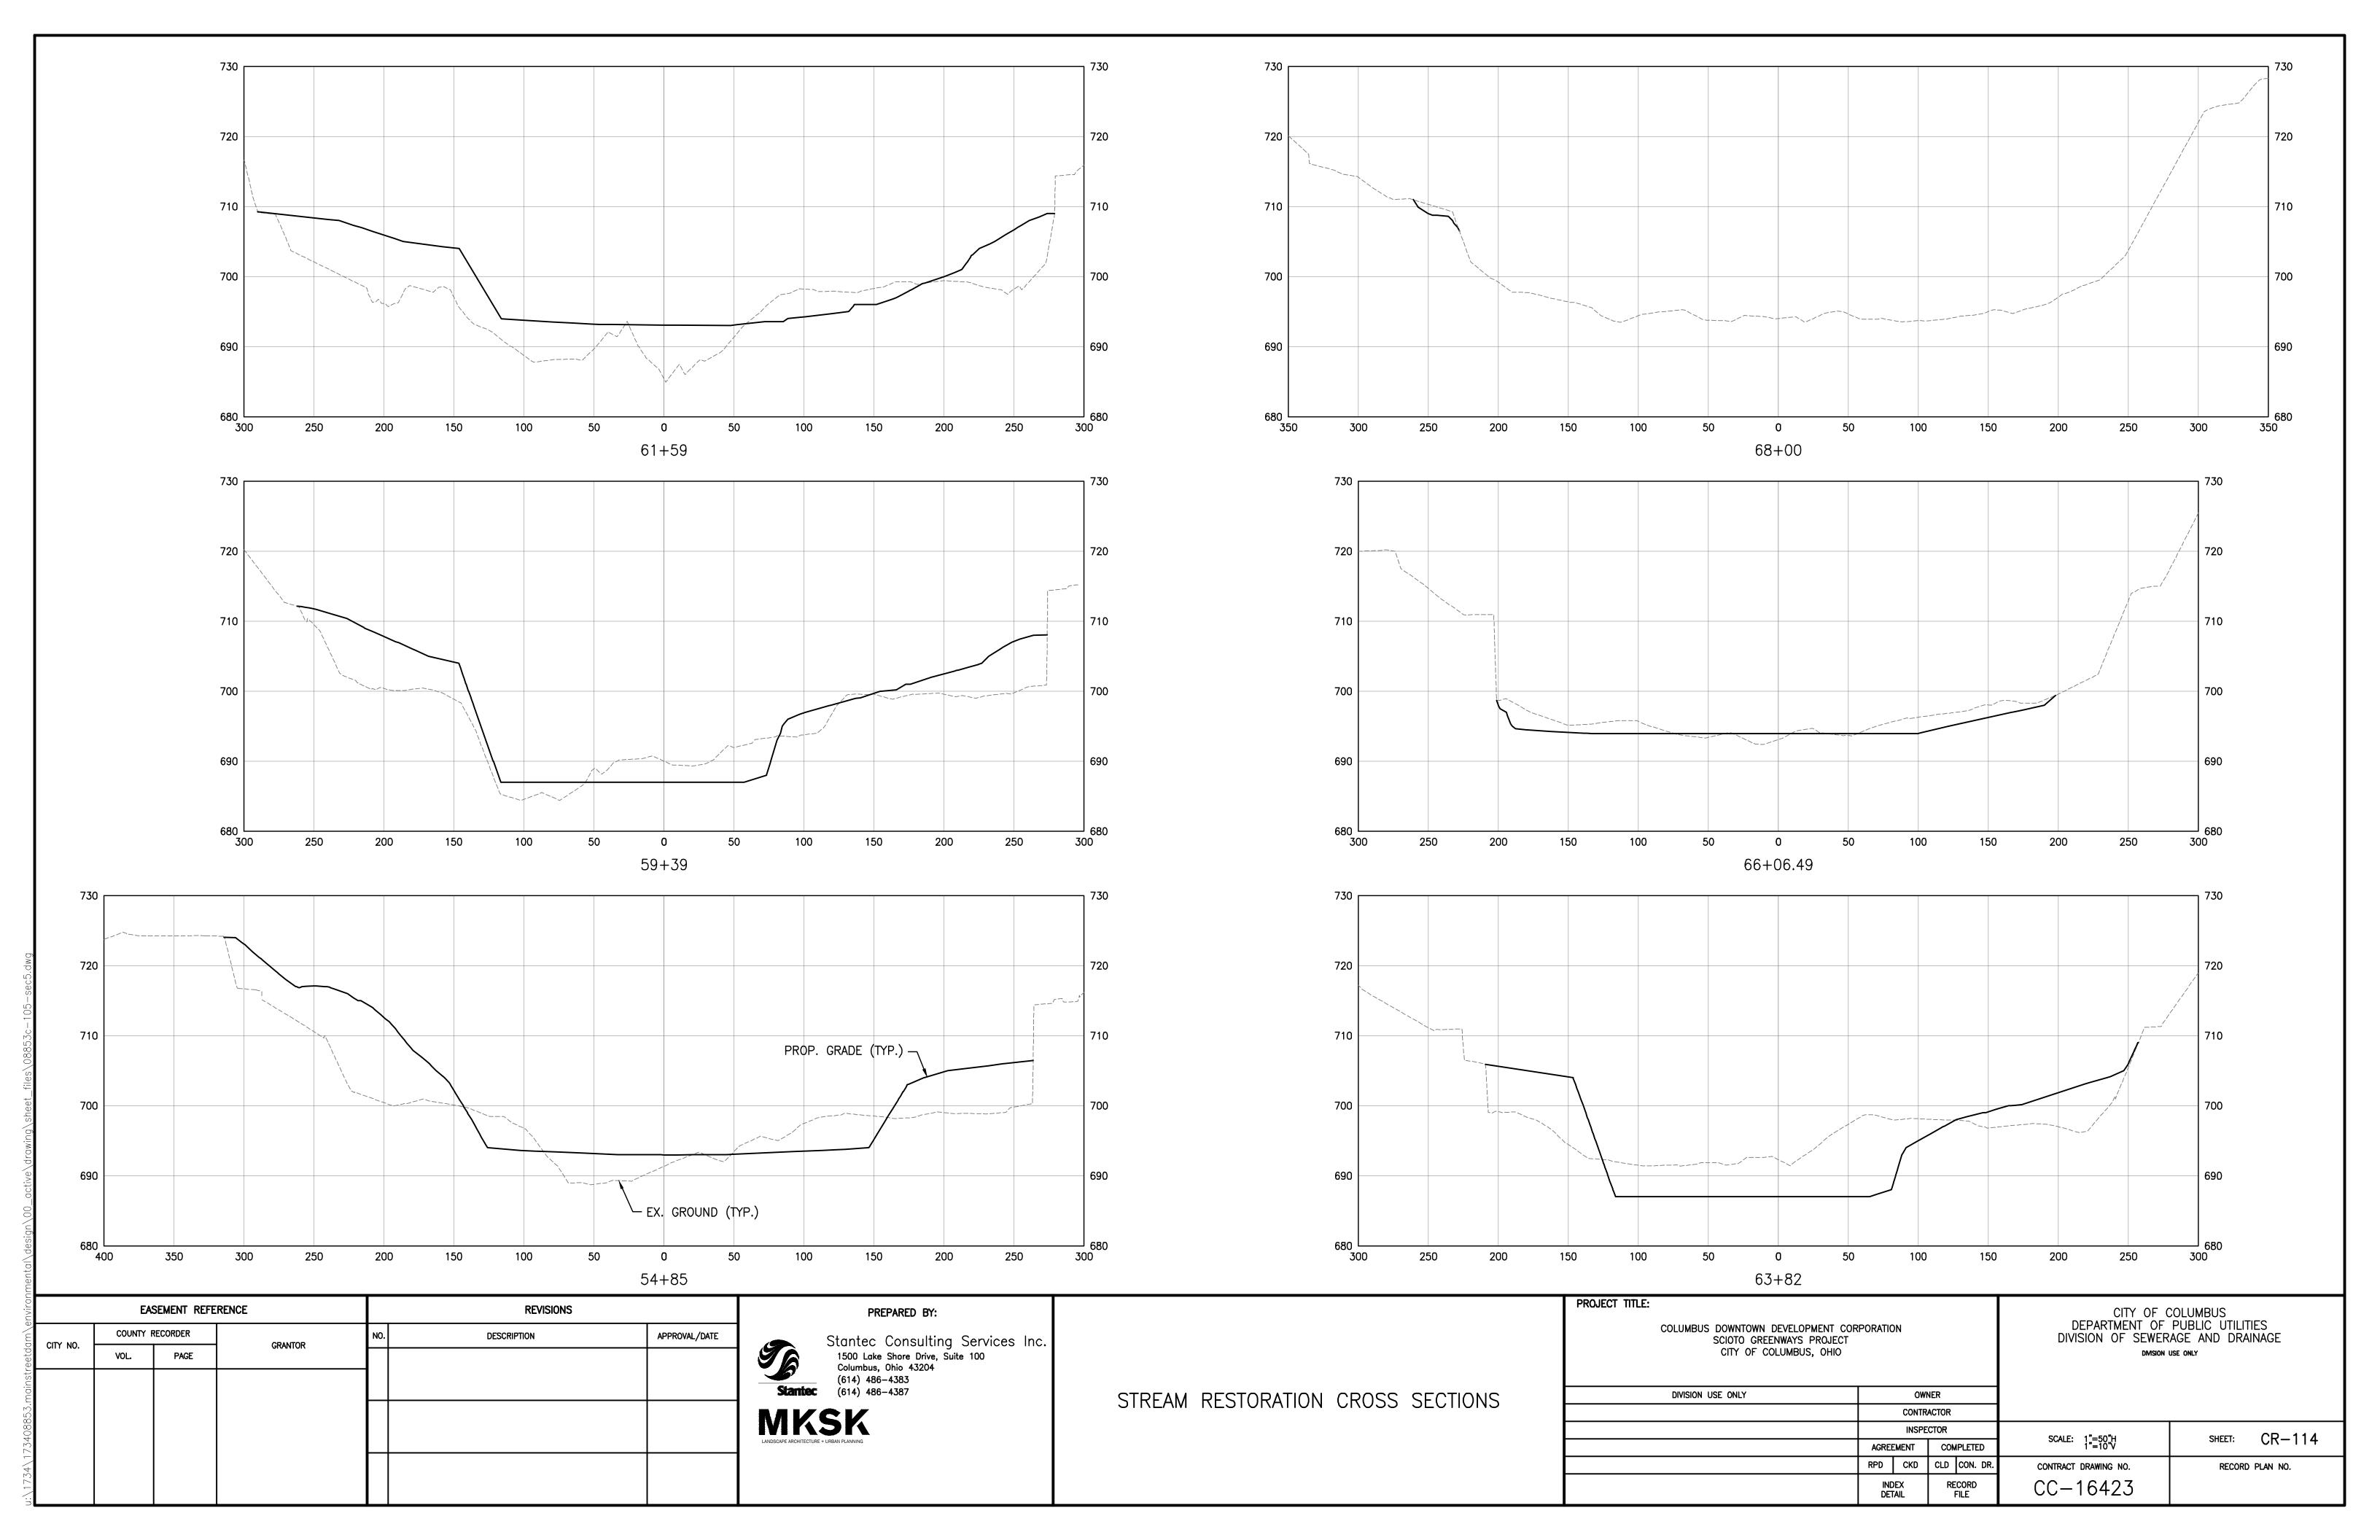

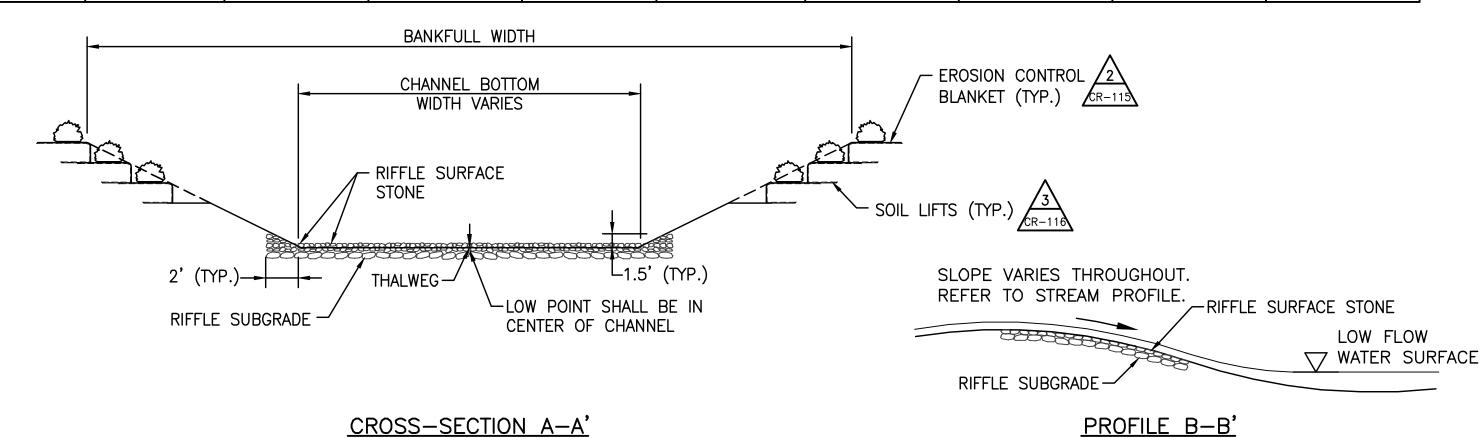


NOTES:

- 1. THE LOWEST POINT SHALL BE IN THE CENTER OF THE CHANNEL
- 2. RIFFLE SUBGRADE DEPTH SHALL BE DEPTH AS SHOWN IN TABLE. RIFFLE SURFACE STONE DEPTH SHALL BE 0.5 FT.
- 3. RIFFLE SUBGRADE SHALL CONSIST OF THE ODOT TYPE RIPRAP SHOWN IN THE TABLE IN THIS DETAIL AND SHALL EXTEND 2 FT. BEYOND TOE OF CHANNEL BANK
- 4. RIFFLE SURFACE STONE SHALL CONSIST OF RIVER RUN GRAVEL/COBBLE, APPROXIMATELY 4 IN. SIZE. GRAVEL SUBSTRATE FROM THE EXISTING CHANNEL SHALL BE STOCKPILED AND REUSED AS SURFACE STONE IN THE NEW CHANNEL WHERE FEASIBLE AND AS APPROVED BY THE ENGINEER. RIVER RUN GRAVEL/COBBLE SHALL EXTEND 2 FT. BEYOND TOE OF BANK AND 1.5 FT. ABOVE THE CHANNEL BOTTOM AS SHOWN IN A—A' OF THIS DETAIL.
- 5. GRAVEL SHALL BE PLACED AT EACH RIFFLE LOCATION IN ACCORDANCE WITH THE GRADES SHOWN ON THESE PLANS.
- 6. SOME EXCAVATION OF CHANNEL BED MATERIAL MAY BE NECESSARY PRIOR TO PLACEMENT OF RIFFLE TO ENSURE PROPER CROSS—SECTIONAL DIMENSIONS ONCE RIFFLE IS CONSTRUCTED. RE—DRESSING OF CHANNEL AND BANKS MAY BE REQUIRED FOLLOWING CONSTRUCTION OF RIFFLES AND CHANNEL AND SHALL BE ACCOUNTED FOR IN CONTRACTOR'S BID ITEM.

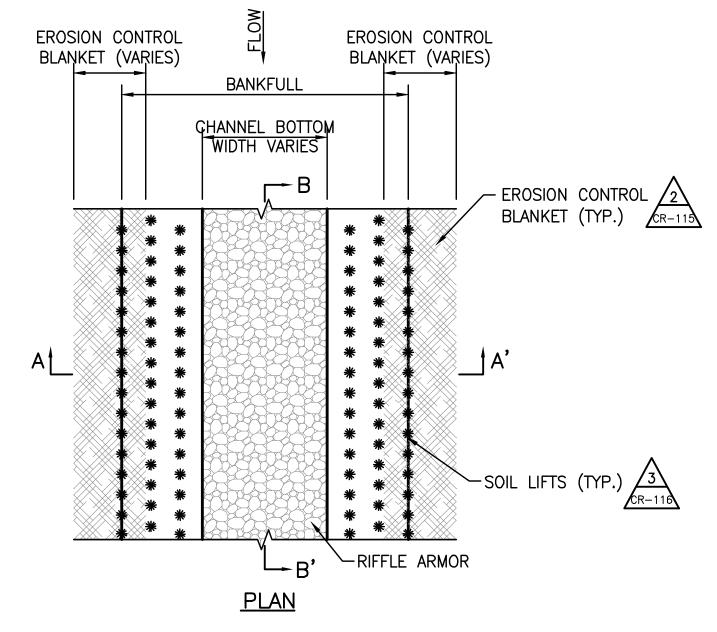

DETAIL - RIFFLE ARMOR

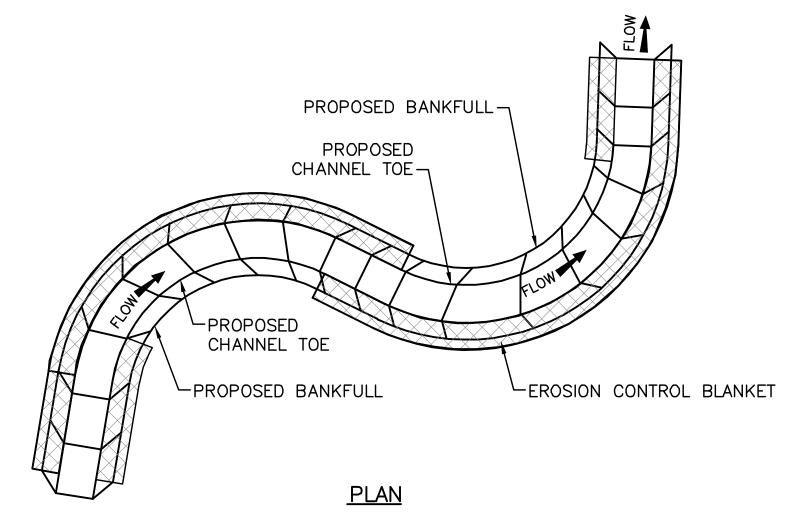

NOTES:


- 1. PREPARE SOIL, SOW SEED AND PLACE STRAW WHERE FABRIC IS TO BE INSTALLED PRIOR TO INSTALLING EROSION CONTROL FABRIC.
- 2. EROSION CONTROL BLANKET SHALL CONSIST OF ECOGRO 400 GRAM/M² COIR BLANKET OR APPROVED EQUIVALENT.
- 3. FASTENERS SHALL BE 1"X1"X36" WOOD STAKES NOTCHED TO "HOOK" THE EROSION CONTROL BLANKET OR APPROVED EQUIVALENT, INSTALLED AT A RATE OF 4 STAKES PER SQUARE YARD. NOMINAL SPACING IS 20 INCHES PERPENDICULAR TO FLOW AND 24 INCHES PARALLEL TO FLOW. REFER TO WOOD STAKE DETAIL, SHEET CR-116.
- 4. FABRIC SHALL BE SECURED TO THE GROUND SUCH THAT FABRIC DOES NOT SEPARATE FROM GROUND MORE THAN 1 INCH WITH A REASONABLE TUG. ADDITIONAL FASTENERS WILL BE REQUIRED IF FABRIC FAILS THIS PULL TEST.
- 5. OVERLAP BETWEEN ADJACENT RUNS OF FABRIC SHALL BE A MINIMUM OF 6 INCHES. FABRIC SHALL OVERLAP IN THE DOWNSTREAM DIRECTION PARALLEL TO FLOW AND DOWN—SLOPE PERPENDICULAR TO FLOW.
- 6. TERMINAL ENDS OF FABRIC SHALL BE SECURED BY FASTENERS SPACED 6 INCHES APART.
- 7. WHERE BANK STABILITY TREATMENTS ARE NOT CALLED OUT ON THE PLANS, EROSION CONTROL BLANKET SHALL BE PLACED ALONG THE OUTSIDE OF ALL BENDS AND ALONG BOTH SIDES OF THE CHANNEL IN RIFFLE AREAS.
- 8. EROSION CONTROL BLANKET SHALL EXTEND 5 FEET BEYOND BANKFULL AT ALL LOCATIONS.
- 9. AT RIFFLE FEATURES, BLANKET SHALL EXTEND TO THE ROCK/SOIL INTERFACE NEAR THE TOE OF THE BANK, OR A MINIMUM OF 6 INCHES BELOW THE LOW-FLOW WATER SURFACE, WHICHEVER IS MORE LIMITING.
- 10. AT POOL FEATURES, BLANKET SHALL EXTEND A MINIMUM OF 6 INCHES BELOW THE LOW-FLOW WATER SURFACE.

DETAIL - EROSION CONTROL BLANKET

NOT TO SCALE


	EA	SEMENT REFE	RENCE		REVISIONS		PREPARED BY:	
CITY NO.	COUNTY	RECORDER	GRANTOR	NO.	DESCRIPTION	APPROVAL/DATE	Stantec Consulting Services Inc.	
OIT NO.	VOL.	PAGE	GIVARION				1500 Lake Shore Drive, Suite 100 Columbus, Ohio 43204	
							(614) 486–4383 Stantec (614) 486–4387	CTDEANA DECTODATION DETAILS
							MKSK	STREAM RESTORATION DETAILS
							LANDSCAPE ARCHITECTURE + URBAN PLANNING	


PROJECT TITLE: CITY OF COLUMBUS DEPARTMENT OF PUBLIC UTILITIES COLUMBUS DOWNTOWN DEVELOPMENT CORPORATION DIVISION OF SEWERAGE AND DRAINAGE SCIOTO GREENWAYS PROJECT CITY OF COLUMBUS, OHIO DMSION USE ONLY DIVISION USE ONLY OWNER CONTRACTOR INSPECTOR SHEET: CR-115 SCALE: NONE AGREEMENT COMPLETED RPD | CKD | CLD | CON. DR CONTRACT DRAWING NO. RECORD PLAN NO. RECORD CC-16423 DETAIL

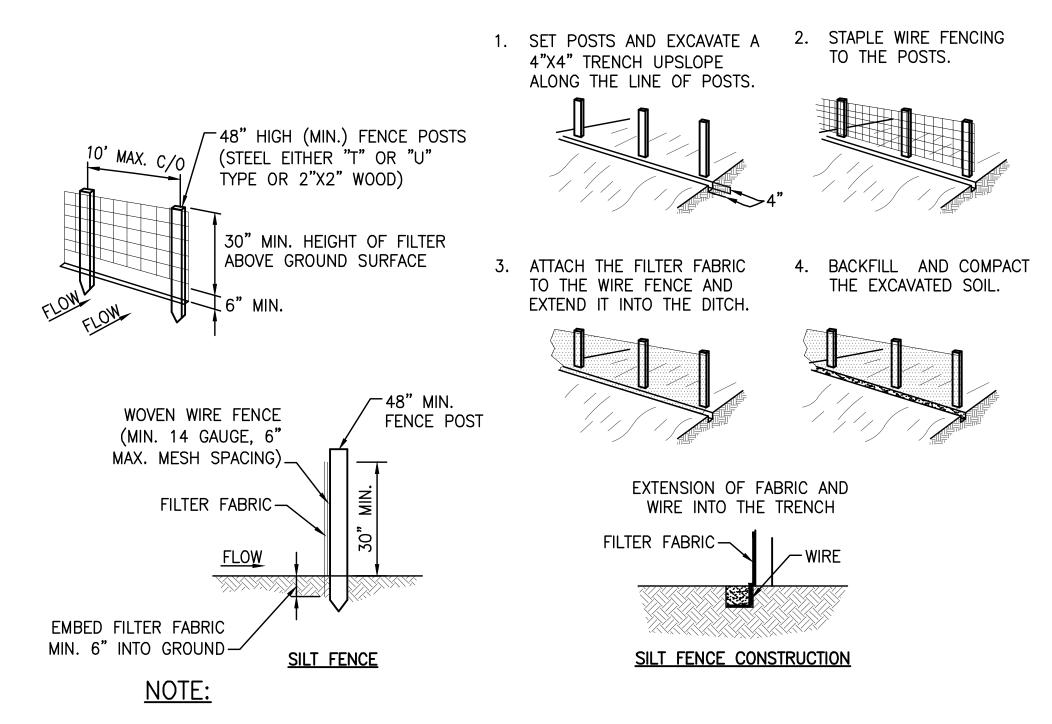

1. SILT FENCES SHALL CONSIST OF FILTER FABRIC AND WOODEN LATHS FENCES SHALL BE PLACED DOWNGRADIENT OF CONSTRUCTION AREAS, AS NECESSARY TO CONTROL SEDIMENT AND MINIMIZE EROSION UNTIL VEGETATION IS ESTABLISHED. ALL SILT FENCING IS TO BE IN PLACE PRIOR TO ANY CONSTRUCTION. EXTRA STRENGTH FILTER FABRIC (50 LBS./LIN.IN.MIN.) MAY BE USED IN LIEU OF THE STANDARD STRENGTH (30 LBS./LIN.IN.MIN.) FILTER FABRIC AND THE 14 GAUGE WOVEN WIRE FENCE COMBINATION.




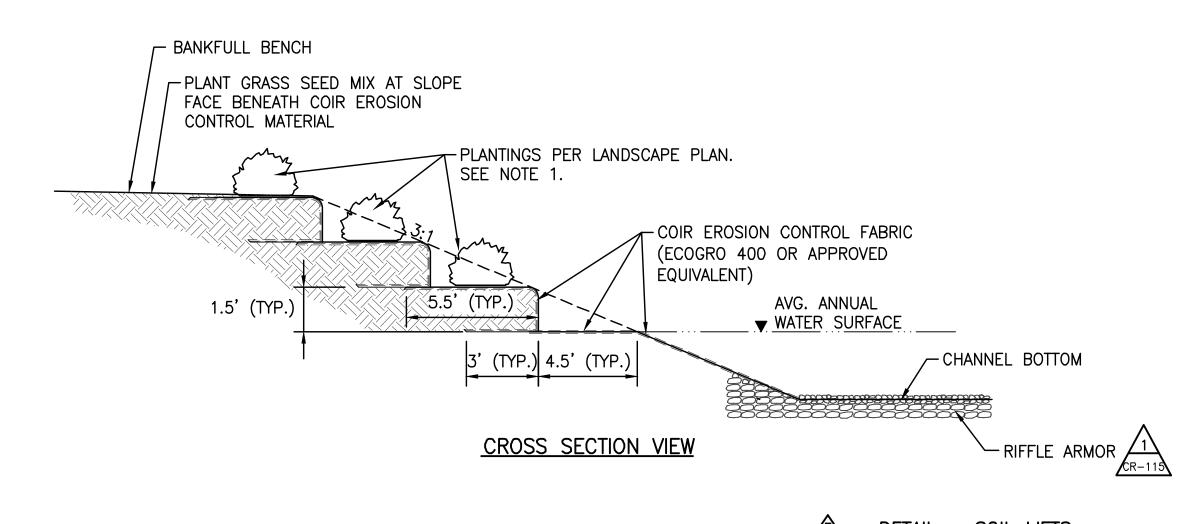

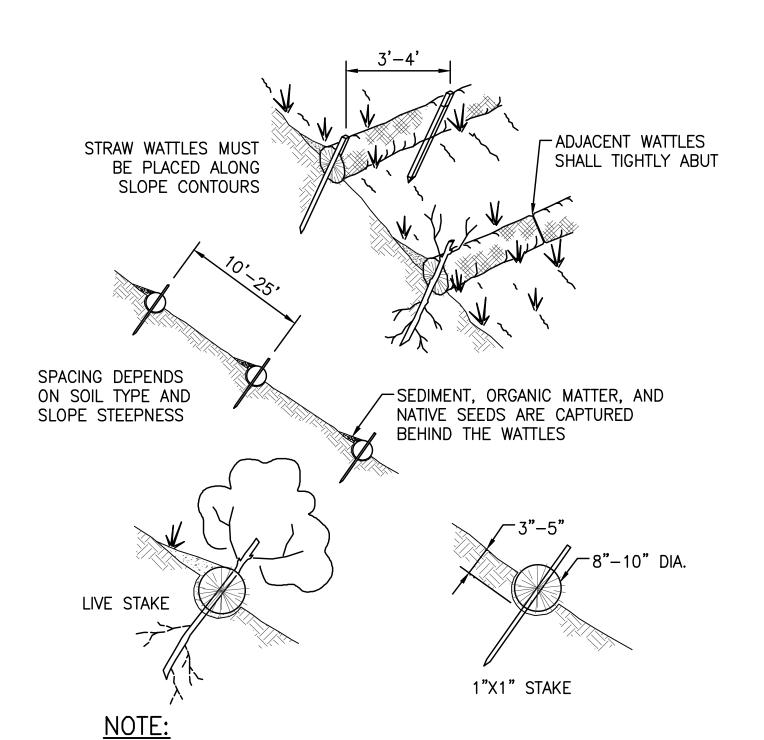

1. STRAW WATTLE INSTALLATION REQUIRES THE PLACEMENT AND SECURE STAKING OF THE WATTLE IN A TRENCH, 3"-5" DEEP, DUG ON CONTOUR. RUNOFF MUST NOT BE ALLOWED TO RUN UNDER OR AROUND WATTLE.



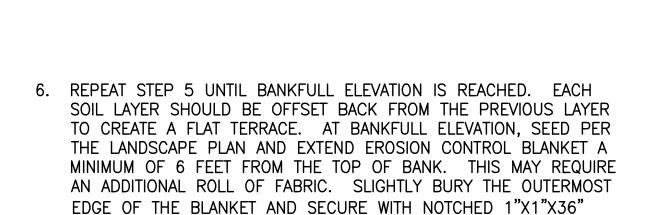

7. INSTALL PLANTINGS PER THE LANDSCAPE PLAN ON EACH TERRACE. CUT THE MINIMUM AMOUNT OF EROSION CONTROL BLANKET NECESSARY TO INSTALL THE PLANTINGS.

WOOD STAKES AT A RATE OF 1 PER LINEAR FOOT OF BANK.

NOTES:

- 1. PLANTINGS SHALL BE PER THE LANDSCAPE PLAN. SEE PLANS TITLED "SCIOTO GREENWAYS SITE IMPROVEMENTS" PREPARED BY
- 2. CONSTRUCT SOIL LIFTS WITH WOODY TRANSPLANTS BY FIRST SHAPING THE BANKFULL CHANNEL TO THE GRADES SPECIFIED.
- 3. SOIL LIFTS SHALL BEGIN AT THE AVERAGE ANNUAL WATER SURFACE
- 4. VERIFY A MINIMUM OF 3 INCHES OF SOIL IS PLACED OVER THE SURFACE OF THE EXTENDED RIFFLE ARMOR FROM THE SLOPE FACE TO 3 FEET AWAY FROM THE CHANNEL.
- 5. PLACE A 10 FOOT WIDE STRIP OF EROSION CONTROL BLANKET ALONG THE SURFACE WITH THE OUTER EDGE LYING 3 FEET BEYOND THE PROPOSED TOE OF SLOPE. BACKFILL OVER THE OUTSIDE 3 FEET WITH SOIL. SOIL LAYERS SHALL BE 1.5 FEET IN HEIGHT AND BE PLACED IN LIFTS OF 6 INCHES WITH EACH LIFT COMPACTED USING THE EXCAVATOR BUCKET. SEED THE FACE OF THE SOIL LAYER AS PER THE LANDSCAPE PLAN. WRAP THE REMAINING BLANKET OVER THE SOIL LAYER AND PLACE 1"X1"X36" WOOD STAKES THROUGH THE BLANKET AND SOIL LAYER. STAKES SHOULD BE NOTCHED TO "HOOK" THE EROSION CONTROL BLANKET AND SHALL BE PLACED AT A RATE OF 1 PER LINEAR FOOT OF BANK. REFER TO WOOD STAKE DETAIL, SHEET CR-116.

EASEMENT REFERENCE **REVISIONS** COUNTY RECORDER DESCRIPTION APPROVAL/DATE CITY NO. GRANTOR PAGE VOL.

PREPARED BY: Stantec Consulting Services Inc. 1500 Lake Shore Drive, Suite 100 Columbus, Ohio 43204 (614) 486-4383 **Stantec** (614) 486–4387 MKSK


STREAM RESTORATION DETAILS

PROJECT TITLE: COLUMBUS DOWNTOWN DEVELOPMENT COR SCIOTO GREENWAYS PROJECT CITY OF COLUMBUS, OHIO	RPORATION			CITY OF (DEPARTMENT OF DIVISION OF SEWER	PUBLIC UTILITIES AGE AND DRAINAGE
DIVISION USE ONLY	OWNER				
		CONTRA	ACTOR		
		INSPE	CTOR	SCALE: NONE	SHEET: CR-116
	AGREEMI	ENT	COMPLETED	SCALL. NONE	31LL1. CK-110
	RPD	CKD	CLD CON. DR.	CONTRACT DRAWING NO.	RECORD PLAN NO.
	INDEX DETAIL		RECORD FILE	CC-16423	

NOTCH 1/4" AT 2" BELOW TOP OF STAKE

FRONT


<u>DETAIL — WOOD STAKE</u>

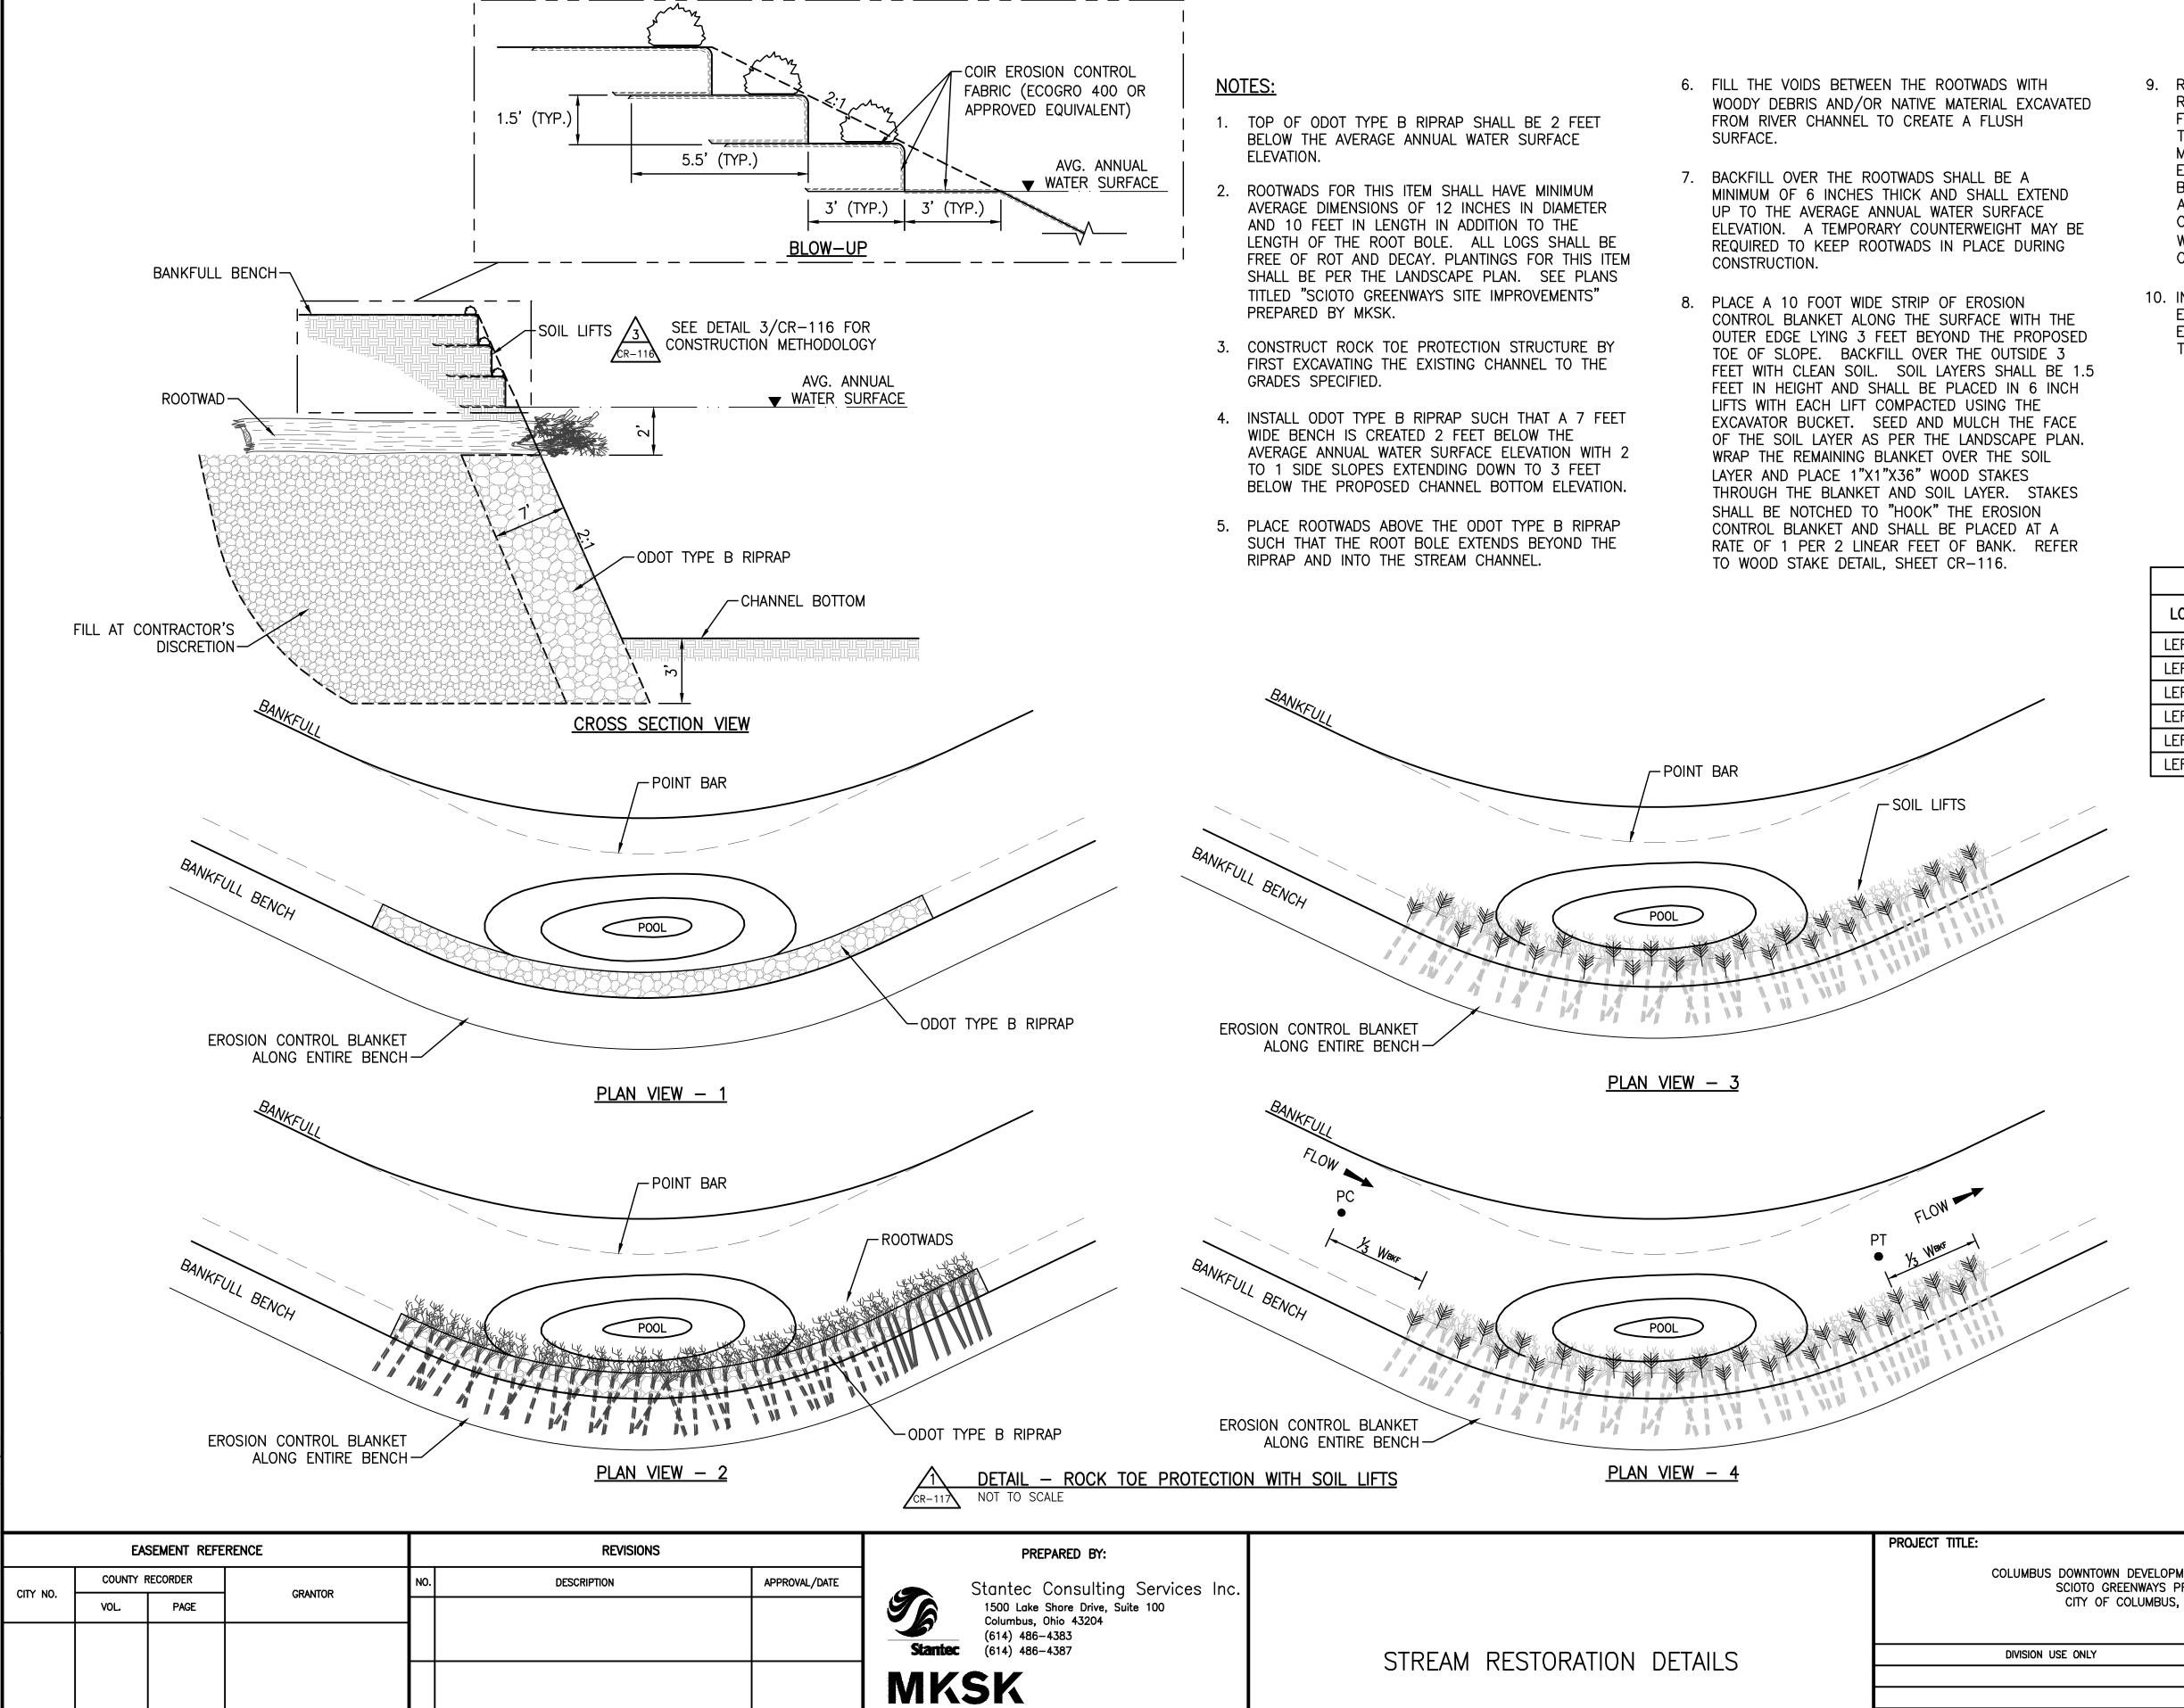



- 9. REPEAT STEP 8 UNTIL BANKFULL ELEVATION IS REACHED. EACH SOIL LAYER SHALL BE OFFSET BACK FROM THE PREVIOUS LAYER TO CREATE A FLAT TERRACE. AT BANKFULL ELEVATION, SEED AND MULCH PER THE LANDSCAPE PLAN AND EXTEND THE EROSION CONTROL BLANKET A MINIMUM OF 6 FEET BEYOND THE TOP OF BANK. THIS MAY REQUIRE AN ADDITIONAL ROLL OF FABRIC. SLIGHTLY BURY THE OUTERMOST EDGE OF THE BLANKET AND SECURE WITH NOTCHED 1"X1"X36" WOOD STAKES AT A RATE OF 1 PER 2 LINEAR FEET OF BANK.
- 10. INSTALL PLANTINGS PER THE LANDSCAPE PLAN ON EACH TERRACE. CUT THE MINIMUM AMOUNT OF EROSION CONTROL BLANKET NECESSARY TO INSTALL THE PLANTINGS.


ROCK T	ROCK TOE PROTECTION WITH SOIL LIFTS LOCATION TABLE										
LOCATION	START STA.	END STA.	AVERAGE WSE AT START STA.	AVERAGE WSE AT END STA.							
LEFT BANK	13+50	18+75	696.7	696.7							
LEFT BANK	26+10	28+75	696.8	696.8							
LEFT BANK	34+50	37+80	696.8	696.8							
LEFT BANK	45+15	46+20	696.8	696.8							
LEFT BANK	57+25	60+75	696.9	696.9							
LEFT BANK	62+50	63+65	696.9	696.9							


CITY OF COLUMBUS
DEPARTMENT OF PUBLIC UTILITIES COLUMBUS DOWNTOWN DEVELOPMENT CORPORATION DIVISION OF SEWERAGE AND DRAINAGE SCIOTO GREENWAYS PROJECT CITY OF COLUMBUS, OHIO DMSION USE ONLY OWNER CONTRACTOR INSPECTOR SHEET: CR-117 SCALE: NONE AGREEMENT COMPLETED RPD CKD CLD CON. DR CONTRACT DRAWING NO. RECORD PLAN NO. RECORD FILE INDEX DETAIL CC - 16423

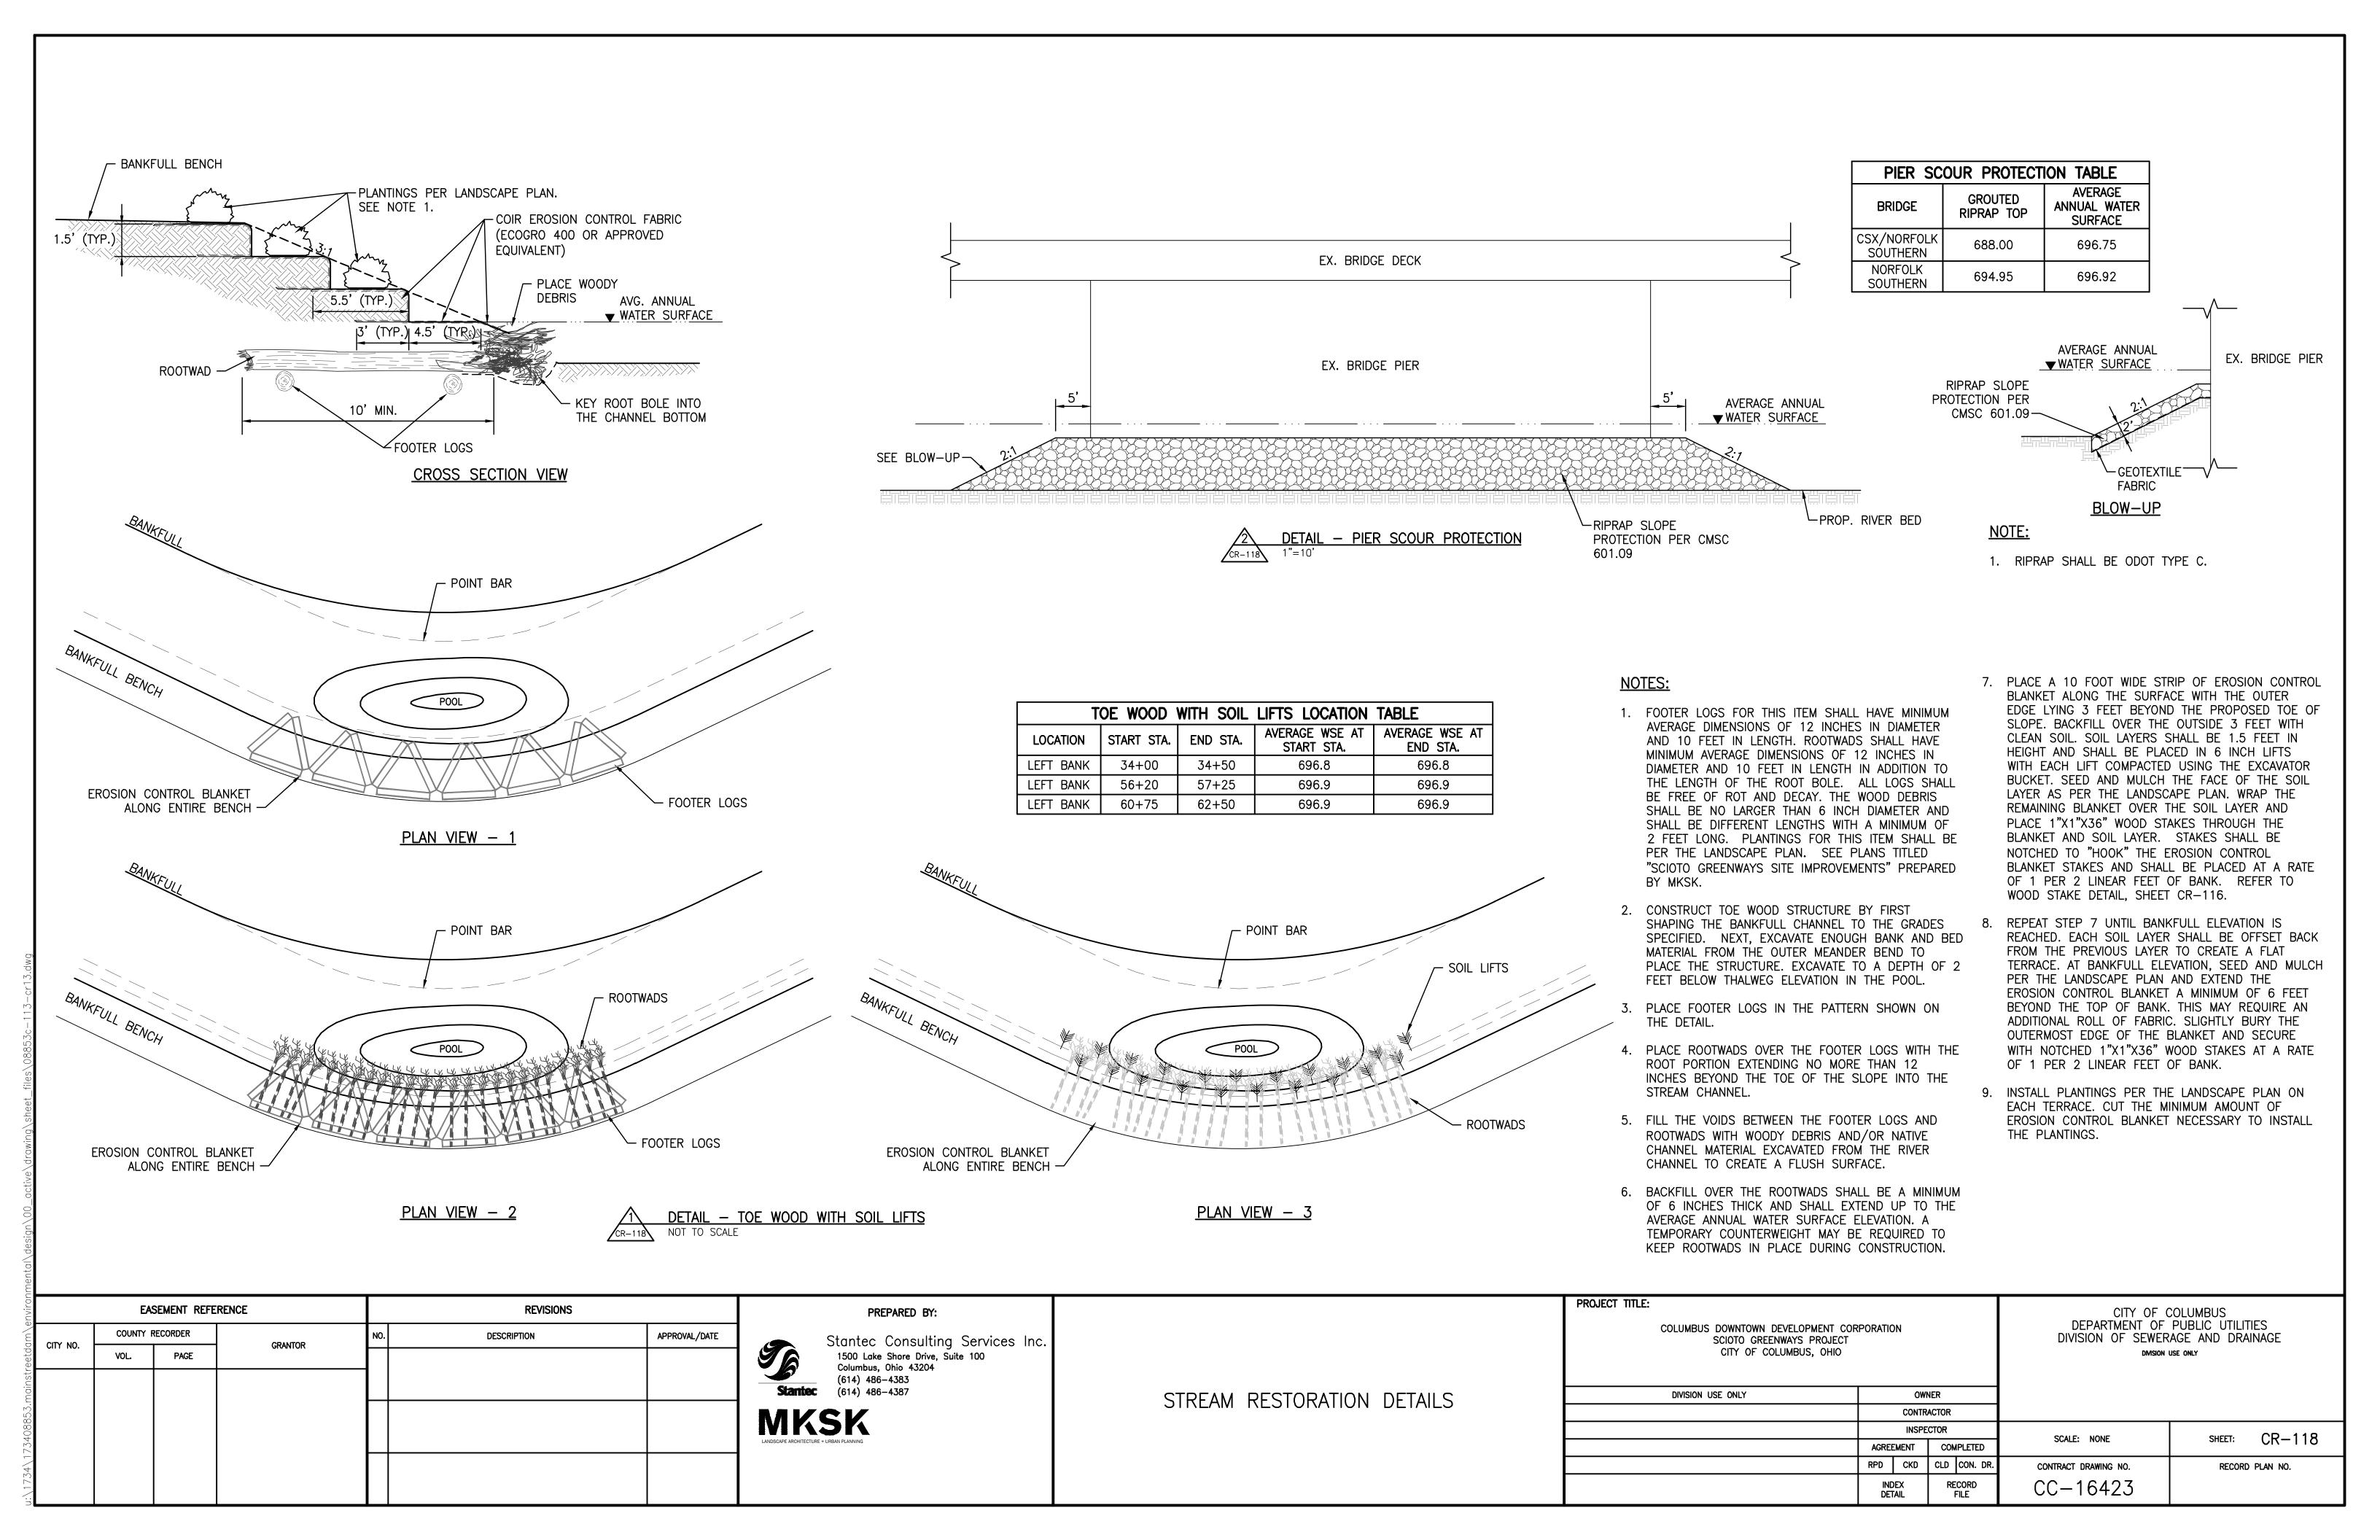

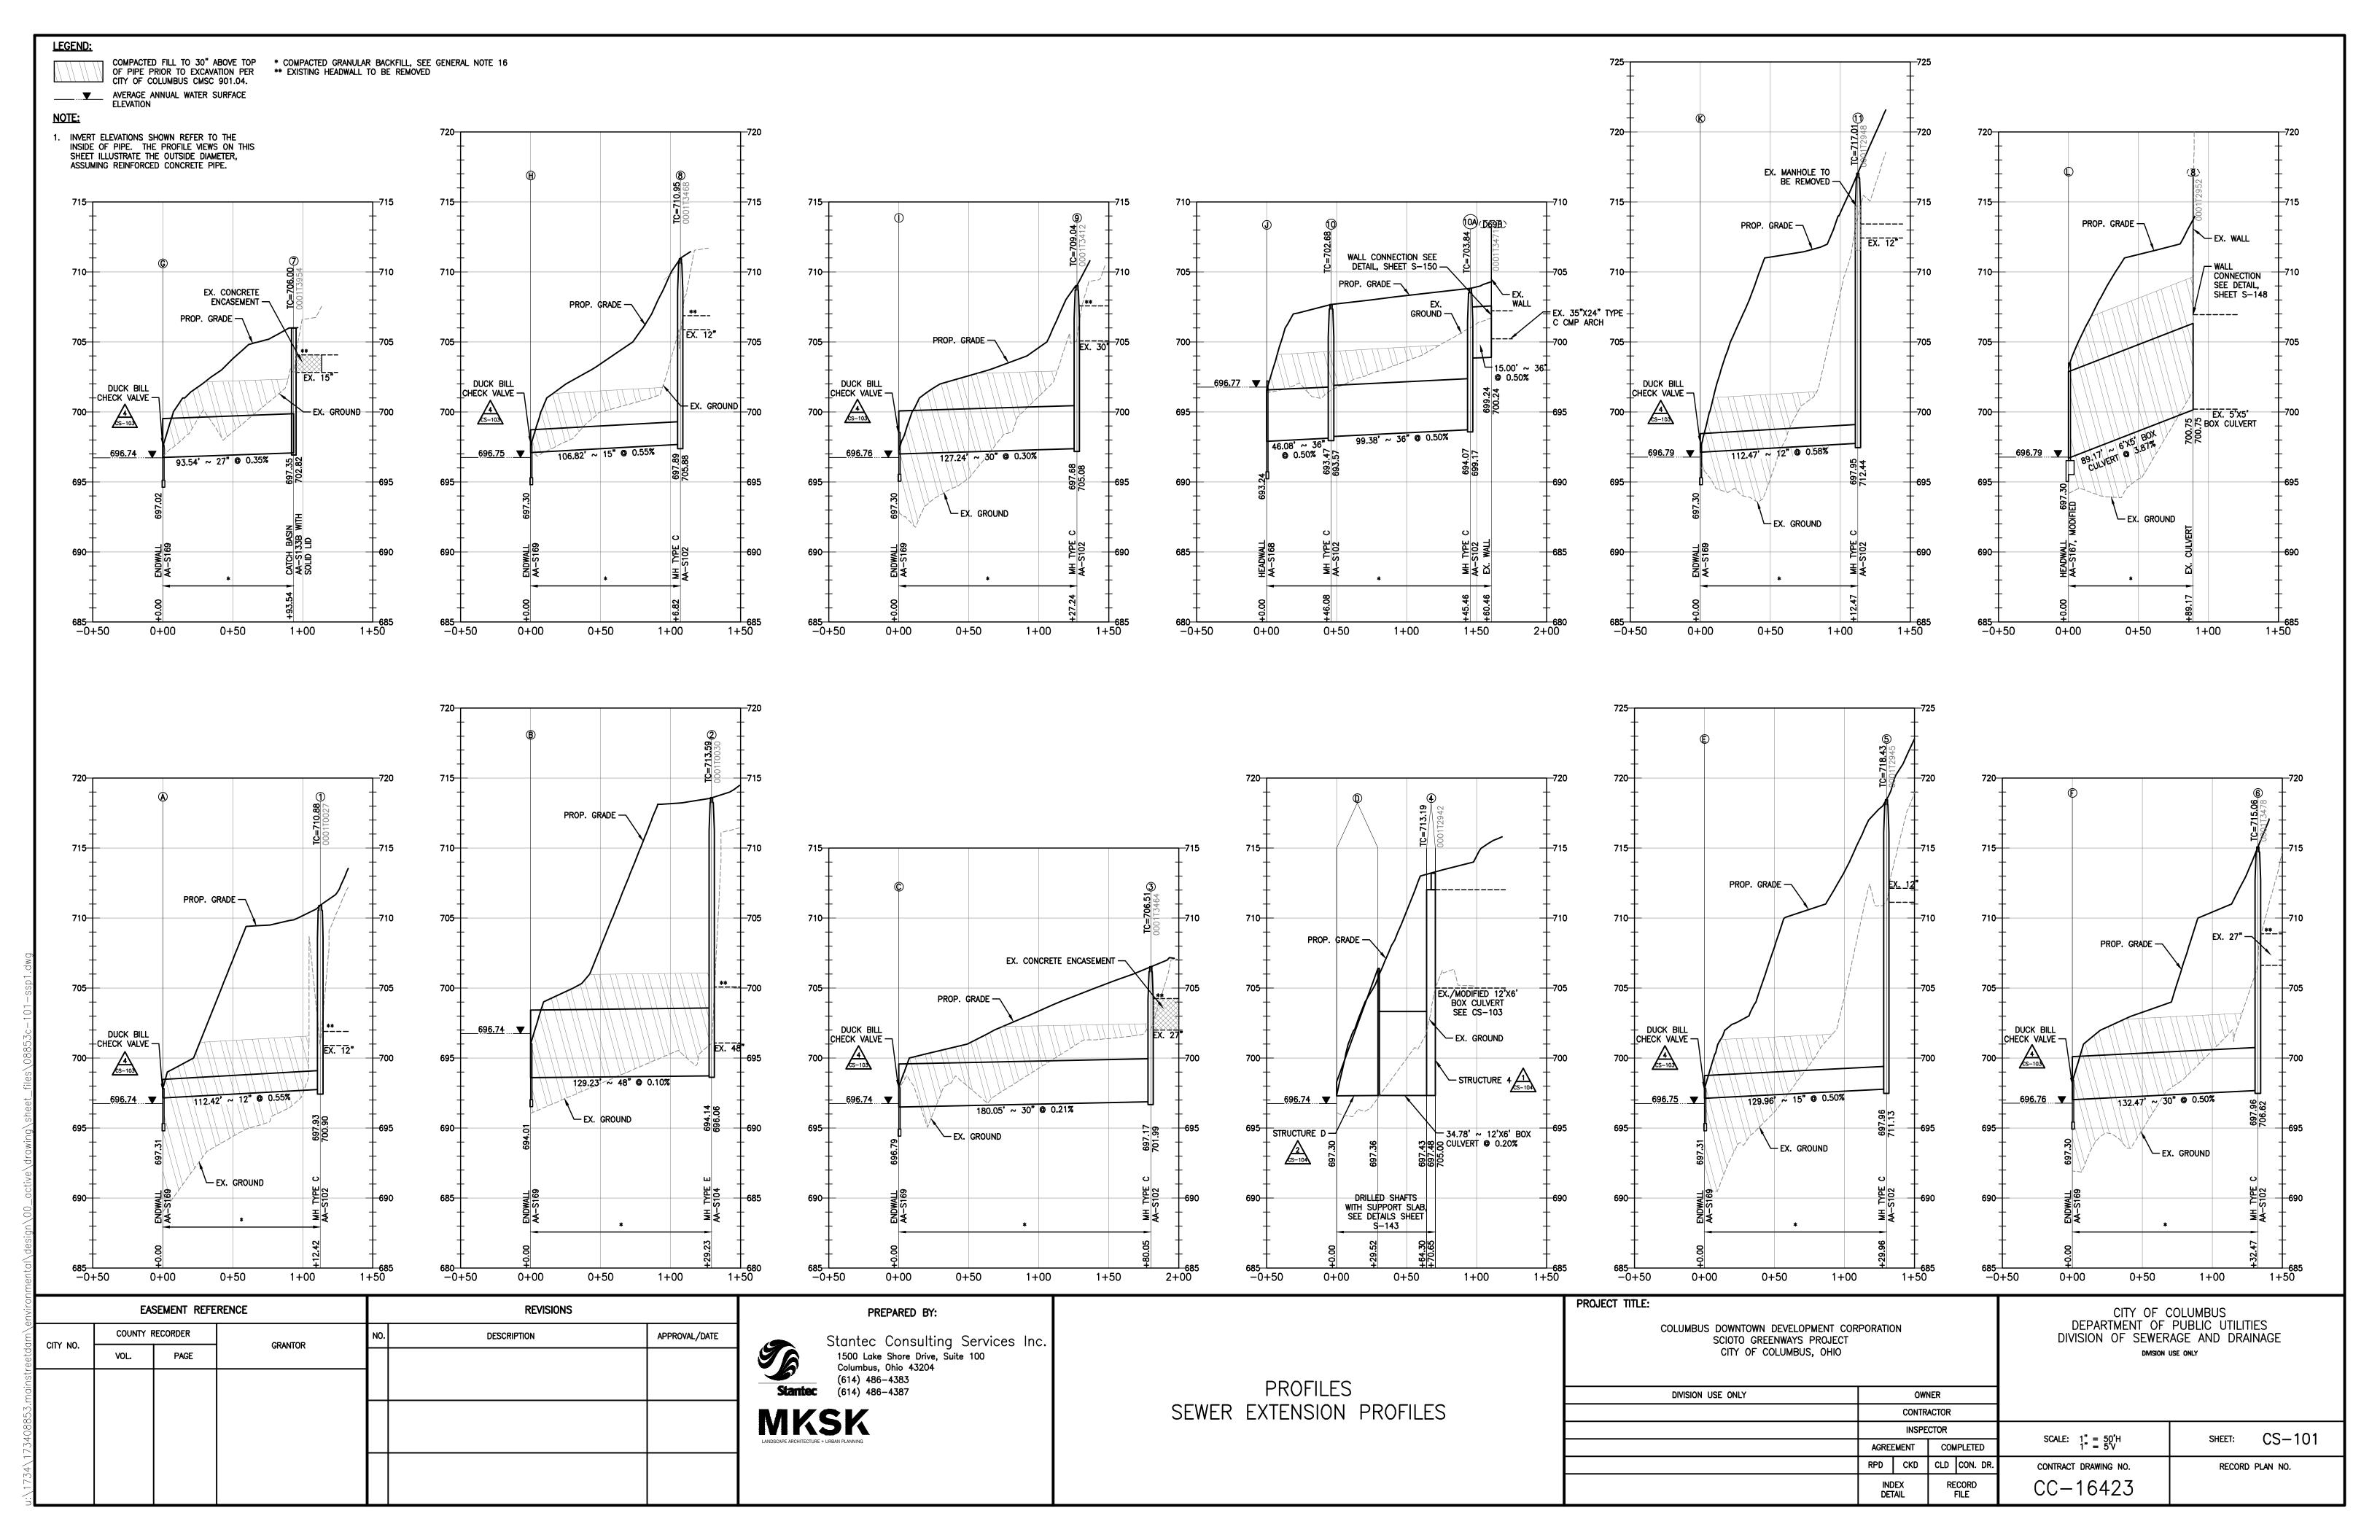


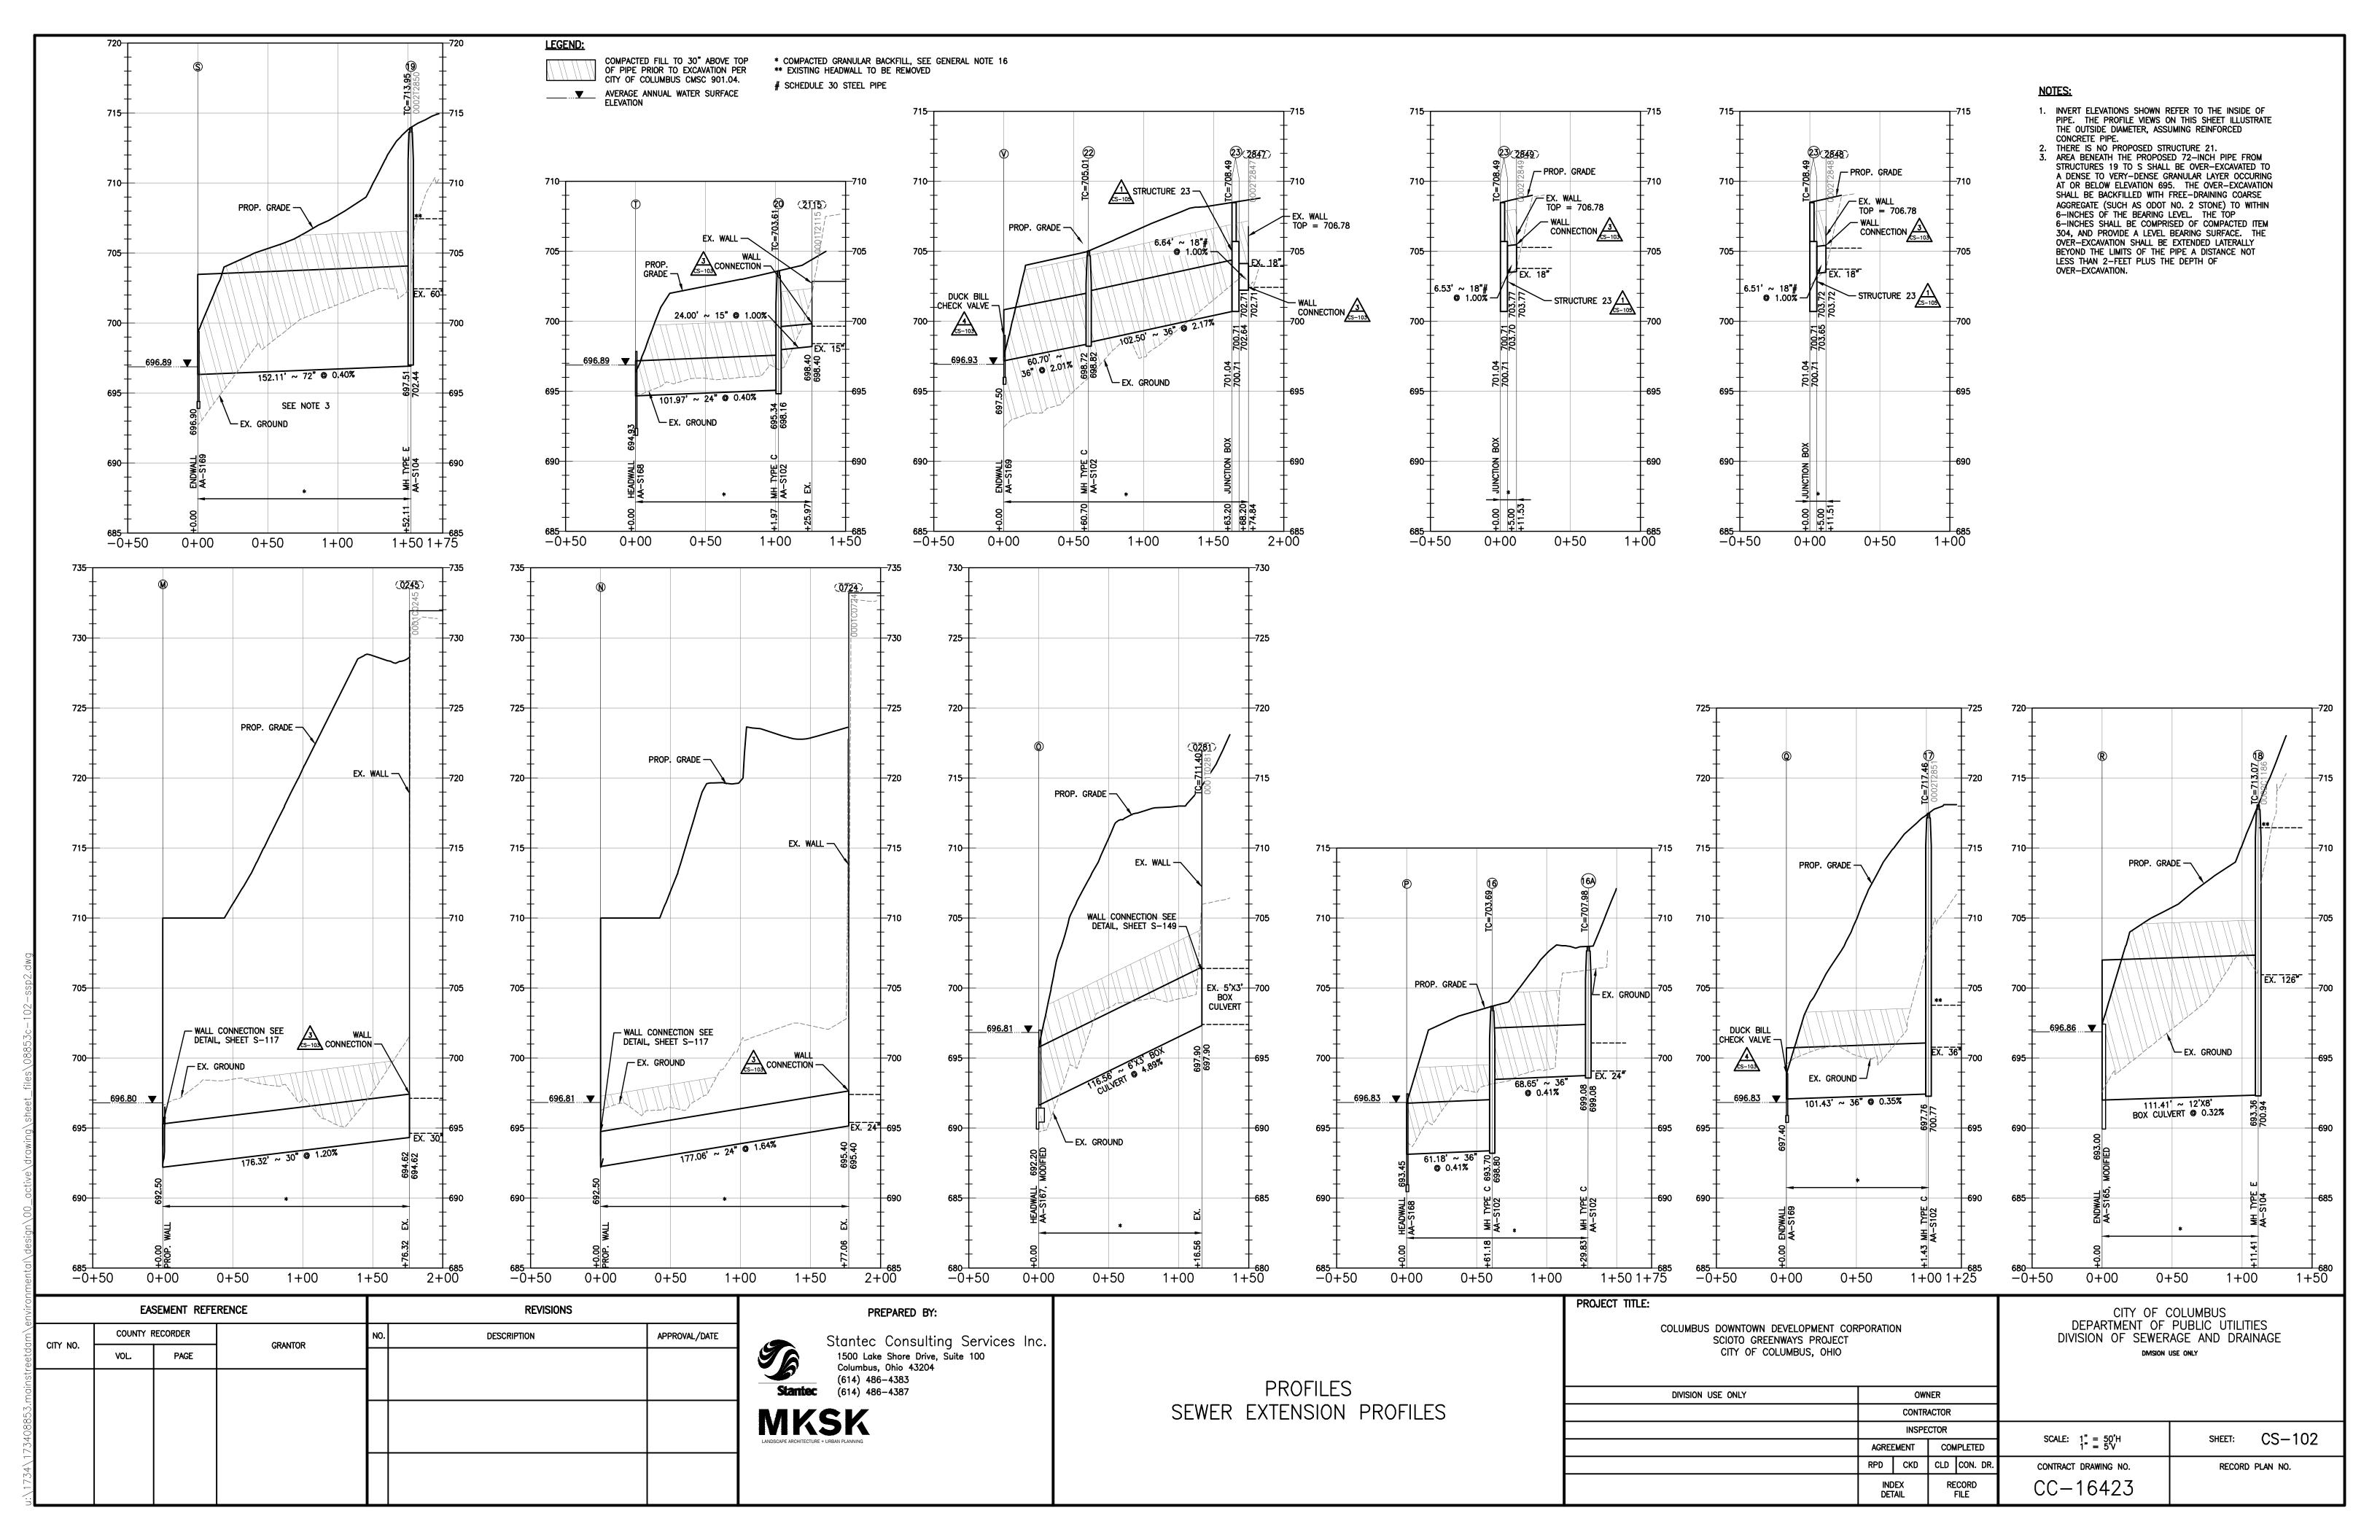

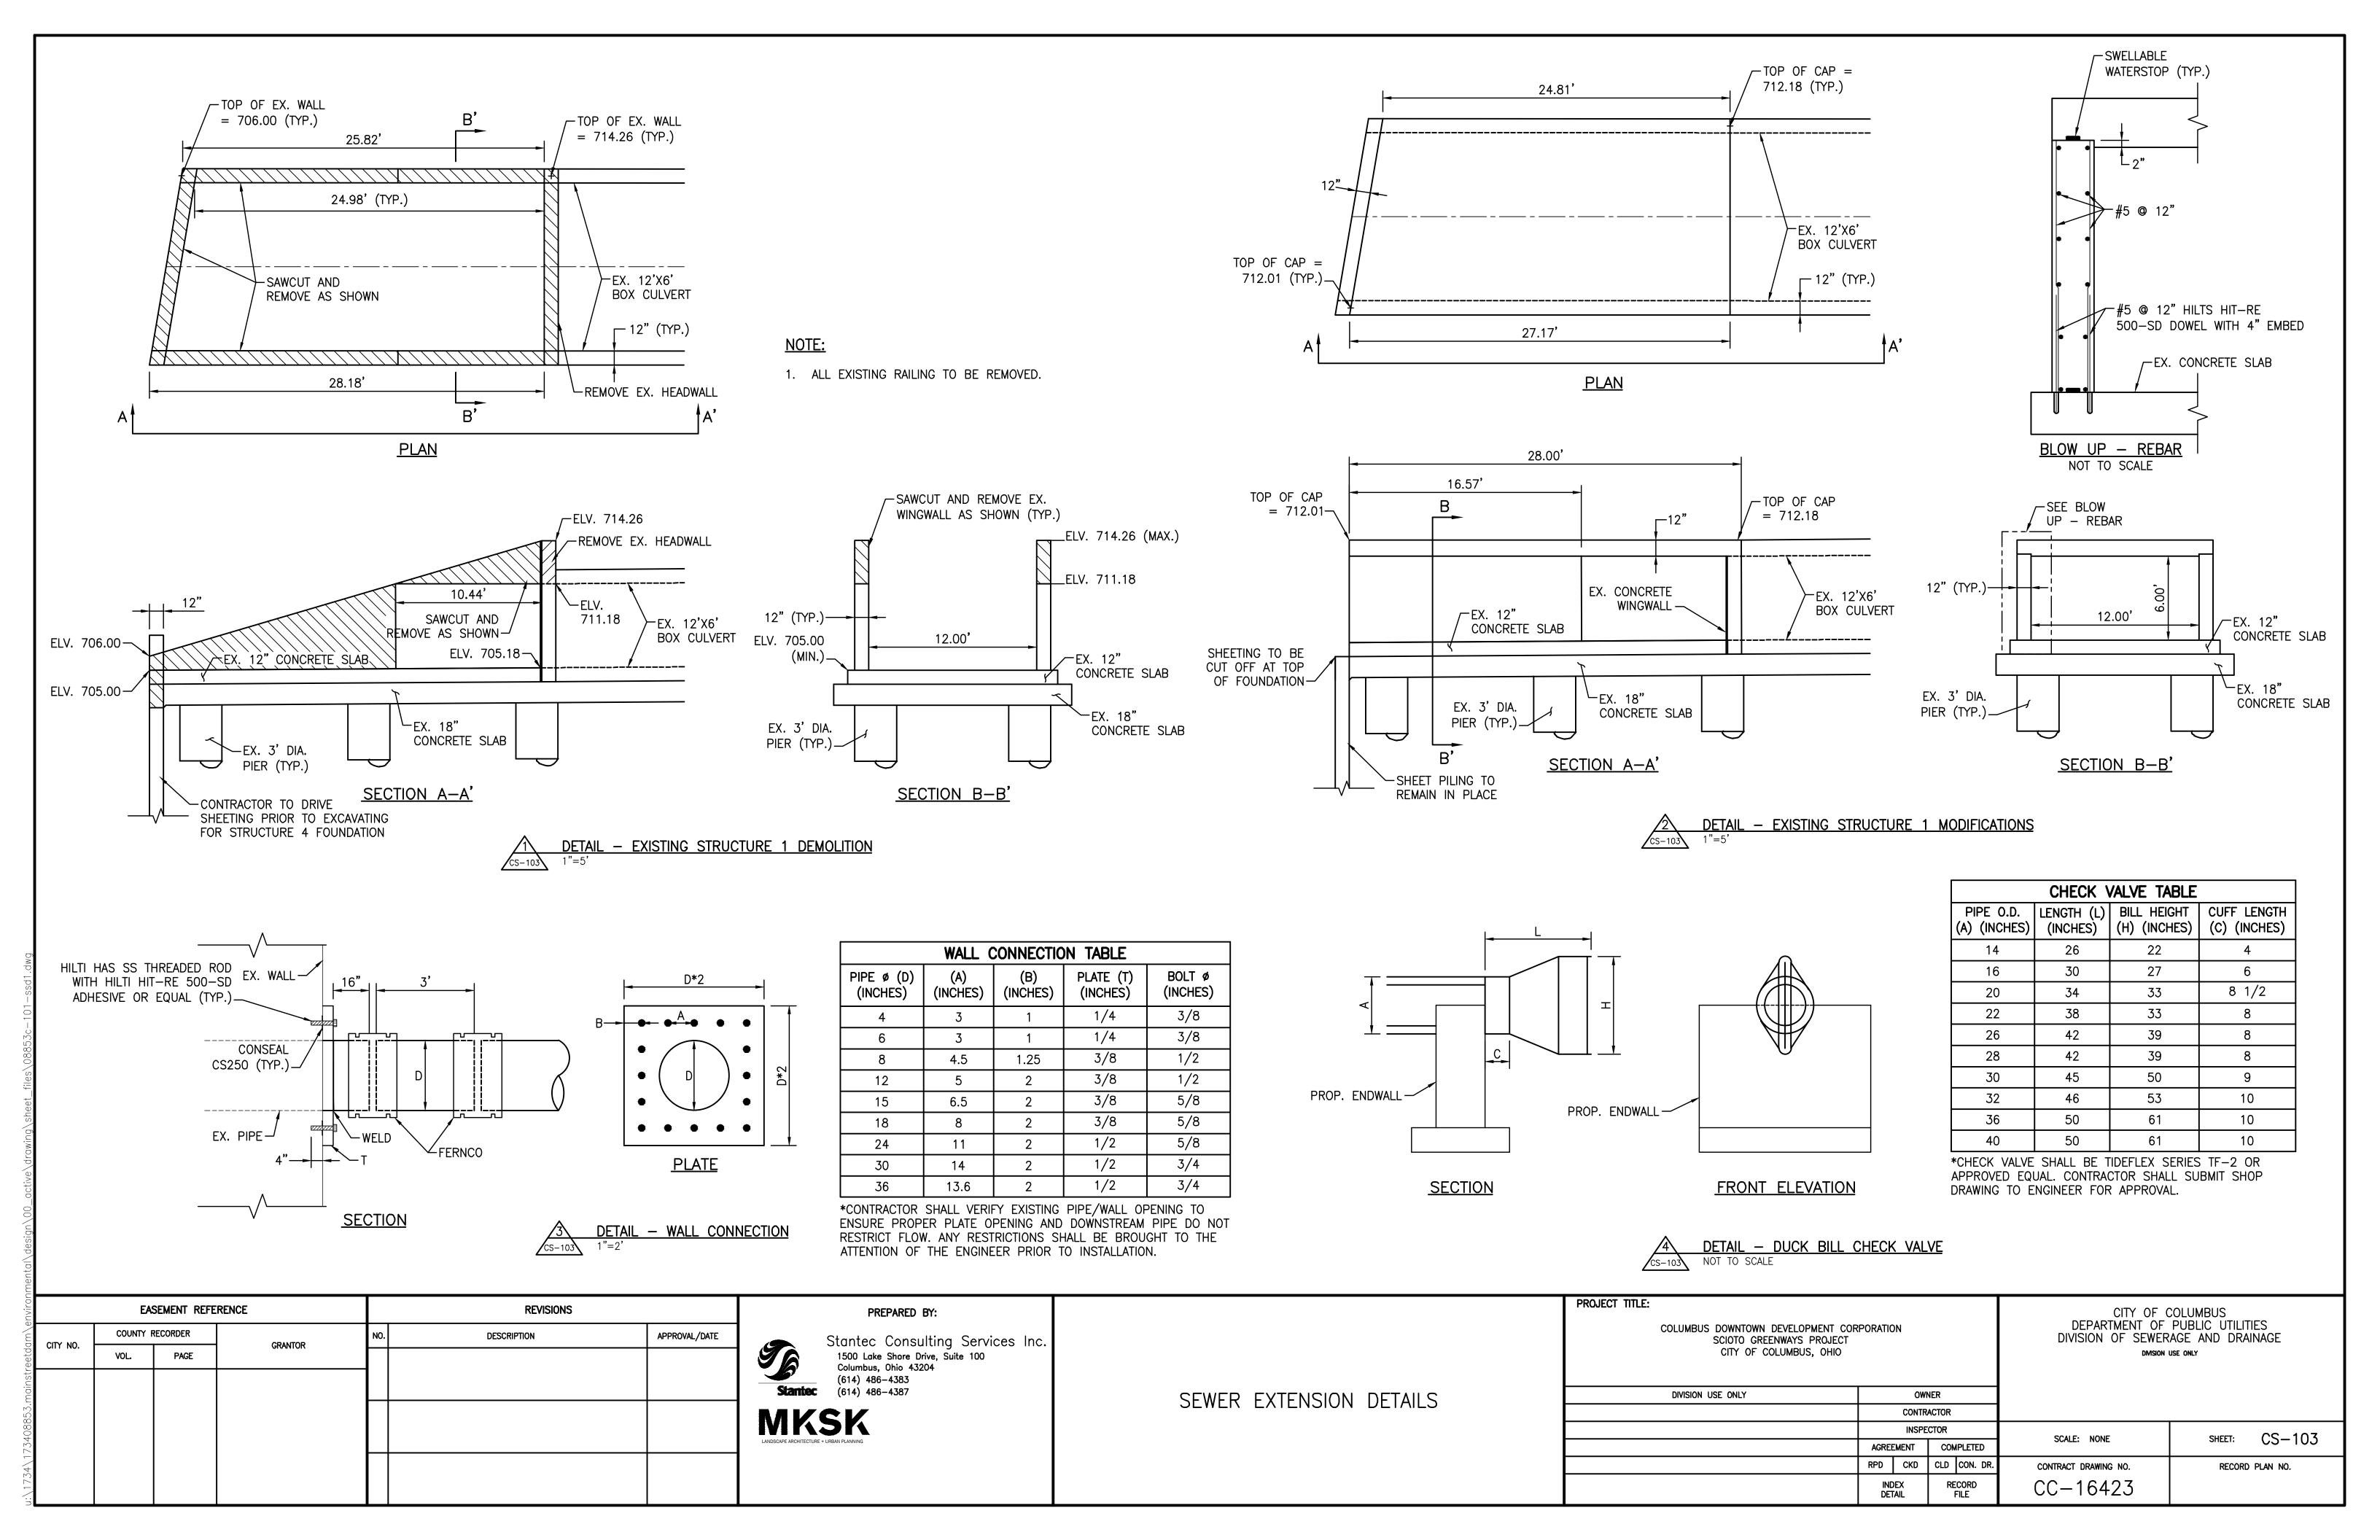

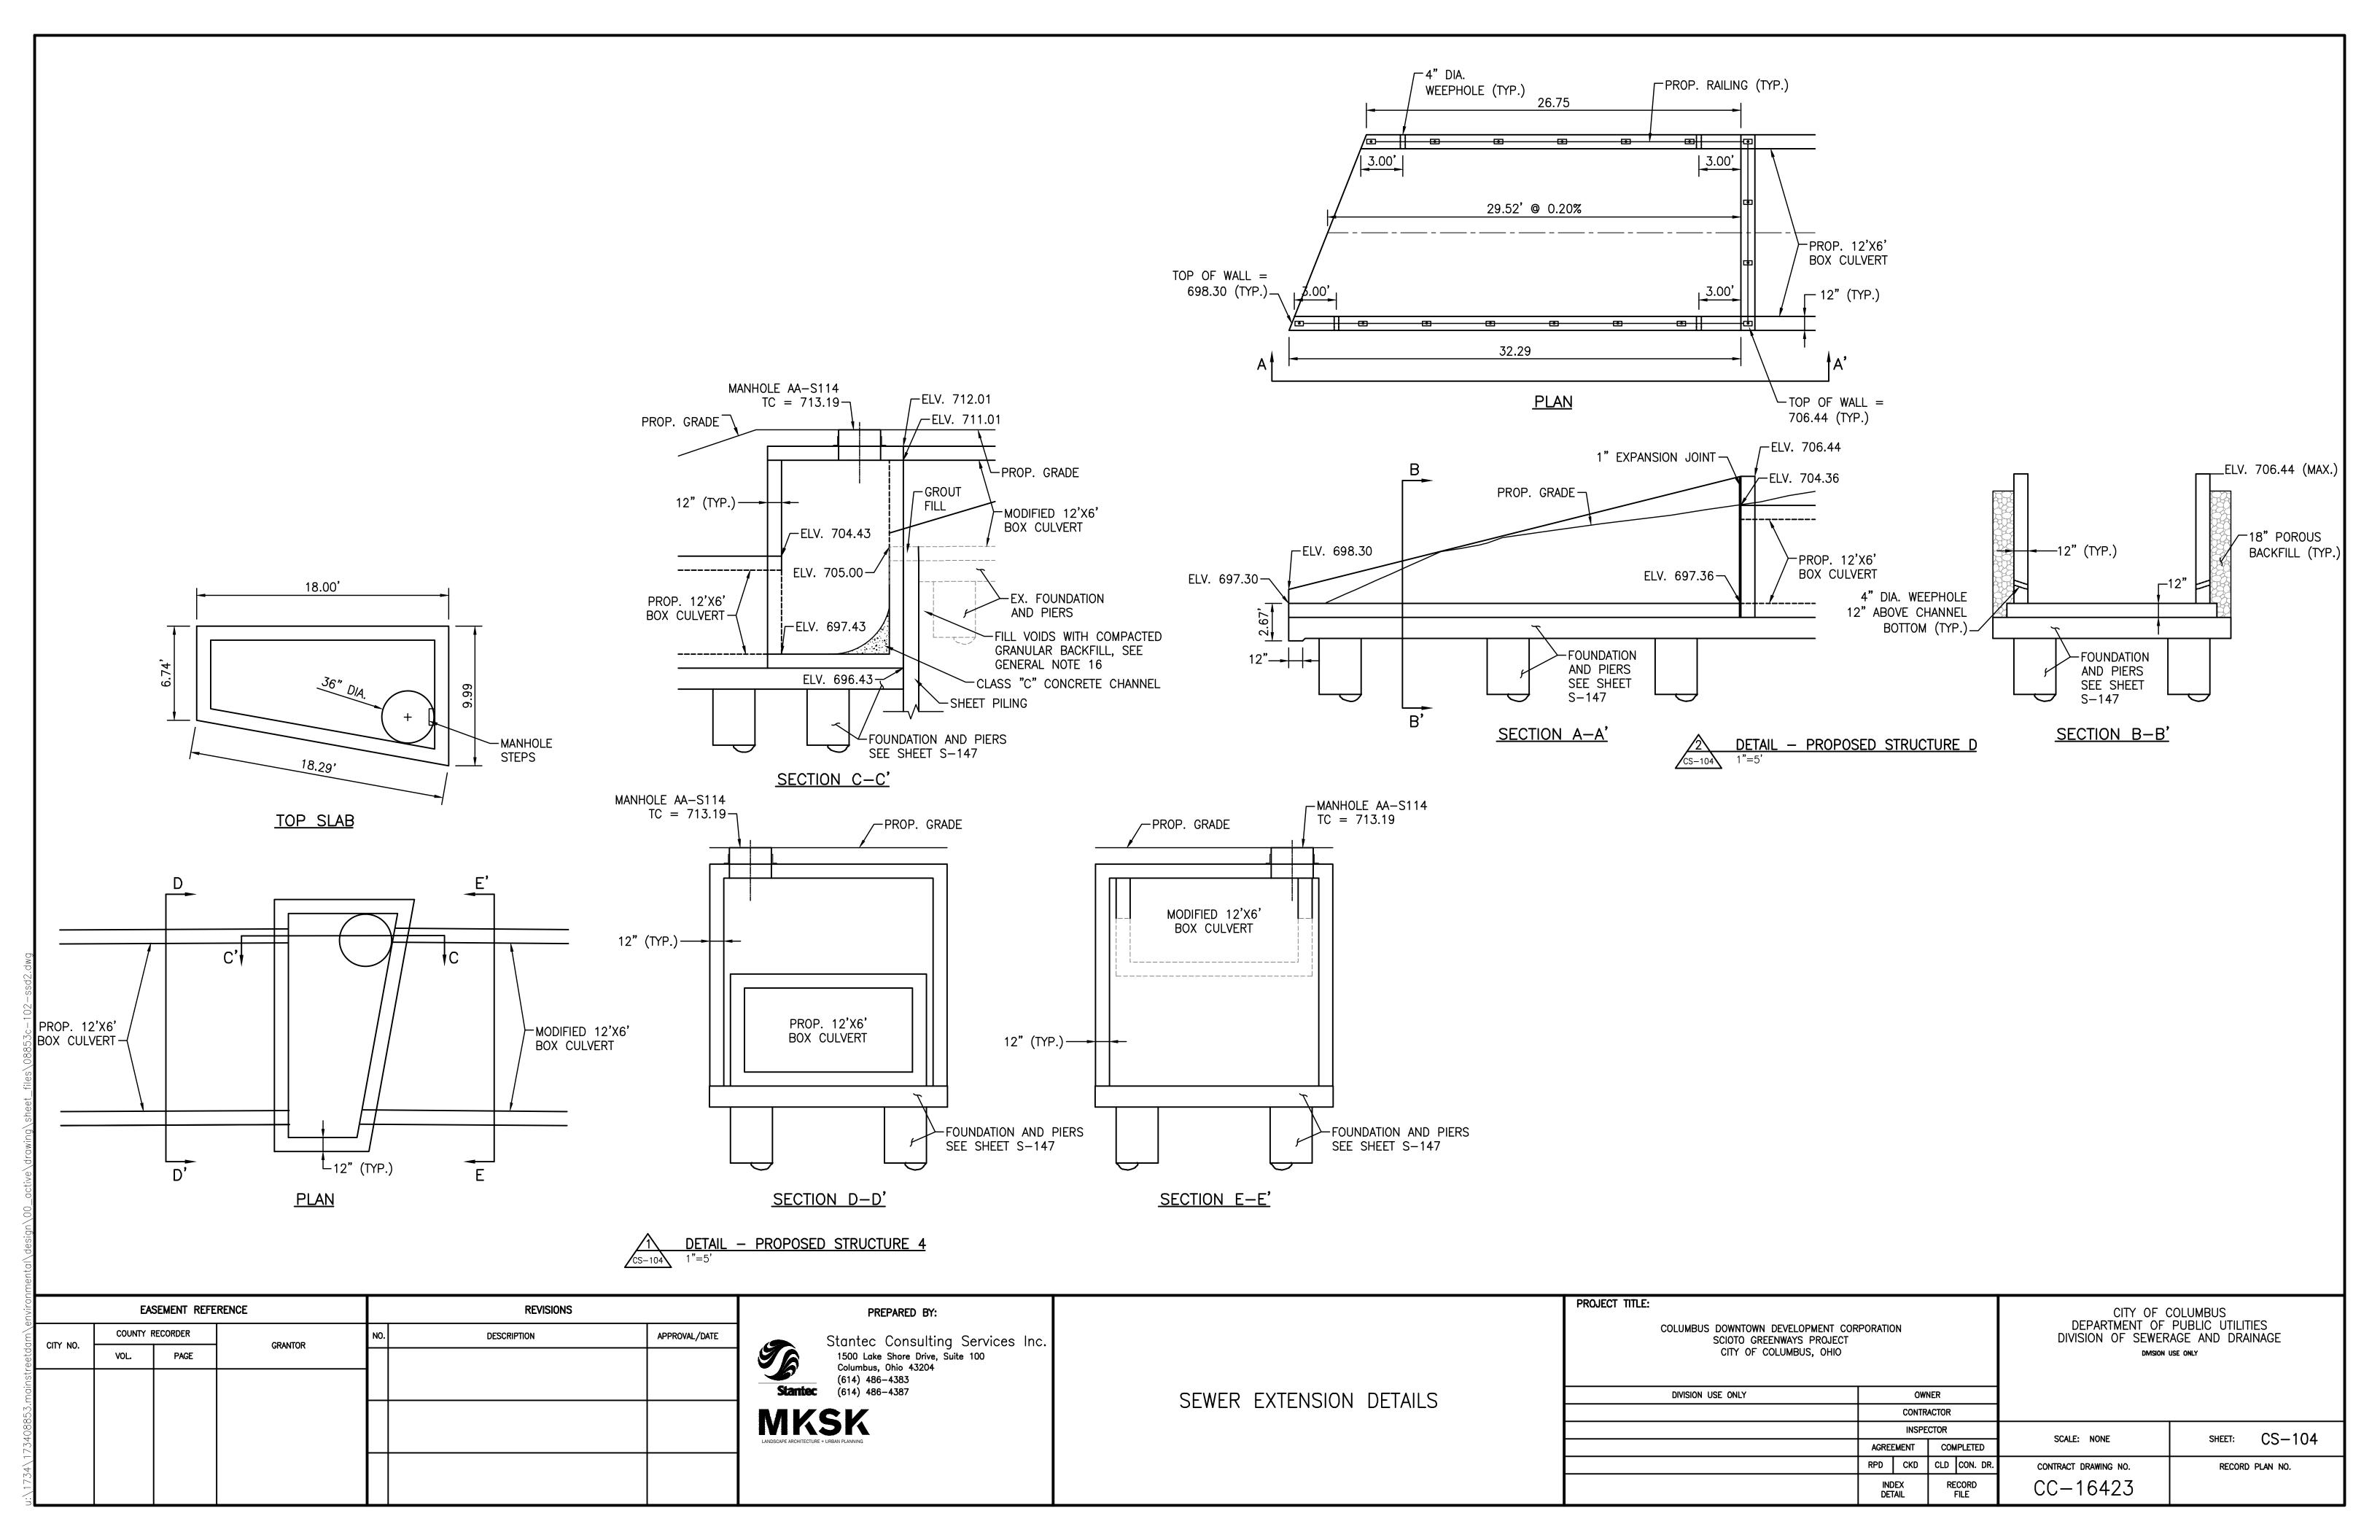

LEVEI	SPREADER	LOCATION T	ABLE
BEGIN STA.	BEGIN OFFSET	END STA.	END OFFSET
31+89.85	248.06' (R)	37+73.65	275.84' (R)
45+15.04	266.18'(R)	51+55.27	240.09' (R)

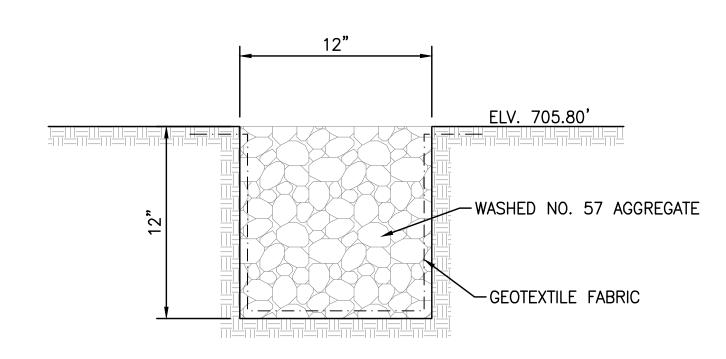

Check ✓	Inspection Frequency	Potential Problem	Preferred Maintenance Activity		
Monthly	Monthly	Flow not evenly distributed	Adjust spreader to be level and clean so that flows spread evenly over entire filter strip		
	Monthly	Invasive vegetation	Remove invasive vegetation and excess weeds as necessary		
	Monthly	Vegetation height	Mow grass to a height of 3 to 4 inches and control invasive vegetation such that flow is not impeded		
	Monthly	Erosion	Repair ruts or bare areas by adding topsoil and re-vegetating		
	Monthly	Sediment Accumulation	Remove sediment deposits that exceed 2 inches in depth and ensure flow will pass evenly through strip		
	Monthly	Trash and Debris	Remove all trash and debris		


NOTE:


1. THE VEGETATIVE FILTER STRIP AND LEVEL SPREADER, DETAIL 2/CS-105, ARE AN INTEGRAL PART OF THE STORM SEWER SYSTEM DEPICTED IN THESE DRAWINGS. RESPONSIBILITY AND ASSURANCE OF PERIODIC MAINTENANCE AND THE CONTINUOUS FUNCTIONALITY OF THIS STORMWATER QUALITY DEVICE IS PERPETUAL; BEGINNING WITH THE OWNER AT THE TIME OF INSTALLATION AND CONTINUING TO ALL FUTURE OWNERS OF SAID STORM SEWER SYSTEM. SEE SHEET CS-105 FOR POST CONSTRUCTION INSPECTION AND MAINTENANCE REQUIREMENTS.



EXCAVATION NOTE:

1. AREA BENEATH STRUCTURE 23 SHALL BE OVER-EXCAVATED TO A DENSE TO VERY-DENSE GRANULAR LAYER OCCURRING AT OR BELOW ELEVATION 695. THE OVER-EXCAVATION SHALL BE BACKFILLED WITH FREE-DRAINING COARSE AGGREGATE (SUCH AS ODOT NO. 2 STONE) TO WITHIN 6-INCHES OF THE FOUNDATION BEARING LEVEL. THE TOP 6-INCHES SHALL BE COMPRISED OF COMPACTED ITEM 304, AND PROVIDE A LEVEL BEARING SURFACE. THE OVER-EXCAVATION SHALL BE EXTENDED LATERALLY BEYOND THE LIMITS OF STRUCTURE IN ALL DIRECTIONS BY A DISTANCE NOT LESS THAN 2-FEET PLUS THE DEPTH OF OVER-EXCAVATION.

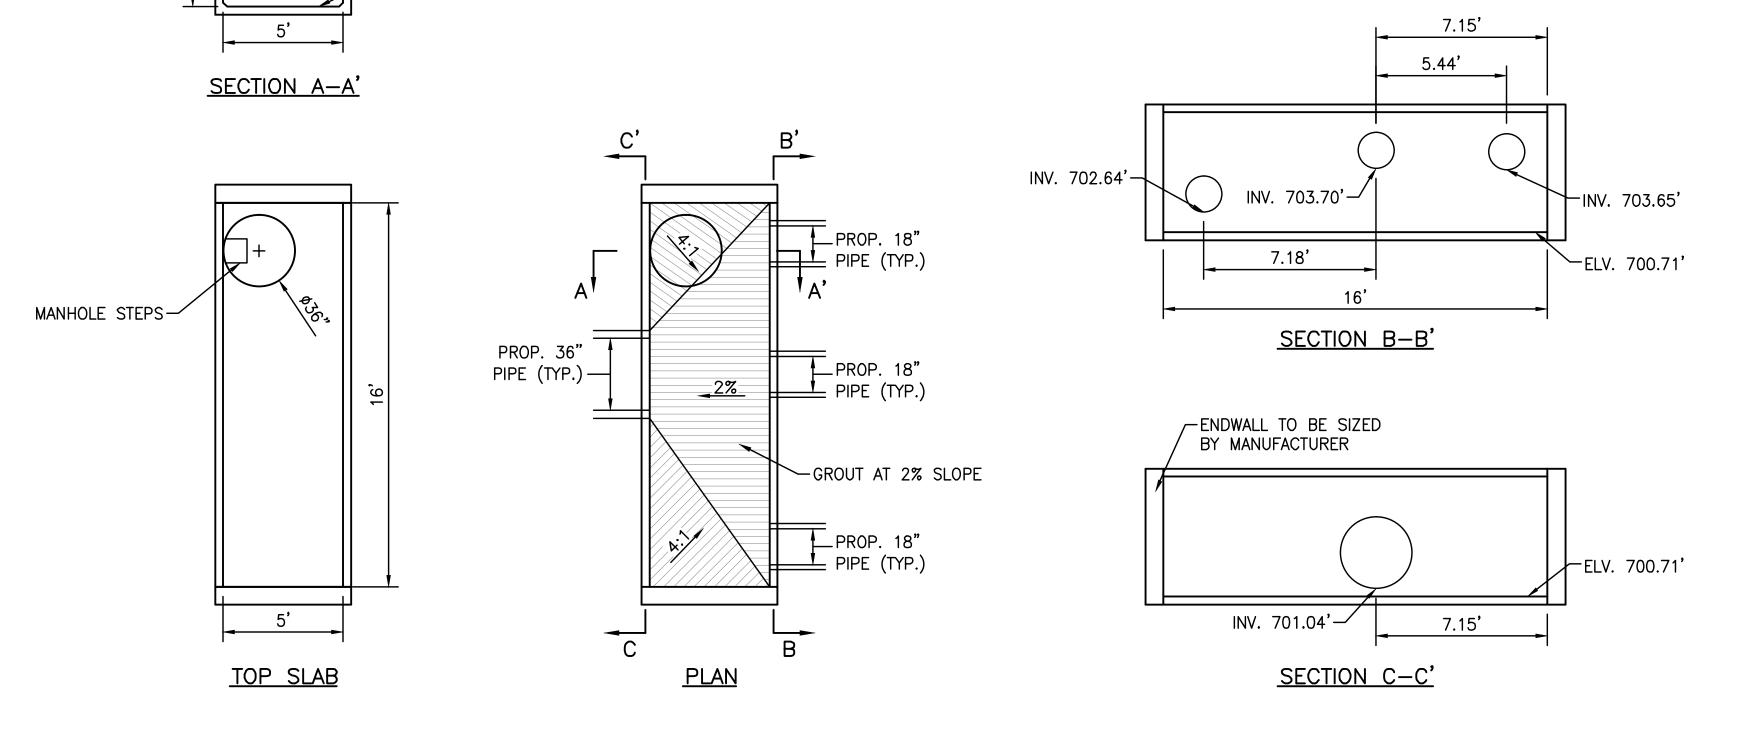

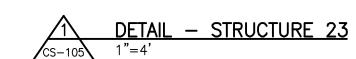

	EAS	SEMENT REFE	ERENCE	REVISIONS		PREPARED BY:		PROJECT TITLE:		CITY OF C	COLUMBUS
CITY NO.	COUNTY R	RECORDER	GRANTOR	NO. DESCRIPTION	APPROVAL/DATE	Stantec Consulting Services Inc.		COLUMBUS DOWNTOWN DEVELOPME SCIOTO GREENWAYS PR	OJECT	CITY OF C DEPARTMENT OF DIVISION OF SEWERA	AGE AND DRAINAGE
on i No.	VOL. PAGE GRANIOR		4GE			1500 Lake Shore Drive, Suite 100 Columbus, Ohio 43204		CITY OF COLUMBUS,	DHIO	DIMSION L	JSE ONLY
						(614) 486-4383					
						Stantec (614) 486–4387	SEWER EXTENSION DETAILS	DIVISION USE ONLY	OWNER		
						MKSK	OEWER EXTERIOR BETTWEE		CONTRACTOR		
									INSPECTOR	SCALE: NONE	SHEET: CS-105
						LANDSCAPE ARCHITECTURE + URBAN PLANNING			AGREEMENT COMPLETED	SCALE: NONE	SHEET: CS-105
									RPD CKD CLD CON. DR.	CONTRACT DRAWING NO.	RECORD PLAN NO.
									INDEX RECORD DETAIL FILE	CC-16423	

MANHOLE AA-S114

TC=708.50'-

PROP. GRADE


ELV. 705.71

─INV. 703.65'

ELV. 700.71

WALL THICKNESS TO BE SIZED BY MANUFACTURER

nvironmental\desian\00_active\drawina\sheet_files\08853c-103-ssd3.dwa

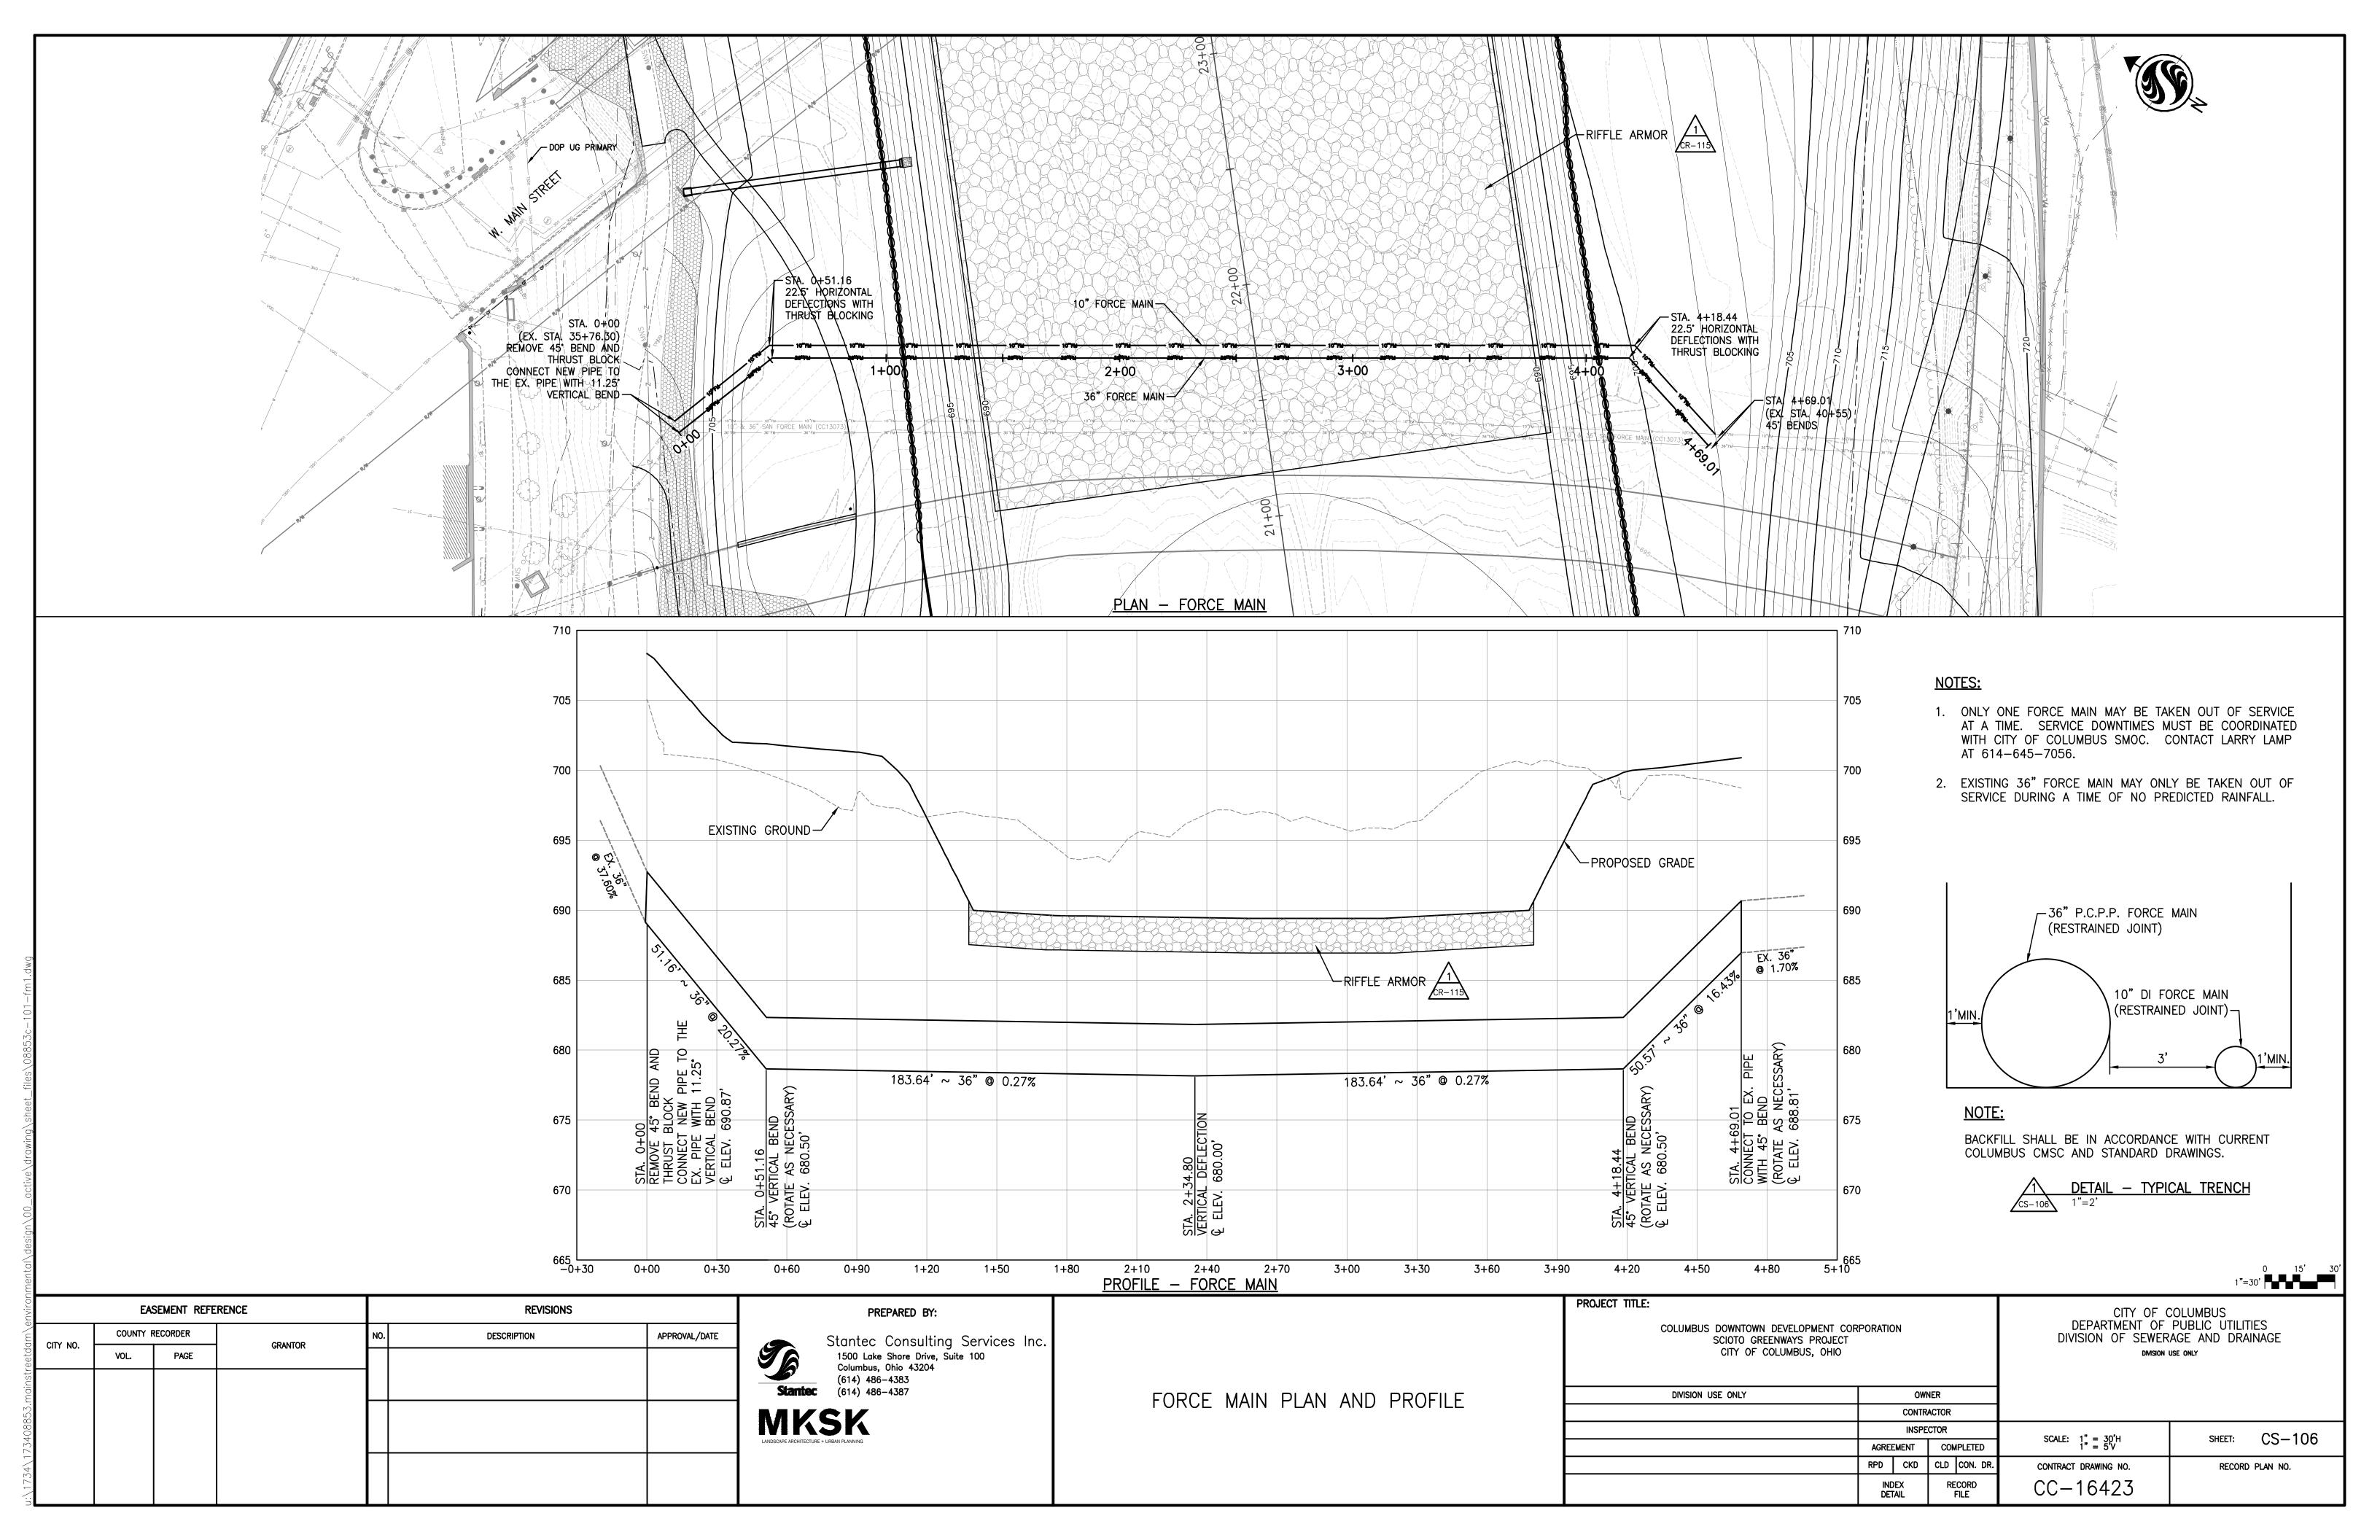

GENERAL

- 1. THE SYMBOLS, ABBREVIATIONS, AND LAP SPLICE AND EMBEDMENT TABLE ON THIS SHEET IS A COMPREHENSIVE STANDARD GUIDE FOR GENERAL USE ON ALL PROJECTS. THEREFORE NOT ALL THE SYMBOLS AND ABBREVIATIONS CONTAINED IN THIS LIST ARE NECESSARILY USED ON THIS PARTICULAR PROJECT AND SHOULD BE USED FOR CLARIFICATION ONLY.
- 2. QUALITY OF CONSTRUCTION REQUIRED, PERFORMANCE LEVELS OF WORKMANSHIP. MANUFACTURING AND INDUSTRY STANDARDS, STRENGTH AND PHYSICAL REQUIREMENTS OF MATERIALS, CONFORMANCE TO CODES AND REGULATIONS, GUARANTEES AND OTHER PROJECT REQUIREMENTS ARE SPECIFIED IN THE PROJECT
- 3. IF MATERIALS, QUANTITIES, STRENGTHS OR SIZES INDICATED BY THE DRAWINGS OR SPECIFICATIONS ARE NOT IN AGREEMENT WITH THESE NOTES, THE BETTER QUALITY AND/OR GREATER QUANTITY, STRENGTH OR SIZE INDICATED, SPECIFIED, OR NOTED SHALL BE PROVIDED.
- 4. PERFORM ALL WORK IN COORDINATION WITH ALL DRAWINGS AND INFORMATION RELATED TO STRUCTURAL WORK. ANY CHANGES TO THE EQUIPMENT REQUIRING CHANGES TO SYSTEMS SHALL BE REDESIGNED BY A PROFESSIONAL ENGINEER AT NO COST TO THE OWNER AND SUBMITTED TO THE ENGINEER. SUBMITTAL SHALL BE ACKNOWLEDGED IN WRITING BEFORE BEGINNING CONSTRUCTION.
- 5. IT IS SOLELY THE CONTRACTOR'S RESPONSIBILITY TO DETERMINE ERECTION PROCEDURE AND SEQUENCE TO ENSURE THE SAFETY OF THE STRUCTURE AND ITS COMPONENT PARTS DURING ERECTION. THIS INCLUDES, BUT IS NOT LIMITED TO, THE ADDITION OF WHATEVER TEMPORARY BRACING, GUYS OR TIE-DOWNS MAY BE NECESSARY. SUCH MATERIAL SHALL BE REMOVED AND SHALL REMAIN THE PROPERTY OF THE CONTRACTOR AFTER COMPLETION OF THE PROJECT.
- 6. STRUCTURES HAVE BEEN DESIGNED FOR DESIGN LOADS SHOWN OR SPECIFIED. THE CONTRACTOR SHALL BE RESPONSIBLE FOR STRUCTURES SUBJECT TO CONSTRUCTION LOADS EXCEEDING THE DESIGN LOADS AND SHALL NOTIFY THE ENGINEER OF ANY SUCH ADDITIONAL LOADS.
- DURING CONSTRUCTION, STRUCTURE MAY BE BUOYANT WHEN EMPTY. IN THE EVENT THAT THE EXCAVATION BECOMES FLOODED OR THE SURROUNDING GROUND BECOMES SATURATED ALL NECESSARY PRECAUTIONS SHALL BE TAKEN TO PREVENT FLOATATION OF THE STRUCTURE.
- 8. ALL DIMENSIONS AND ELEVATIONS NOTED THUS (*) ON STRUCTURES SHOWN ON THE STRUCTURAL DRAWINGS SHALL BE VERIFIED BY THE CONTRACTOR IN THE FIELD OR WITH THE EQUIPMENT MANUFACTURER AND SHALL CONFORM TO THOSE SHOWN ON OTHER DRAWINGS.
- 9. ALL LOADS SHOWN ON THE DRAWINGS ARE SERVICE LOADS AND ARE TO BE CONSIDERED MINIMUM MEMBER DESIGN FORCES.
- 10. DESIGN LOADS: BASED ON THE 2011 OHIO BUILDING CODE.

FLOOR LIVE LOADS:	SEE PLANS
ROOF LIVE LOAD:	NA
ROOF SNOW LOAD: - GROUND SNOW LOAD, Pg - FLAT-ROOF SNOW LOAD, Pf - SNOW EXPOSURE FACTOR, Ce - SNOW LOAD IMPORTANCE FACTOR, I - THERMAL FACTOR, Ct	20 PSF NA 1.0 1.0 NA
WIND LOAD: - BASIC WIND SPEED - WIND IMPORTANCE FACTOR, I - WIND EXPOSURE - INTERNAL PRESSURE COEFFICIENT: - COMPONENTS AND CLADDING	90 MPH 1.0 C NA SEE SPECIFICATIONS
EARTHQUAKE DESIGN DATA: - SEISMIC IMPORTANCE FACTOR, I - OCCUPANCY CATEGORY: - SPECTRAL RESPONSE ACCELERATIONS, Ss - SPECTRAL RESPONSE ACCRETIONS, Si - SITE CLASS - SPECTRAL RESPONSE COEFFICIENT, SDS - SPECTRAL RESPONSE COEFFICIENT, SD1 - SEISMIC DESIGN CATEGORY: - BASIC SEISMIC FORCE RESISTING SYSTEM: - DESIGN BASE SHEAR: - SEISMIC RESPONSE COEFFICIENT, Cs - RESPONSE MODIFICATION FACTOR, R - ANALYSIS PROCEDURE:	1.0 II 0.148g 0.059g D 0.158g 0.095g B A-2 0.04 X SELF WT. 0.04 4 EQUIVALENT LATERAL FORCE
FLOOD DESIGN DATA: - GROUNDWATER - 100 YEAR FLOOD ELEVATION	TOP OF GRADE SEE FIRM MAP NUMBER

SPECIAL INSPECTION

EARTH PRESSURE DESIGN DATA:

2. DREDGED FILL

1. FREE-DRAINING GRANULAR FILL

1. THE FOLLOWING ITEMS SHALL BE SUBJECTED TO SPECIAL INSPECTION AND TESTING AS OUTLINED IN THE 2011 OHIO BUILDING CODE CHAPTER 17:

130 PCF

125 PCF

- -FABRICATORS, SECTION 1704.2 -STEEL CONSTRUCTION, SECTION 1704.3
- -CONCRETE CONSTRUCTION, SECTION 1704.4
- -SOILS, SECTION 1704.7 -DRIVEN DEEP FOUNDATIONS, SECTION 1704.8
- -CAST-IN-PLACE DEEP FOUNDATIONS, SECTION 1704.9
- 2. THE SPECIAL INSPECTORS AND TESTING AGENCIES WILL BE ENGAGED BY THE OWNER OR OWNER'S AGENT, AND NOT BY THE CONTRACTOR OR SUBCONTRACTOR WHOSE WORK IS TO BE INSPECTED OR TESTED. CONFLICTS OF INTEREST MUST BE DISCLOSED TO THE BUILDING OFFICIAL PRIOR TO COMMENCING THE WORK.

- 3. THE SCOPE OF REQUIRED SPECIAL INSPECTIONS OR TEST SHALL INCLUDE ALL PROPOSED WORK SHOWN ON THE APPROVED CONSTRUCTION DOCUMENTS UNLESS
- 4. CONTRACTOR SHALL NOTIFY SPECIAL INSPECTION AGENCY SUFFICIENTLY IN ADVANCE OF THE WORK TO ALLOW COORDINATION OF PERSONNEL AT THE SITE, DO NOT COVER WORK TO BE INSPECTED UNTIL SPECIAL INSPECTION HAS BEEN COMPLETED AND RESULTS THEREOF ARE ACCEPTABLE.
- 5. SPECIAL INSPECTION DOES NOT WAIVE OR INCLUDE INSPECTIONS REQUIRED BY THE 2011 OHIO BUILDING CODE - CHAPTER 1.

FOUNDATIONS

- 1. THE CONTRACTOR SHALL BECOME FAMILIAR WITH THE SURVEY AND THE SUBSURFACE INVESTIGATION REPORT BEFORE BEGINNING CONSTRUCTION.
- 2. NOTIFY THE ENGINEER AS SOON AS POSSIBLE OF ANY UNUSUAL SOIL CONDITIONS IN VARIANCE WITH TEST BORINGS, SUCH AS UNEXPECTED SPRING OR SEEPAGE WATER, MATERIAL DIFFERING FROM TEST BORINGS, OR SOIL OF QUESTIONABLE BEARING CAPACITY.
- 3. SET FOUNDATIONS AT ELEVATIONS SHOWN. THE CONTRACTOR SHALL VERIFY WITH THE ENGINEER THAT EACH FOOTING PLACED IS BEARING ON DESIGN MATERIAL.
- 4. SITE GEOTECHNICAL INVESTIGATION AND FOUNDATION RECOMMENDATIONS; REPORT OF GEOTECHNICAL EXPLORATION SCIOTO GREENWAYS MAIN STREET DAM REMOVAL FRANKLIN COUNTY, OHIO BY STANTEC DATED: 12.14.12. AMENDED: 07.24.13 INCLUDING ALL SUBSEQUENT AMENDED DESIGN MEMOS.
- 5. ALLOWABLE SOIL BEARING PRESSURE: SEE PLANS.
- 6. FOOTINGS SHALL REST ON AGGREGATE BASE, DRILLED SHAFTS, OR AUGER CAST
- 7. LEVELS OF BACKFILL AGAINST CONCRETE WALLS SHALL NOT DIFFER MORE THAN 2'-0" ON EITHER SIDE OF WALLS UNLESS ADEQUATELY BRACED OR ALL FLOOR FRAMING IS IN PLACE UP TO AND INCLUDING GRADE LEVEL SLABS.
- 8. PROTECT EXCAVATION FROM FLOODING UNTIL ALL WALLS AND FLOOR FRAMING UP TO AND INCLUDING GRADE LEVEL FLOORS ARE IN PLACE AND BACKFILLING HAS BEGUN. WATER LEVEL SHALL BE MAINTAINED BELOW EXCAVATION AT ALL TIMES.

CAST-IN-PLACE CONCRETE

- CONCRETE SHALL HAVE THE FOLLOWING MINIMUM COMPRESSIVE STRENGTH AT 28
- A. CLASS "A", 4,500 POUNDS PER SQUARE INCH (PSI) WITH ENTRAINED AIR FOR ALL CONCRETE UNLESS SPECIFICALLY NOTED OTHERWISE.
- 2. ALL CONCRETE WORK NOT COVERED UNDER ACI 350 SHALL BE IN ACCORDANCE WITH "THE BUILDING CODE REQUIREMENTS FOR STRUCTURAL CONCRETE" ACI 318. TOLERANCES SHALL BE IN ACCORDANCE WITH ACI 347, SECTION 3.3.1, TOLERANCES FOR REINFORCED CONCRETE BUILDINGS.
- 3. ALL REINFORCING STEEL SHALL BE NEW (NON-EPOXY COATED) DOMESTIC DEFORMED BILLET STEEL CONFORMING TO ASTM A615 GRADE 60.
- 4. ALL BEAMS, SPANDRELS AND SLABS SHALL BE CAST MONOLITHICALLY, EXCEPT FOR REQUIRED CONSTRUCTION JOINTS. CONTRACTOR SHALL SUBMIT ANY AND ALL ALTERNATE AND ADDITIONAL CONSTRUCTION JOINT LOCATIONS AND DETAILS.
- 5. CONSTRUCTION JOINTS REQUIRED BY THE ENGINEER ARE SHOWN ON THE DRAWINGS. ADDITIONAL CONSTRUCTION JOINTS SHALL BE PROVIDED AS OUTLINED IN SPECIFICATIONS. REINFORCEMENT SHALL BE CONTINUOUS ACROSS CONSTRUCTION JOINTS. SUBMIT ALL CONSTRUCTION JOINT LOCATIONS WITH REINFORCING STEEL SHOP DRAWINGS.
- 6. CONTRACTOR SHALL PROVIDE 3/4 INCH CHAMFER (UON) USING WOOD CHAMFER STRIPS ON ALL EXPOSED CORNERS OF COLUMNS, BEAMS AND WALLS, OR AS REQUIRED TO MATCH EXISTING.
- 7. COVER FOR REINFORCING STEEL SHALL CONFORM TO THE FOLLOWING (UON):


TYPICAL REINFORCING BAR COVER TABLE

THIOAL INLINIONOMO DAIL GOVER MADEL		
CONCRETE CAST AGAINST EARTH	3"	
REINFORCING TO CLEAR WATERSTOP.	.3"	
SURFACES EXPOSED TO LIQUIDS, EARTH OR WEATHER	2"	
BEAM STIRRUPS (BOTTOM, SIDES, TOP) (UON)		
BEAM STIRRUPS (TOP) FOR BEAMS PARALLEL TO		
UPPER MOST LAYER OF SLAB REINFORCEMENT	3"	
COLUMN TIES	2"	
ALL OTHER SURFACES.		

- 8. WELDING OF REINFORCING STEEL IS NOT PERMITTED.
- CALCIUM CHLORIDE SHALL NOT BE PERMITTED NOR SHALL ANY ADMIXTURE CONTAINING CALCIUM CHLORIDE BE PERMITTED THAT RESULTS IN A TOTAL CONCRETE MIX IN WHICH THE PRESENCE OF CHLORIDE IONS EXCEED 0.15 PERCENT BY WEIGHT OF CEMENT.
- 10. ALUMINUM PIPE SHALL NOT BE USED WITH CONCRETE PUMPS.
- 11. AS A MINIMUM, PROVIDE 6x6-W2.9xW2.9 WELDED WIRE REINFORCEMENT IN ALL SLABS ON GRADE, UNLESS OTHERWISE NOTED.

STRUCTURAL STEEL

- 1. STRUCTURAL STEEL SHALL CONFORM TO "SPECIFICATIONS FOR STRUCTURAL STEEL BUILDINGS" ACI 360 LATEST EDITION.
- 2. STRUCTURAL STEEL: W-SHAPES AND WT-SHAPE. .ASTM A992 CHANNELS. .ASTM A572 GRADE 50 ..ASTM A500 GRADE B TUBE SECTIONS. ANGLES, PLATES AND BARS...
- 3. BOLTS AND BOLTED CONNECTIONS SHALL CONFORM TO THE REQUIREMENTS OF THE "SPECIFICATION FOR STRUCTURAL JOINTS USING HIGH-STRENGTH BOLTS" AS APPROVED BY THE RESEARCH COUNCIL ON STRUCTURAL CONNECTIONS.
- 4. WELDED CONNECTIONS SHALL CONFORM TO THE LATEST REVISED CODE THE AMERICAN WELDING SOCIETY, AWS D1.
- WELDING ELECTRODES SHALL BE E-70XX. FOR WELDING SYMBOLS WITH NO LENGTH DIMENSION GIVEN, THE WELDING SHALL BE CONTINUOUS BETWEEN ABRUPT CHANGES IN DIRECTION. NO INTERMEDIATE WELDS SHALL BE PERMITTED, UNLESS OTHERWISE NOTED. WELDS NOT OTHERWISE NOTED SHALL BE MINIMUM 3/8" IN SIZE.
- 6. FIELD CONNECTIONS. UNLESS OTHERWISE SHOWN OR INDICATED, SHALL BE MADE WITH HIGH-STRENGTH BOLTS, AND SHALL BE BEARING-TYPE CONNECTIONS.
- 7. SHOP CONNECTIONS, UNLESS OTHERWISE SHOWN OR INDICATED, MAY BE WELDED OR HIGH-STRENGTH BOLT BEARING-TYPE CONNECTIONS. CONNECTIONS TO BE DESIGNED BY THE FABRICATOR ARE TO DEVELOP THE MINIMUM LISTED FORCES SHOWN ON THE DRAWINGS BUT NOT LESS THAN 75 PERCENT OF THE MEMBER TENSILE STRENGTH.
- 8. THE GRAVITY AXIS OF BRACING MEMBERS SHALL INTERSECT AT THE WORK POINT OF THE GRAVITY AXIS OF THE MAIN MEMBERS.

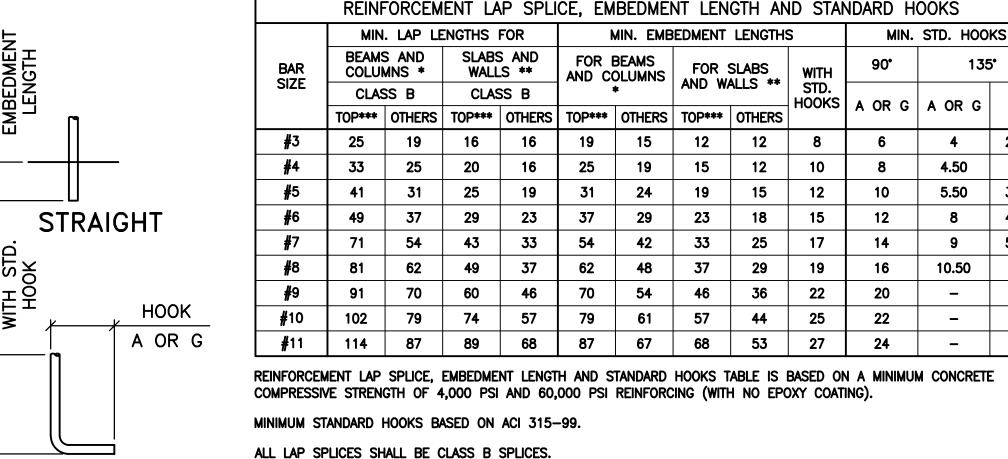

REINFORCEMENT LAP SPLICE, EMBEDMENT LENGTH AND STANDARD HOOKS TABLE IS BASED ON A MINIMUM CONCRETE

135°

4

4.50

5.50

8

9

10.50

2.50

3.75

4.50

5.25

90° HOOK

ပ

135°


\$ 8

- * THE MINIMUM LAP LENGTH FOR BEAMS, COLUMNS AND STRAIGHT EMBEDMENTS ARE BASED ON A 3 BAR DIAMETER MINIMUM CENTER TO CENTER BAR SPACING AND A 2 INCH BAR COVER. IF THE SPLICE AND/OR EMBEDMENT DOES NOT CONFORM TO THESE REQUIREMENTS THEN THE CONTRACTOR SHALL APPLY APPROPRIATE FACTORS IN COMPLIANCE WITH ACI 318 WITH APPROVAL BY ENGINEER.
- ** THE MINIMUM LAP LENGTH FOR SLABS, WALLS, AND STRAIGHT EMBEDMENTS ARE BASED ON A 6 INCH BAR SPACING AND A 2 INCH BAR COVER. IF THE LAP CONDITION DOES NOT CONFORM TO THESE REQUIREMENTS, THEN USE BEAM LAP LENGTHS: OR COMPLY WITH LAP REQUIREMENTS OF ACI 318 WITH APPROVAL BY ENGINEER.
- *** TOP BARS ARE DEFINED AS ALL HORIZONTAL BARS, EXCLUDING WALL BARS, WITH 12" OR MORE FRESH CONCRETE BENEATH.

WHERE SPLICES ARE REQUIRED BETWEEN BARS OF DIFFERENT SIZES, THE LAP LENGTH SHALL BE NO LESS THAN THE EMBEDMENT LENGTH OF THE LARGER BAR OR THE LAP LENGTH OF THE SMALLER BAR, WHICHEVER IS GREATER.

IN CIRCULAR TANKS DESIGNED FOR RING TENSION, THE LOCATION OF SPLICES SHOULD BE STAGGERED. ADJACENT HOOP REINFORCING SPLICES SHOULD BE STAGGERED HORIZONTALLY (CENTER OF LAP BY NOT LESS THAN ONE LAP LENGTH NOR 3 FEET AND SHOULD NOT COINCIDE IN VERTICAL ARRAYS MORE FREQUENTLY THAN EVERY THIRD BAR.

LAP SPLICE AND EMBEDMENT LENGTH TABLE

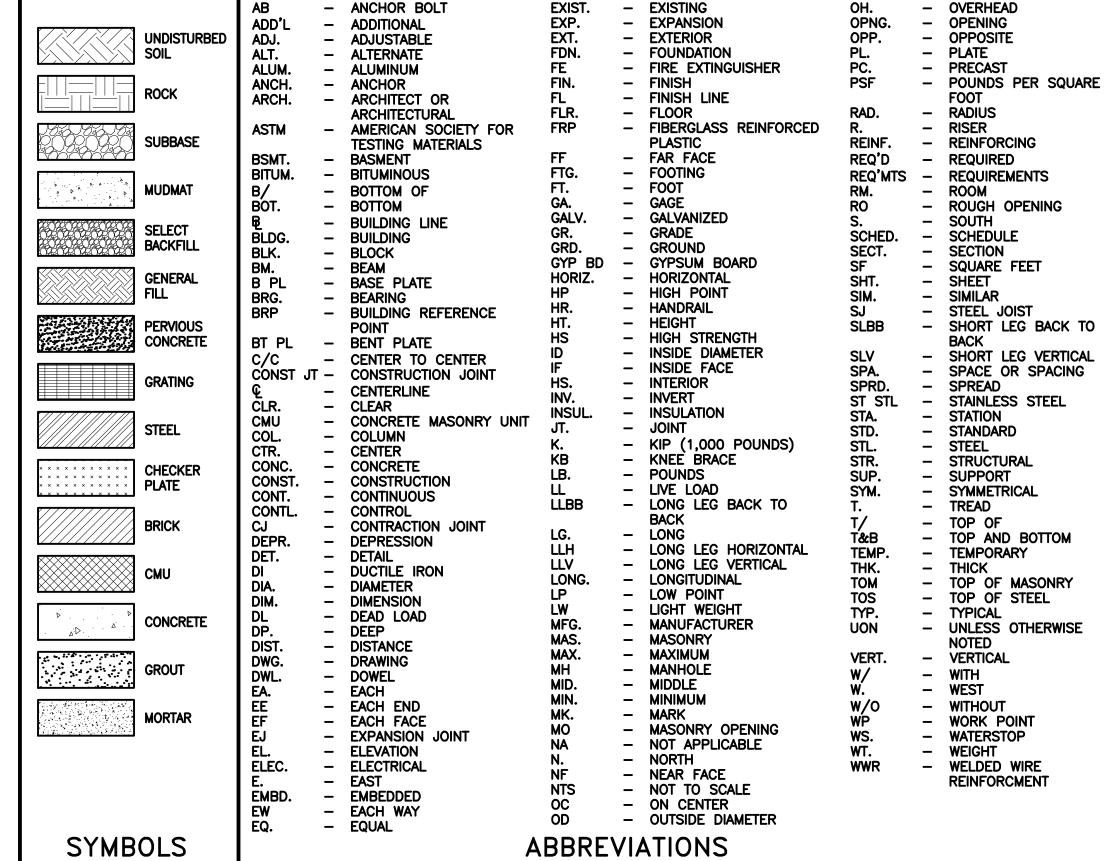

EASEMENT REFERENCE					REVISIONS			
CITY NO.	COUNTY RECORDER		CRANTOR	NO.	DESCRIPTION	APPROVAL/DATE		
CIT NO.	VOL.	PAGE	GRANTOR .					


39049C0309K

UNIT WEIGHT FRICTION ANGLE, Ø

PREPARED BY: Stantec Consulting Services Inc 1500 Lake Shore Drive, Suite 100 Columbus, Ohio 43204 (614) 486-4383 (614) 486-4387

STRUCTURAL GENERAL NOTES

21MBOF2		AB	BREVIAI	IONS			
PROJECT TITLE:	COLUMBUS DOWNTOWN DEVELOPMENT COI SCIOTO GREENWAYS PROJECT CITY OF COLUMBUS, OHIO	RPORATION		CITY OF COLUMBUS DEPARTMENT OF PUBLIC UTILITI DIVISION OF SEWERAGE AND DRAII DIVISION USE ONLY			
	DIVISION USE ONLY	0	WNER				
		CON	RACTOR				
		INSI	PECTOR	SCALE: NTS	SHEET: S-101		
		AGREEMENT	COMPLETED	SUALL. INIS	3-101		
		RPD CKD	CLD CON. DR.	CONTRACT DRAWING NO.	RECORD PLAN NO.		
		INDEX DETAIL	RECORD FILE	CC-16423			

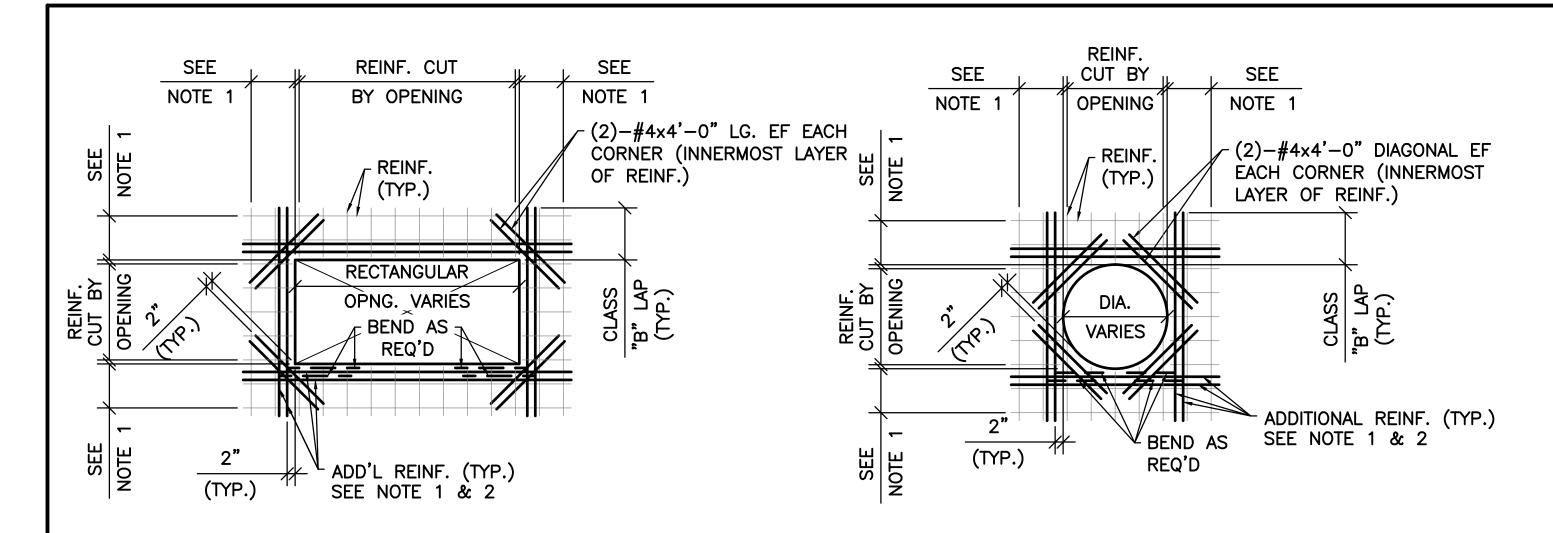


RECTANGULAR CIRCULAR

TYPICAL REINFORCING AROUND OPENING IN WALL AND SLAB

NOTES:


- 1. PROVIDE ADDITIONAL REINFORCING AT ALL OPENINGS, ACCESS HATCHES, PIPE PENETRATIONS, ETC. EQUAL IN AREA TO HALF THE TYPICAL REINFORCING CUT BY OPENING IN EACH DIRECTION. ADDITIONAL REINFORCING TO MATCH SIZE OF TYPICAL REINFORCING (MINIMUM 2 BARS EF) AND PLACED BETWEEN TYPICAL REINFORCING ON EACH SIDE OF OPENING.
- 2. PROVIDE MATCHING DOWELS WHERE REQUIRED TO PROVIDE CLASS "B" LAP WITH ADDITIONAL REINFORCING.
- 3. APPLIES TO ALL OPENINGS UNLESS OTHERWISE SHOWN ON DRAWINGS.

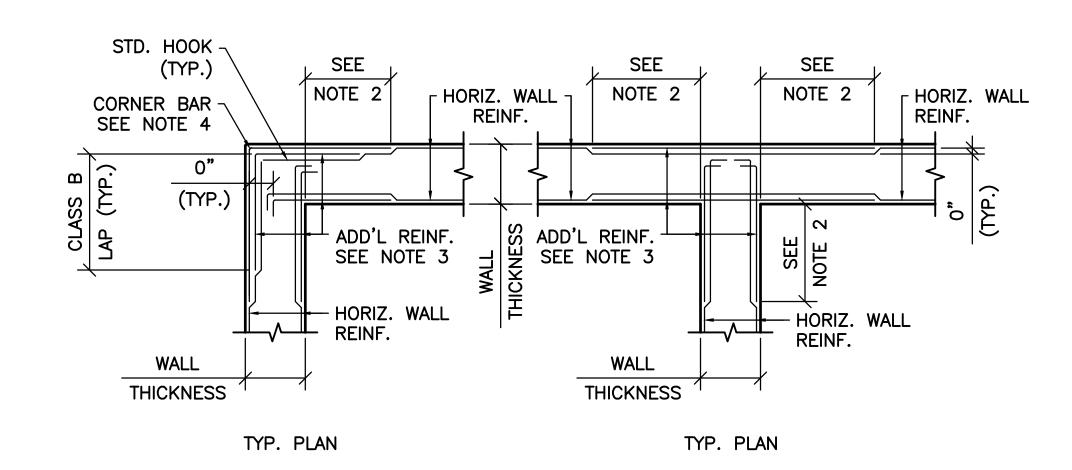

TYPICAL REINFORCING DETAIL AT WALL INTERSECTIONS

NOTES:

- 1. PROVIDE ADDITIONAL REINFORCING AT ALL WALL INTERSECTIONS AS SHOWN ABOVE UON ON DWGS.
- 2. DIMENSION TO BE 0.25 TIMES THE CLEAR SPAN DISTANCE BETWEEN WALL INTERSECTIONS MEASURED HORIZONTALLY, BUT NOT LESS THAN 2'-0", NOR GREATER THAN 6'-0".
- 3. ADDITIONAL REINFORCEMENT TO MATCH SIZE AND SPACING OF WALL HORIZONTAL REINFORCEMENT (UON). ALTERNATE ADDITIONAL REINFORCEMENT WITH HORIZONTAL WALL REINFORCEMENT.
- 4. PROVIDE CORNER BAR REINFORCING AT ALL WALL CORNERS AS SHOWN. CORNER BAR REINFORCEMENT TO MATCH SIZE AND SPACING OF WALL HORIZONTAL REINFORCEMENT.
- 5. WHERE LAPPING OF ADDITIONAL REINFORCEMENT FROM ADJACENT WALL INTERSECTION OCCURS, REINFORCEMENT SHALL BE COMBINED.
- 6. TYPICAL WALL INTERSECTION DETAILS ARE SHOWN AT 90 DEGREES, BUT ARE APPLICABLE FROM 60 TO 120 DEGREES.

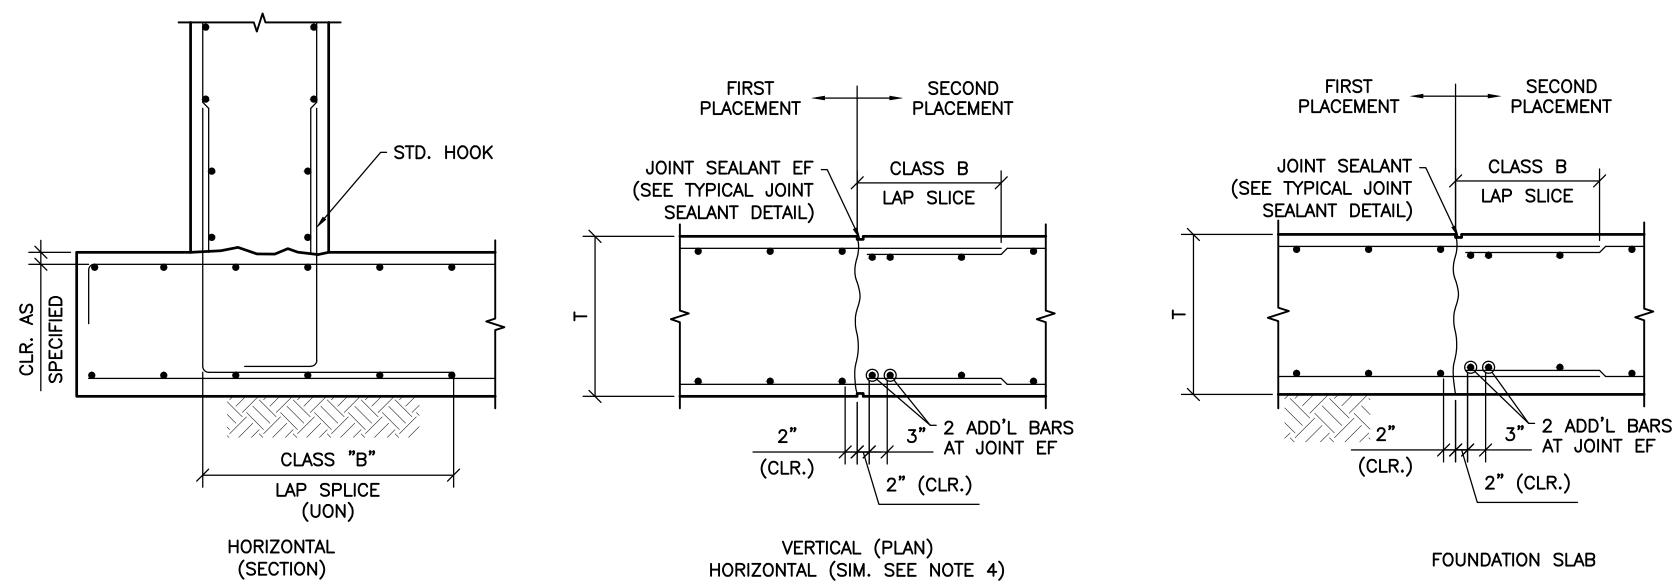


TYPICAL CONSTRUCTION JOINT DETAILS


NOTES:

- 1. CONTINUE ALL REINFORCEMENT BARS THRU JOINTS.
- 2. ROUGHEN CONST JT AS SPECIFIED.
- 3. 2 ADDITIONAL BARS TO MATCH SIZE OF PARALLEL REINFORCEMENT.

					4. NO REGLETS AND SEA	LANTS FOR HO	DRIZONTAL CONST JT.						
EASEMENT REFERENCE			ERENCE	REVISIONS			PREPARED BY:		PROJECT TITLE:		CITY OF COLUMBUS DEPARTMENT OF PUBLIC UTILITIES		
CITY NO.	COUNTY RECORDER OF THE PAGE O		NO. DESCRIPTION APPROVAL/DATE		APPROVAL/DATE	Stantec Consulting Services Inc.		COLUMBUS DOWNTOWN DEVELOPM SCIOTO GREENWAYS PR		DEPARTMENT OF PUBLIC UTILITIES DIVISION OF SEWERAGE AND DRAINAGE			
CITT NO.			GIVANTOR				1500 Lake Shore Drive, Suite 100 Columbus, Ohio 43204 (614) 486–4383 Stantec (614) 486–4387		CITY OF COLUMBUS,	OHIO	DIMISION USE O	DNLY	
							(614) 486–4383						
							Stantec (614) 486–4387	STRUCTURAL TYPICAL DETAILS 1	DIVISION USE ONLY	OWNER			
							MKSK	STITES TO THE STITE OF THE STITES TO		CONTRACTOR			
										INSPECTOR	SCALE: NTS	SHEET: S-102	
		LANDSCAPE ARCHITECTURE + URBAN PLANNING				AGREEMENT COMPLETED	SUALE. INTS	3-102					
										RPD CKD CLD CON. DR.	CONTRACT DRAWING NO.	RECORD PLAN NO.	
										INDEX RECORD DETAIL FILE	CC-16423		

\final design\drawing\s−102.dwg

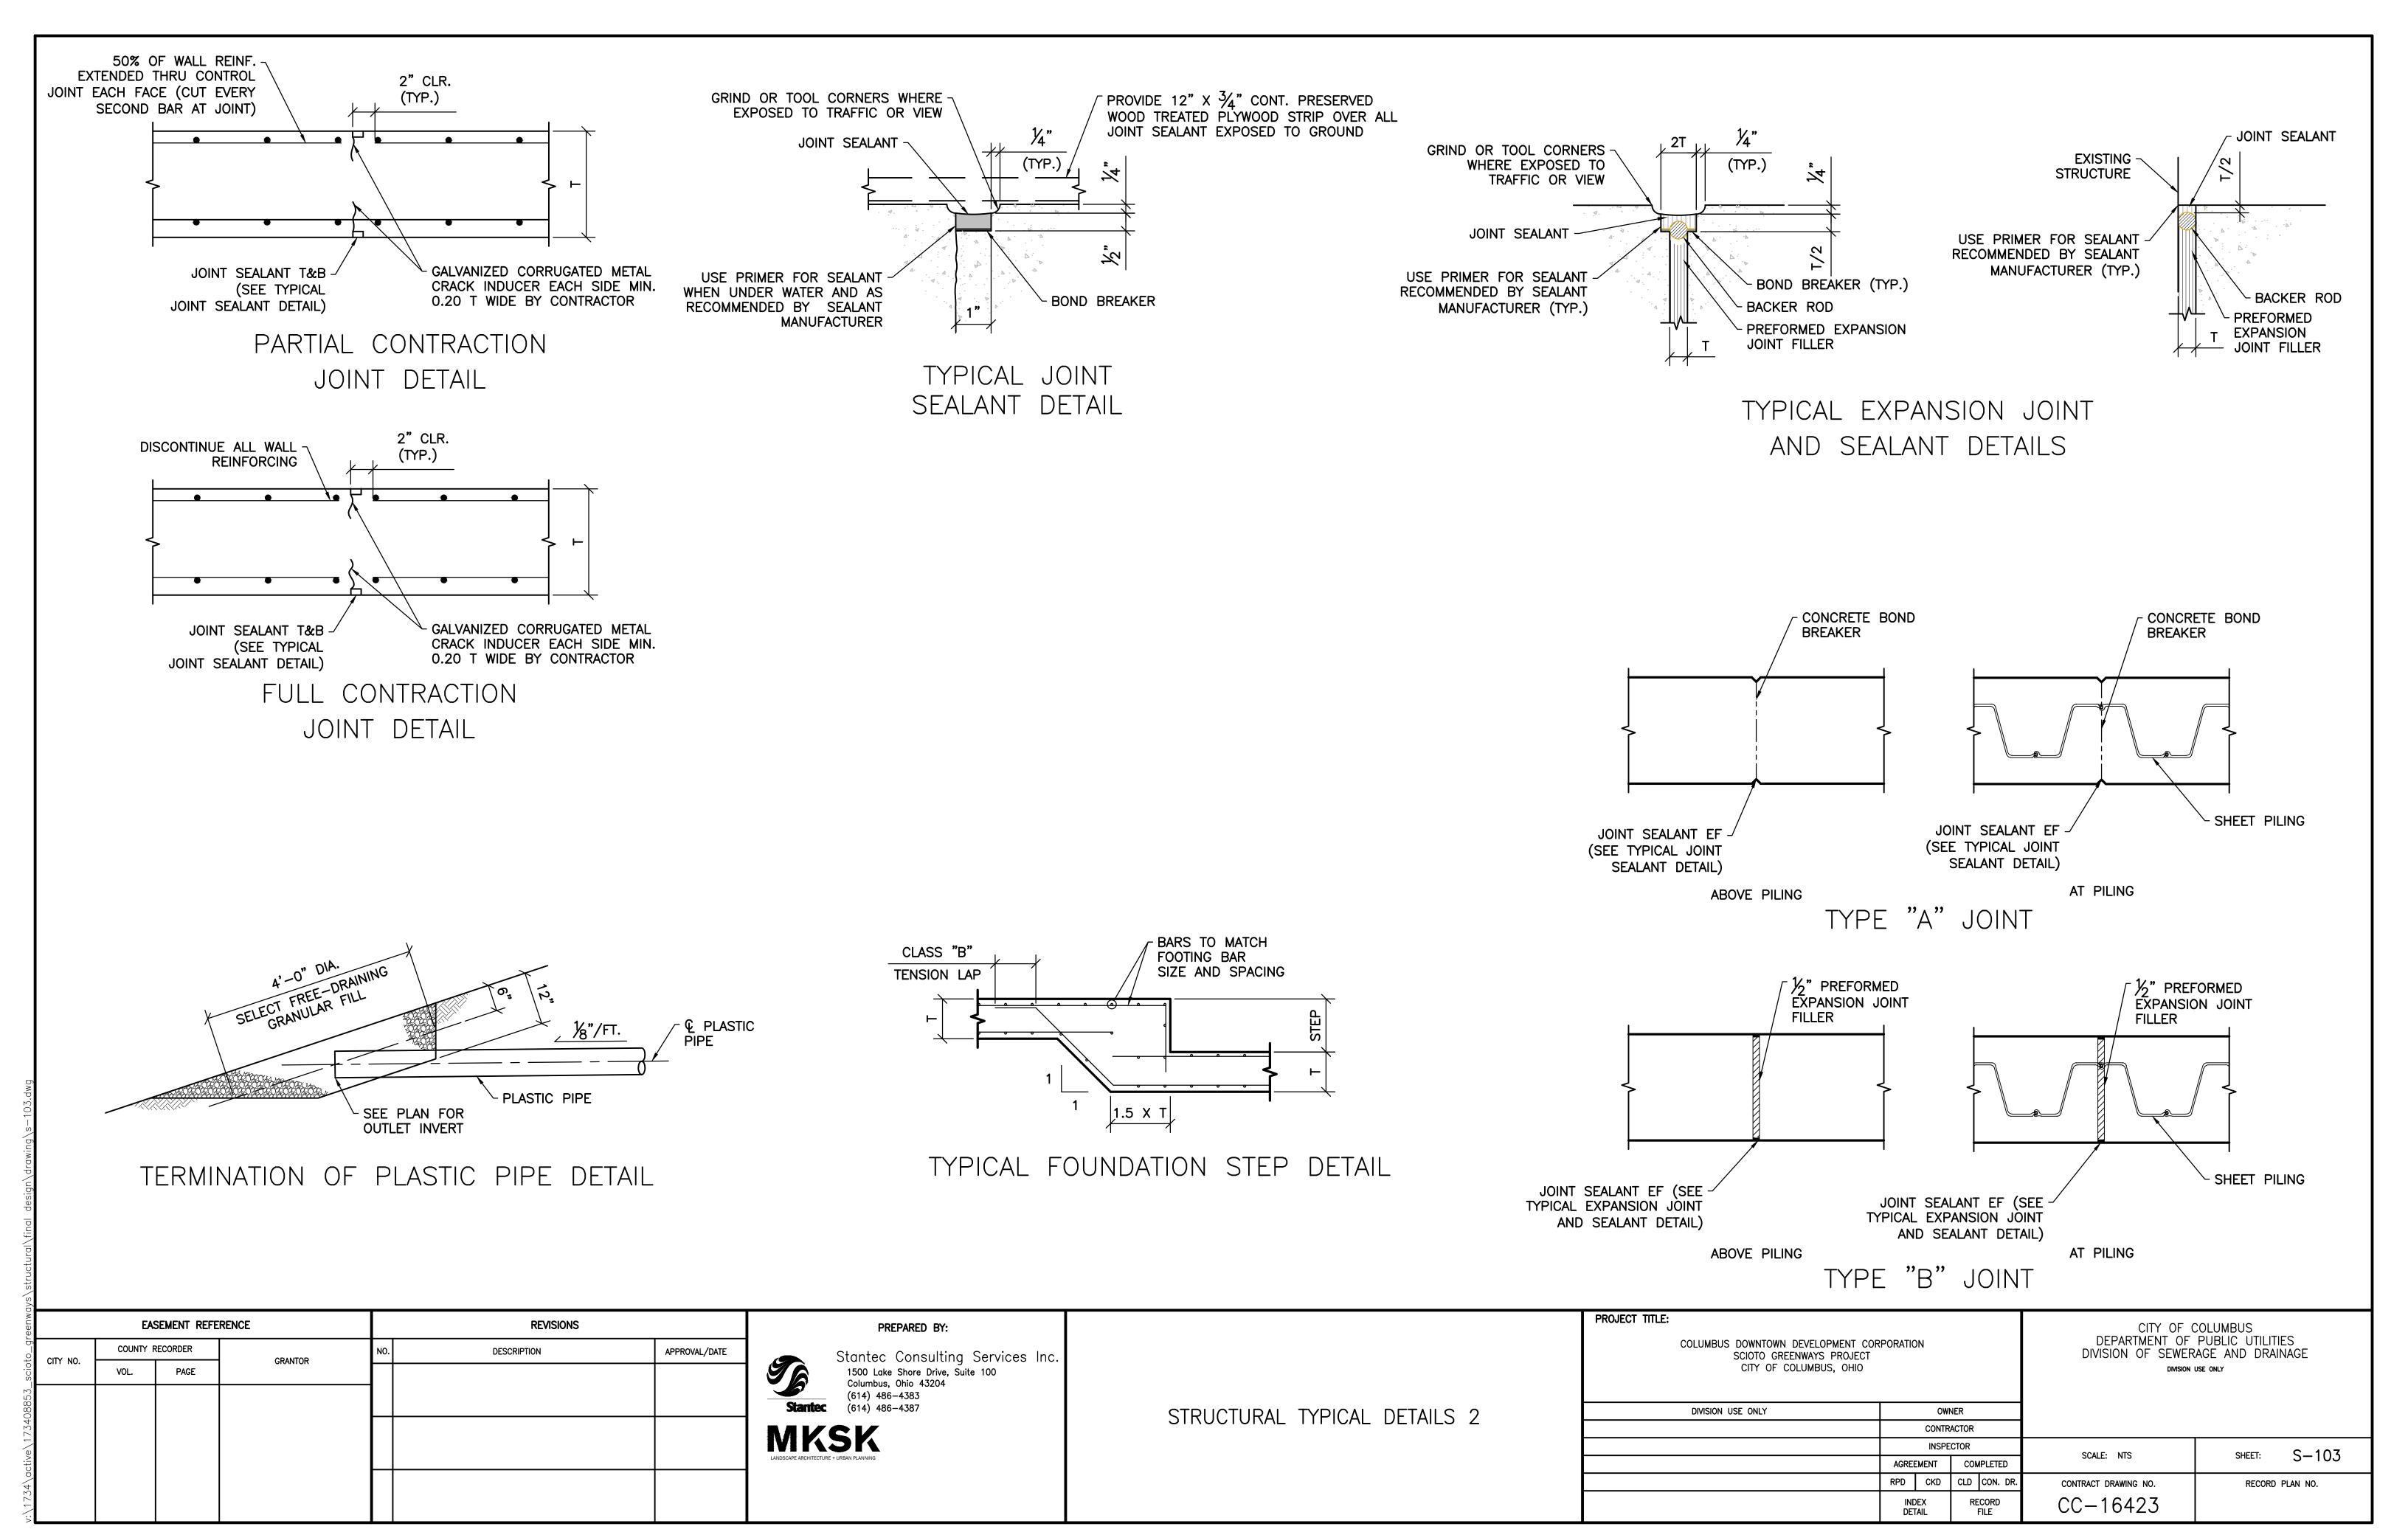


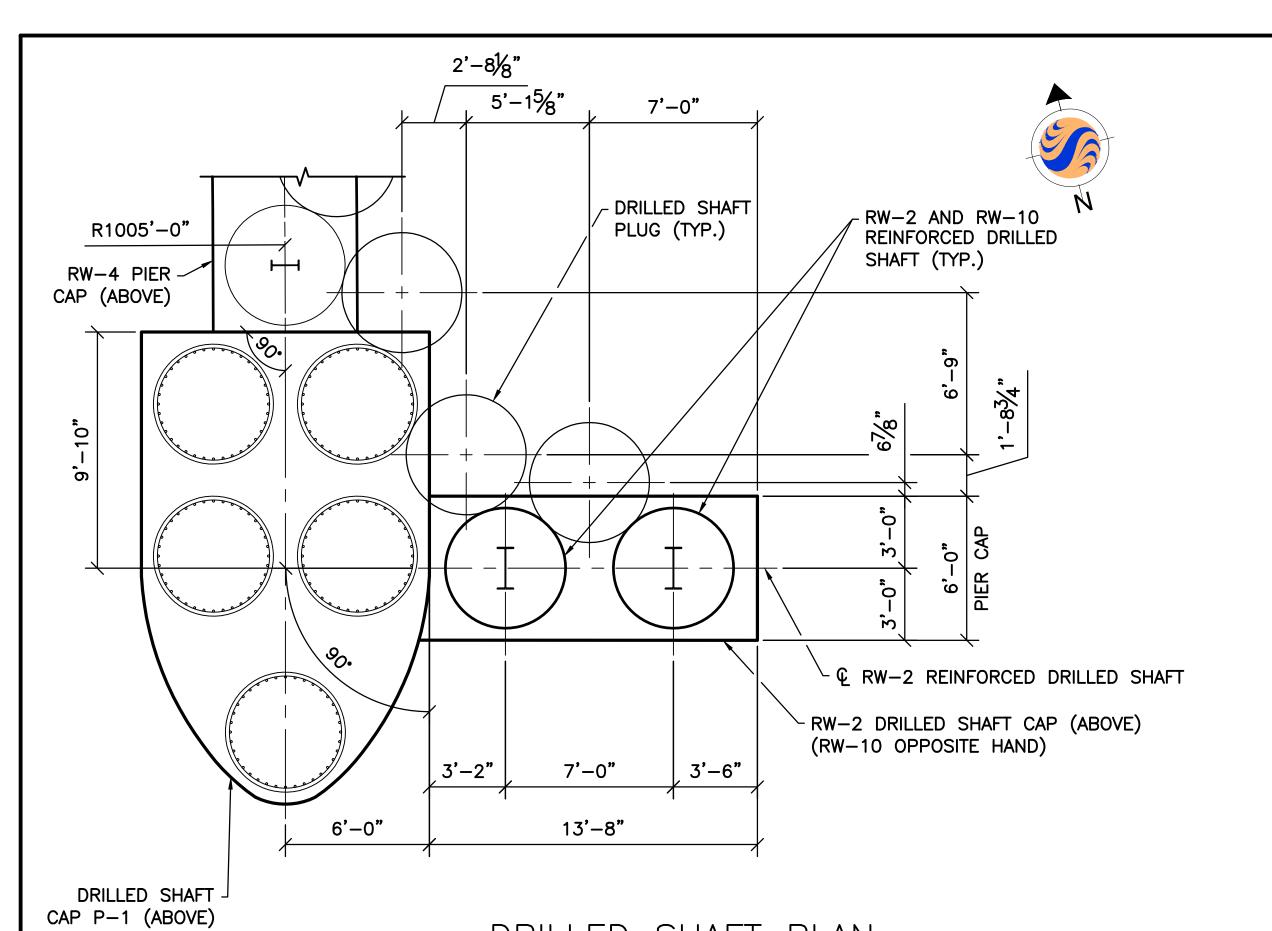


DRILLED SHAFT PLAN

NOTES:

- 1. ALL DRILLED SHAFTS TO BE 5'-0" DIA. DRILLED SHAFTS.
- 2. MAX ALLOWABLE LATERAL CAPACITY OF RW-2 AND RW-10 REINFORCED DRILLED SHAFT = 28 TONS.
- 3. MAX ALLOWABLE VERTICAL CAPACITY OF REINFORCED DRILLED SHAFT = 153 TONS.
- 4. SEE RW-4 DRILLED SHAFT PLAN FOR DRILLED SHAFT NUMBERING.

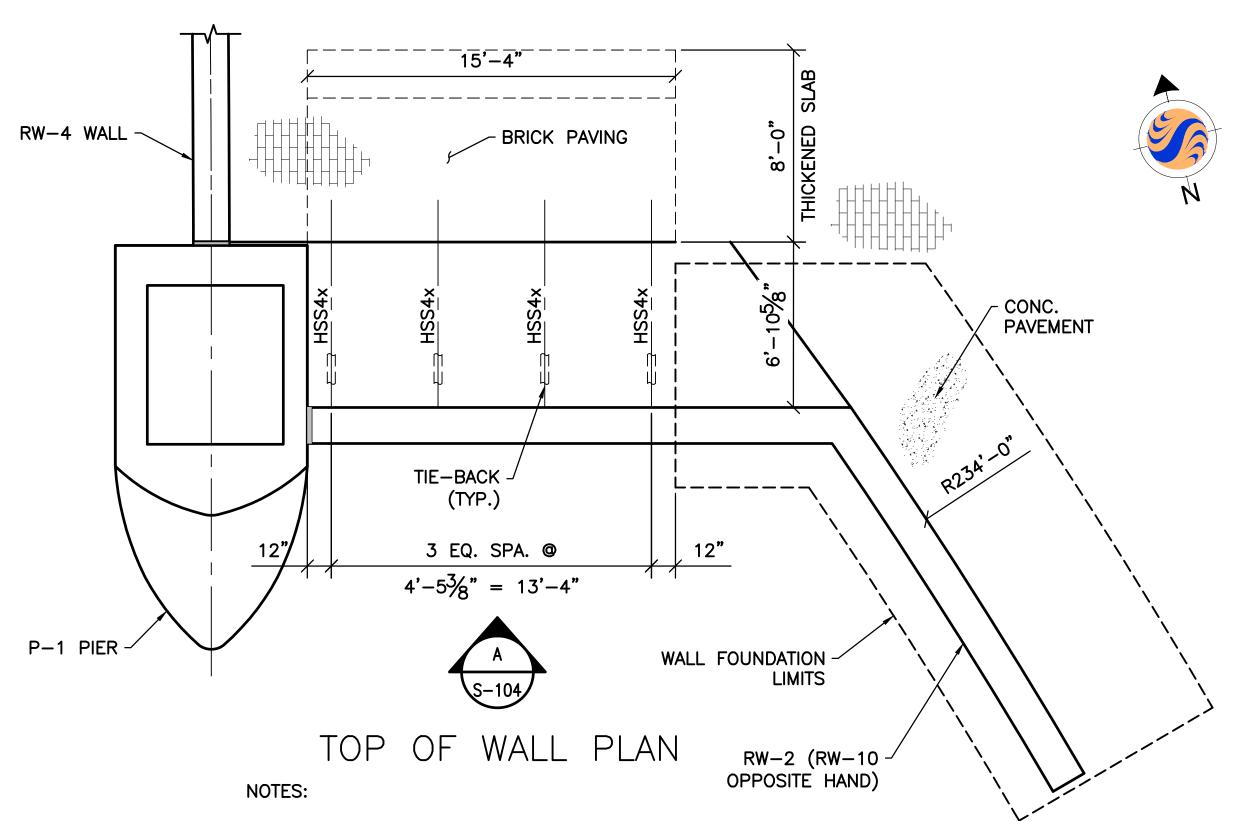

- 1. MAX ALLOWABLE BEARING PRESSURE FOR SHALLOW FOUNDATIONS = 7,500 PSF.
- 2. DESIGN LL = 250 PSF.
- 3. ALL STRUCTURAL SHAPES SHALL BE GALVANIZED STEEL AS NOTED BELOW:
 -HSS4x = HSS4x4x¹/₄

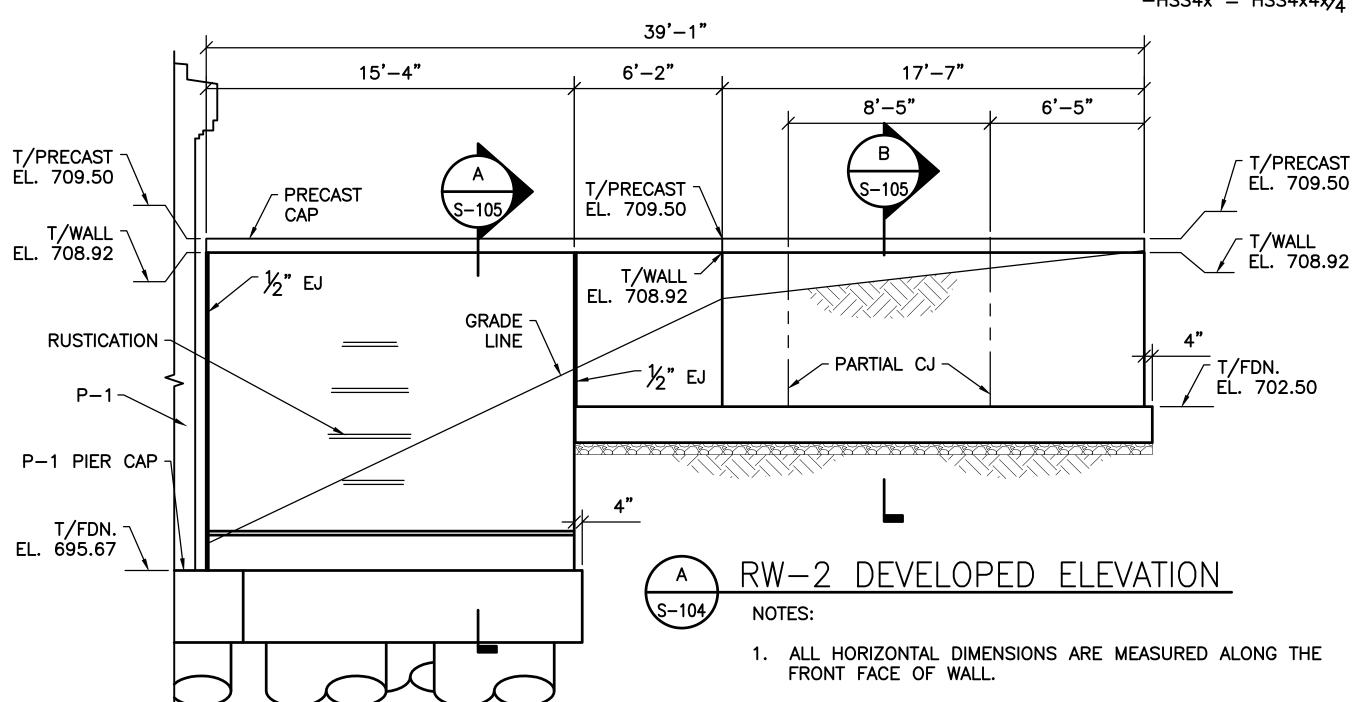


2. RAILING NOT SHOW FOR CLARITY.

SHEET NOTES:


- 1. FOR GENERAL NOTES AND TYPICAL DETAILS SEE SHEETS S-101, S-102, AND S-103.
- 2. SEE LANDSCAPE ARCHITECTURE DRAWINGS FOR ADJACENT PAVEMENT, PRECAST CAP, AND RUSTICATION DETAILS.

eenwd,	EA	SEMENT REFERENCE		RE	VISIONS	PREPARED BY:		PROJECT TITLE:		CITY OF C DEPARTMENT OF	COLUMBUS
city No.	COUNTY F	RECORDER	GRANTOR	NO. DESCRIPTION	APPROVAL/DATE	Stantec Consulting Services Inc.		COLUMBUS DOWNTOWN DEVELOPMI SCIOTO GREENWAYS PR	ROJECT	DEPARTMENT OF DIVISION OF SEWER	PUBLIC UTILITIES PAGE AND DRAINAGE
53_scio	VOL.	PAGE	GIVANOR			1500 Lake Shore Drive, Suite 100 Columbus, Ohio 43204 (614) 486–4383 Stantec (614) 486–4387		CITY OF COLUMBUS,	OHIO	DIVISION (USE ONLY
0.88						Stantec (614) 486–4387	RW-2 AND RW-10 DRILLED SHAFT PLAN, TOP	DIVISION USE ONLY	OWNER		
734						MKSK	OF WALL PLAN, AND DEVELOPED ELEVATION		CONTRACTOR		
(e/1						LANDSCAPE ARCHITECTURE + URBAN PLANNING			INSPECTOR	SCALE: 1/4" = 1'-0"	SHEET: S-104
activ						LANDSCAPE ARCHITECTURE + URBAN PLANNING			AGREEMENT COMPLETED	30/LE. 17 1 - 1 G	3 107
24/0									RPD CKD CLD CON. DR.	CONTRACT DRAWING NO.	RECORD PLAN NO.
\173									INDEX RECORD DETAIL FILE	CC-16423	


53_scioto_greenways\structural\final design\drawing\s-104.dwg

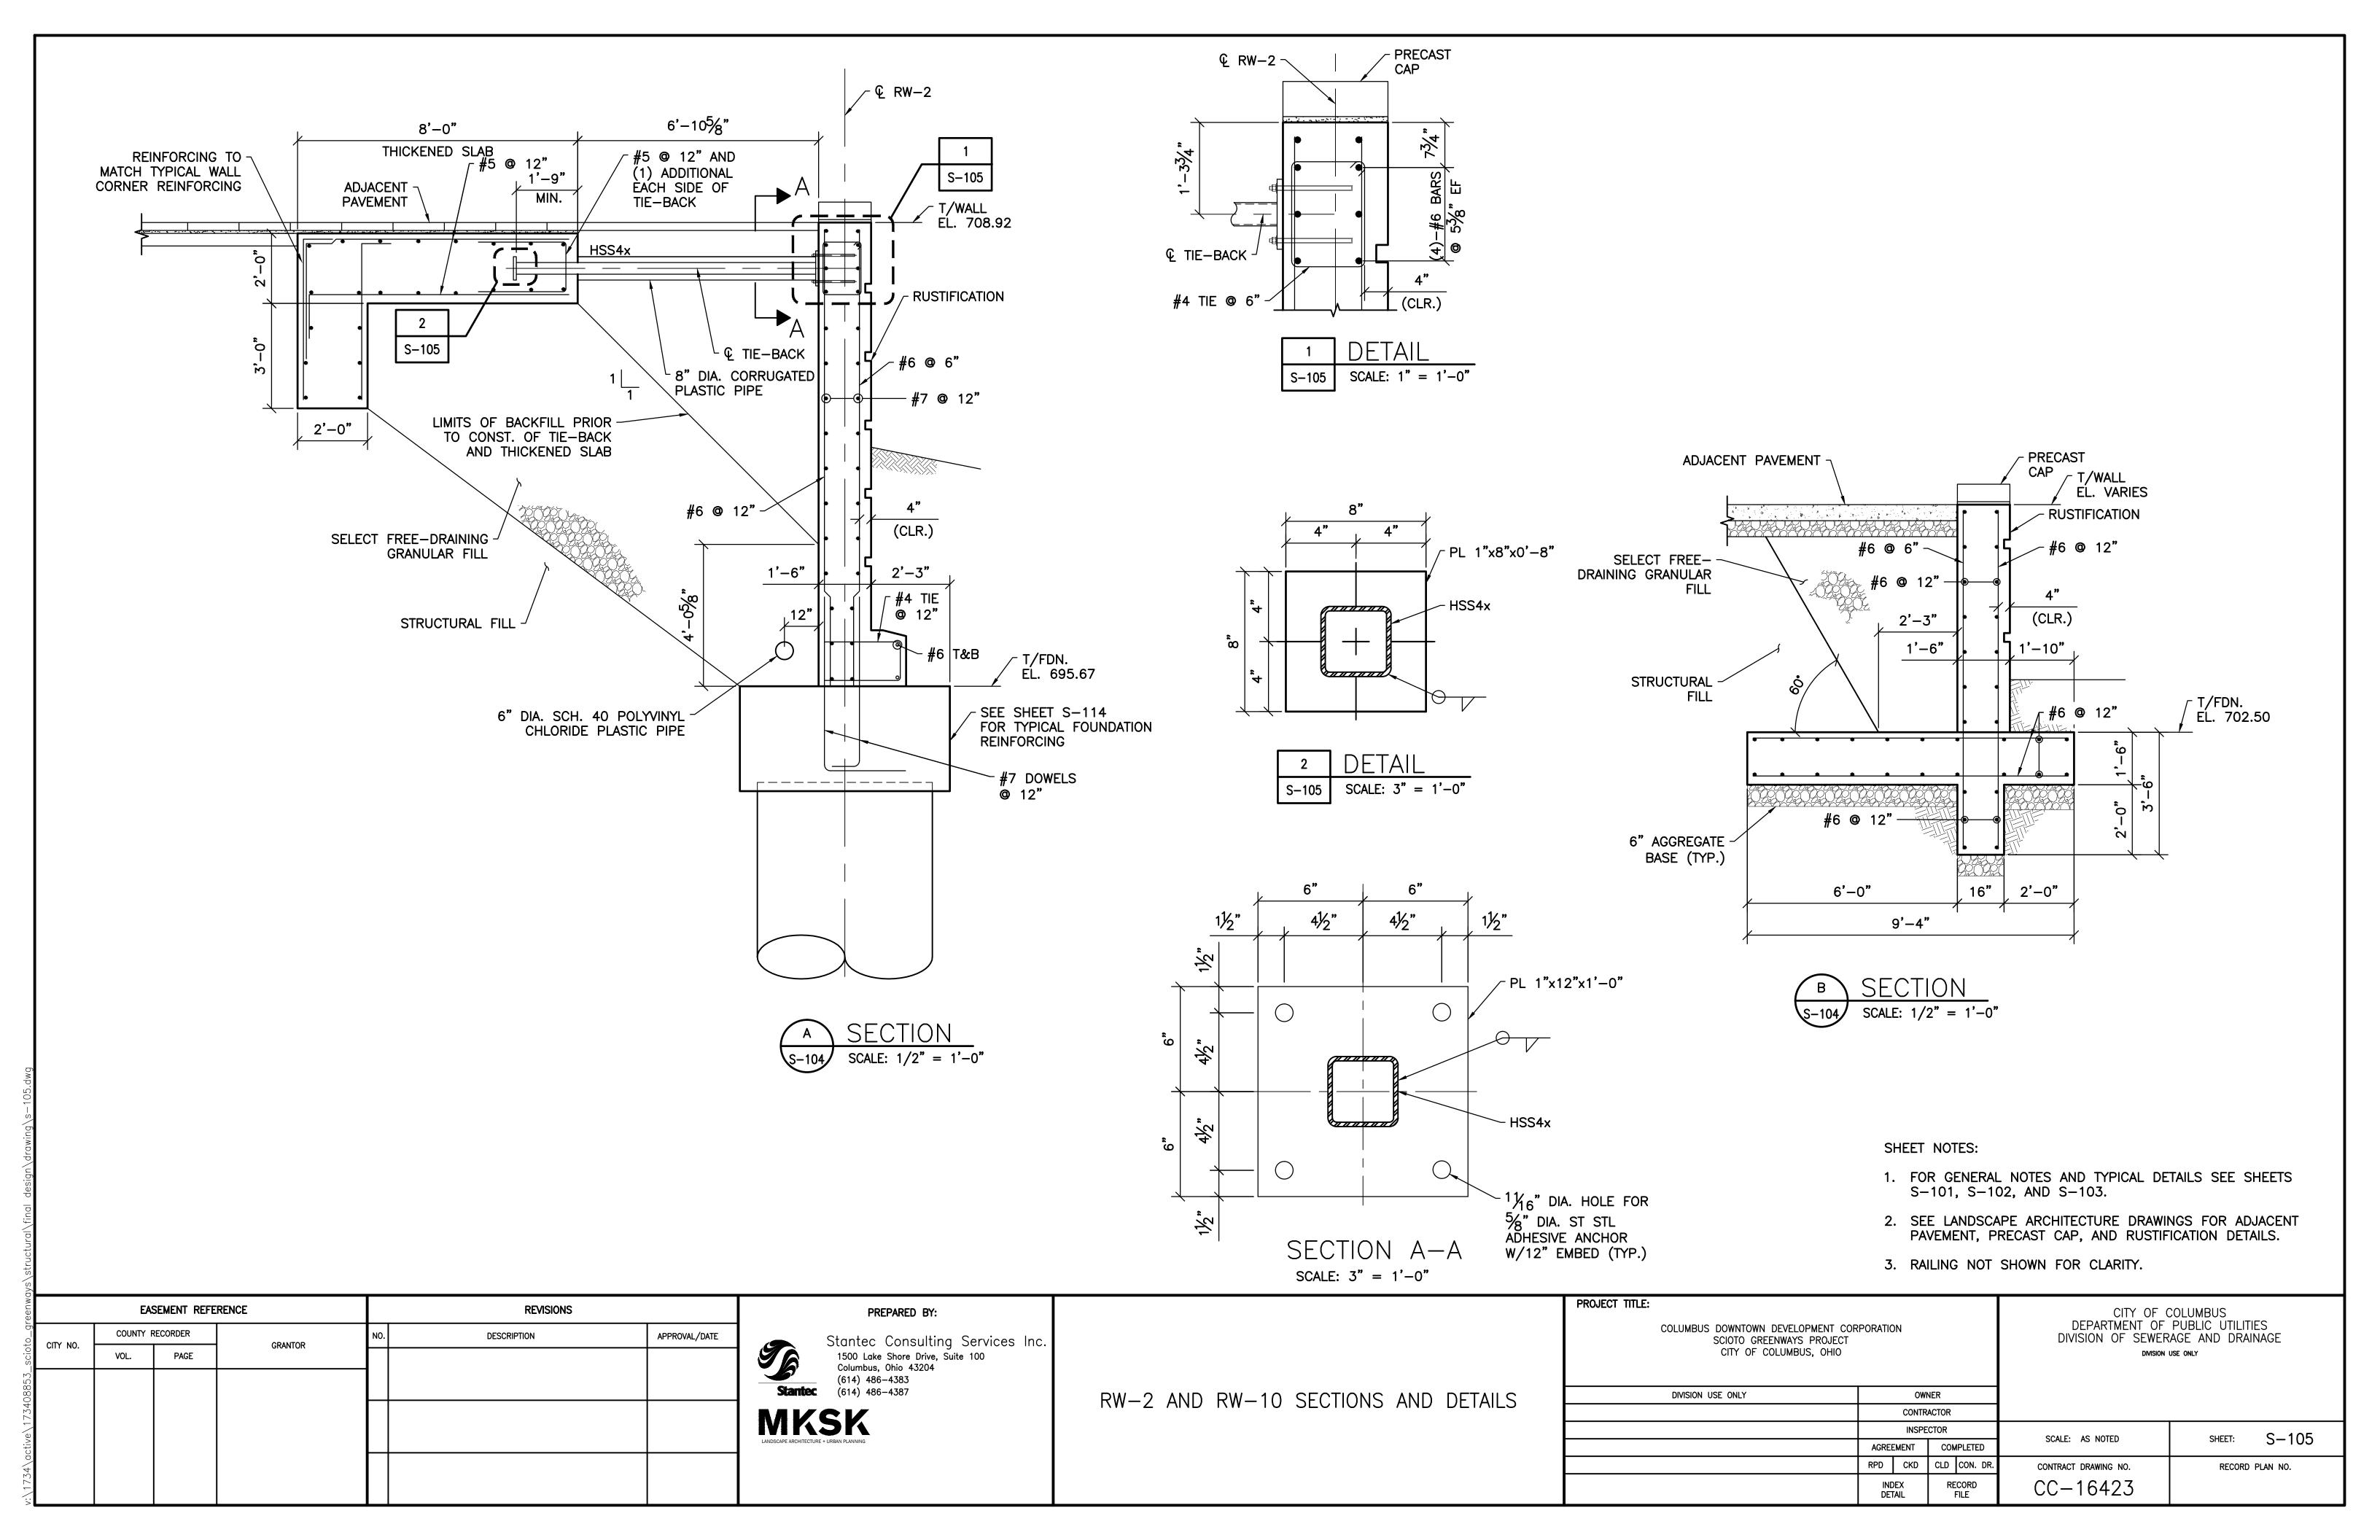



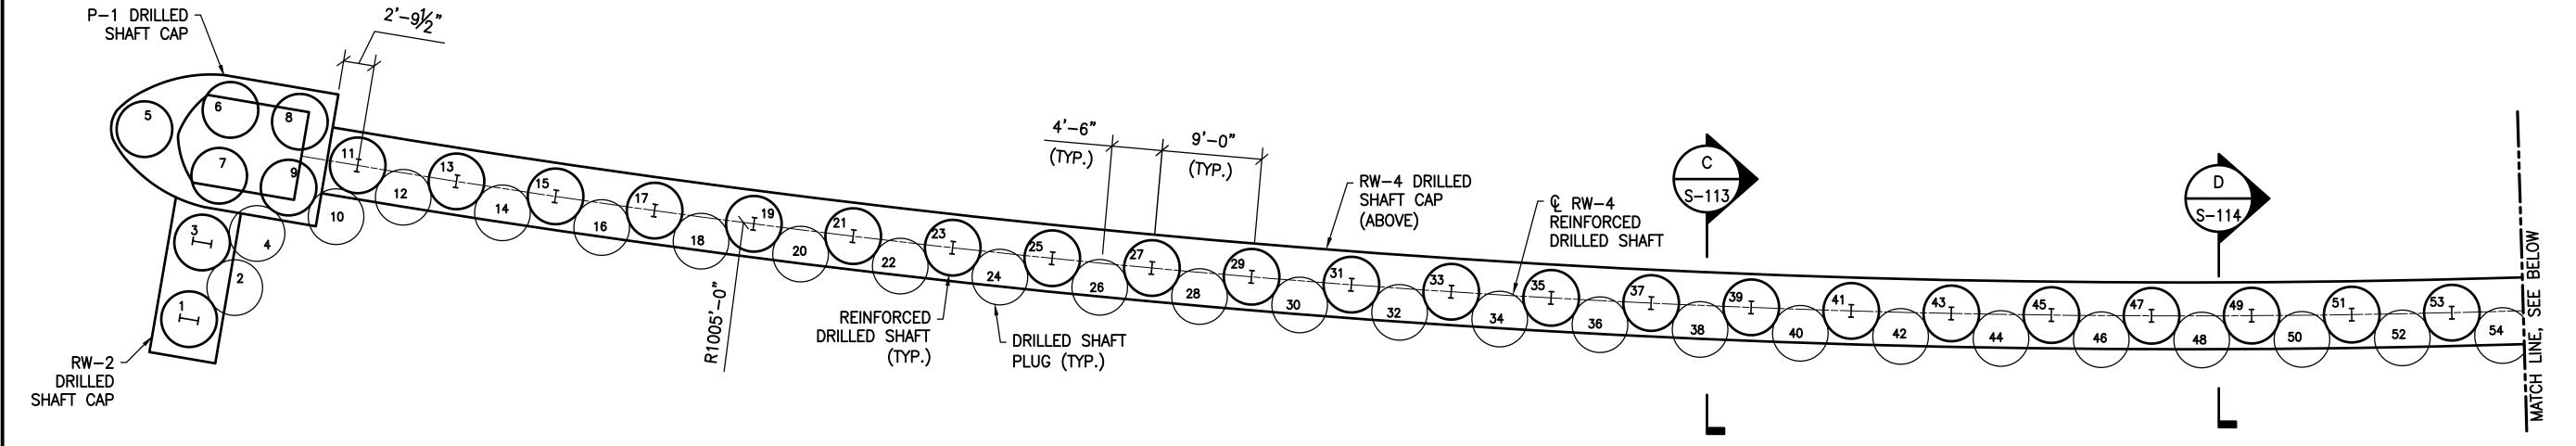

PARTIAL DRILLED SHAFT PLAN

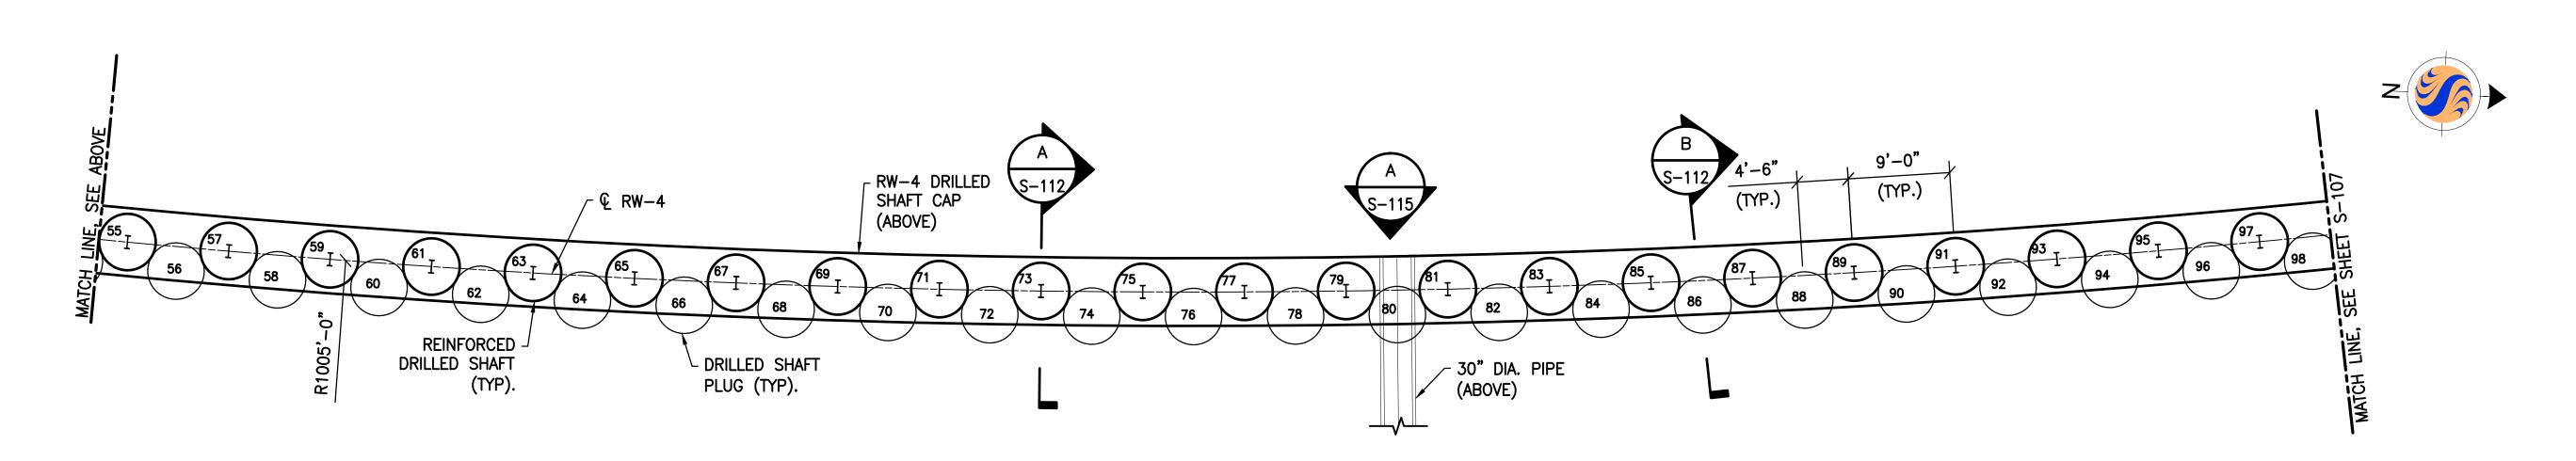


PARTIAL DRILLED SHAFT PLAN

SHEET NOTES:


- 1. FOR GENERAL NOTES AND TYPICAL DETAILS SEE SHEETS S-101, S-102, AND S-103.
- 2. ALL DRILLED SHAFTS TO BE 5'-0" DIAMETER DRILLED SHAFTS.
- 3. MAX ALLOWABLE VERTICAL CAPACITY OF REINFORCED DRILLED SHAFTS = 153 TONS.
- 4. ALL HORIZONTAL DIMENSIONS ARE MEASTURE ALONG € OF RW-4.

EASEMENT REFERENCE		REVISIONS		REVISIONS PREPARED BY:		PROJECT TITLE:	CITY OF COLUMBUS DEPARTMENT OF PUBLIC UTILITIES DIVISION OF SEWERAGE AND DRAINAGE			
CITY NO	COUNTY RECORDER GRANTOR		NO. DESCRIPTION	APPROVAL/DATE	Stantec Consulting Services Inc.		COLUMBUS DOWNTOWN DEVELOPMENT CORPORATION SCIOTO GREENWAYS PROJECT	DIVISION OF SEWERAGE AND DRAINAGE		
	VOL.	PAGE	GIVARION			1500 Lake Shore Drive, Suite 100		CITY OF COLUMBUS, OHIO	DIVISION USE ONLY	
						Columbus, Ohio 43204 (614) 486–4383 Stantec (614) 486–4387	RW-4 DRILLED SHAFT PLAN 1	DIVISION USE ONLY OWNER		
						MKSK	TOW A DIVIDLE STATE I DATE	CONTRACTOR		
						LANDSCAPE ARCHITECTURE + URBAN PLANNING		INSPECTOR	SCALE: $1/8" = 1'-0"$ SHEET: $S-106$	
						LANDSCAPE ARCHITECTURE + URBAN PLANNING		AGREEMENT COMPLETE	30/1221 1/0 = 1 0	
								RPD CKD CLD CON.	OR. CONTRACT DRAWING NO. RECORD PLAN NO.	
								INDEX RECORD DETAIL FILE	CC-16423	

oto_greenways\structural\final_design\drawing\s-106.dwg

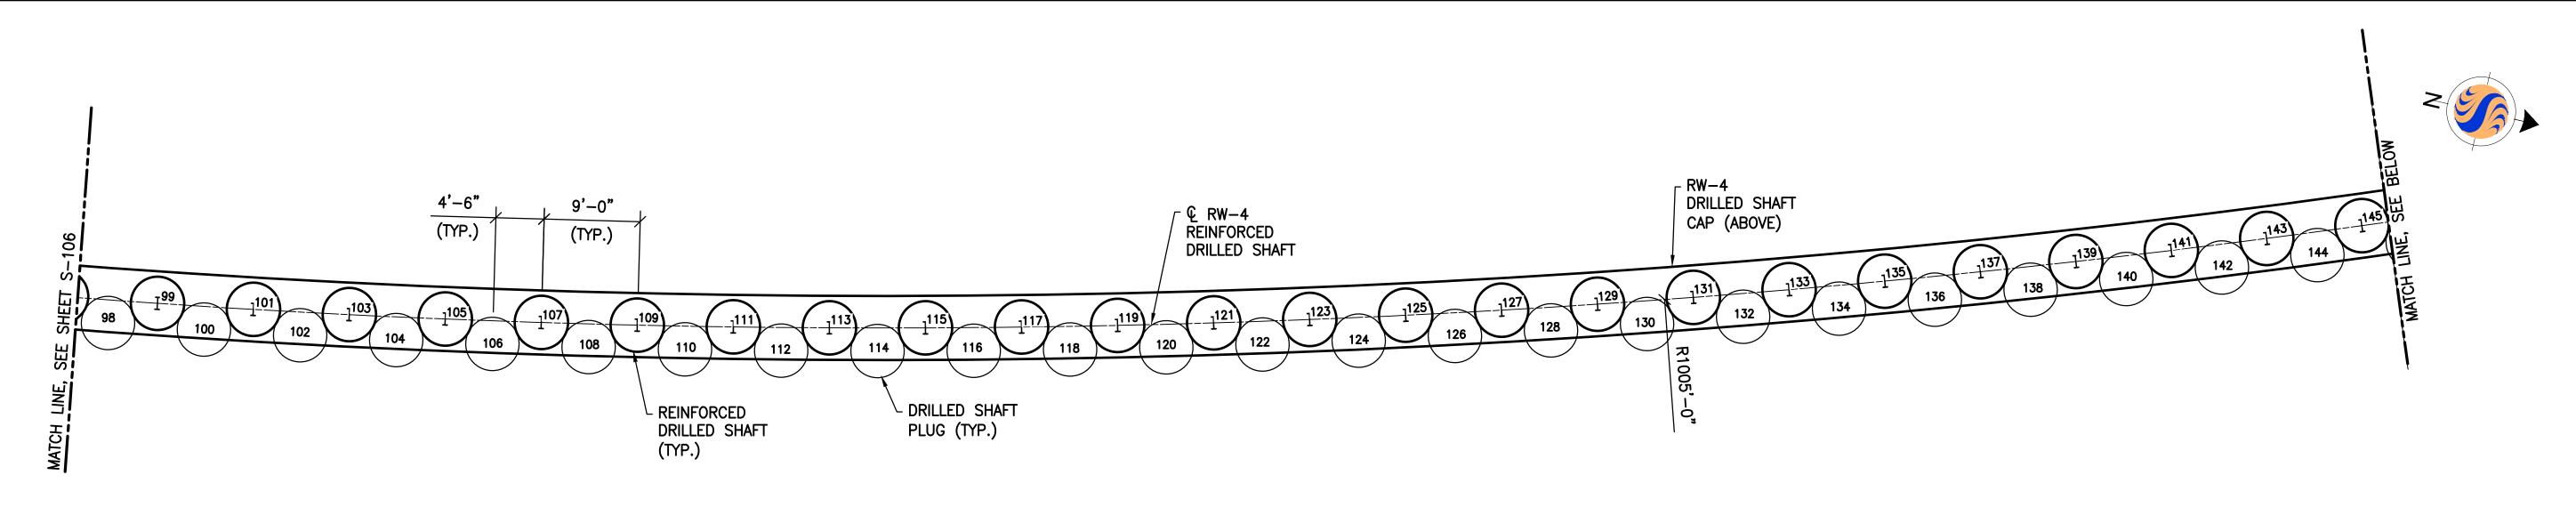


PARTIAL DRILLED SHAFT PLAN

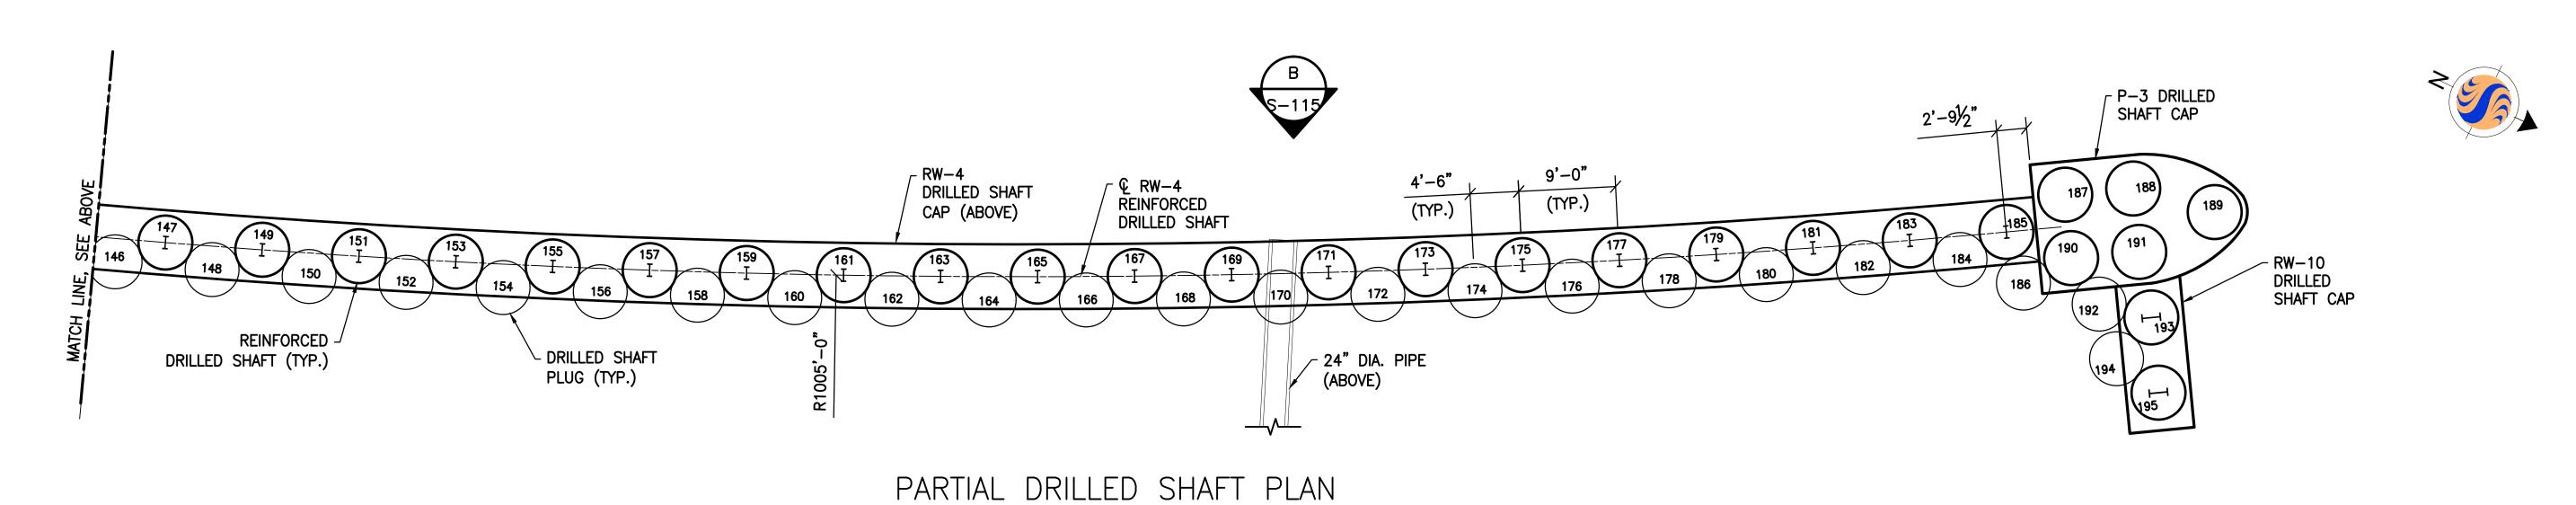



SHEET NOTES:


- 1. FOR GENERAL NOTES AND TYPICAL DETAILS SEE SHEETS S-101, S-102, AND S-103.
- 2. ALL DRILLED SHAFTS TO BE 5'-0" DIAMETER DRILLED SHAFTS.
- 3. MAX ALLOWABLE VERTICAL CAPACITY OF THE REINFORCED DRILLED SHAFTS = 153 TONS.
- 4. ALL HORIZONTAL DIMENSIONS ARE MEASURED ALONG € RW-4.


	EA	SEMENT REFER	IT REFERENCE REVISIONS		PREPARED BY:		PROJECT TITLE:			CITY OF COLUMBUS DEPARTMENT OF PUBLIC UTILITIES						
CITY NO.	COUNTY RECORDER		GRANTOR	NO. DESCRIPTION	O. DESCRIPTION APPROVAL/DATE	Stantec Consulting Services Inc.		SCIOTO GREENWAYS F	COLUMBUS DOWNTOWN DEVELOPMENT CORPORATION SCIOTO GREENWAYS PROJECT			DIVISION OF SEWERAGE AND DRAINAGE				
0111 110.	VOL.	PAGE	or which			1500 Lake Shore Drive, Suite 100 Columbus, Ohio 43204		CITY OF COLUMBUS,	, OHIO		DIVISION US	SE ONLY				
						(614) 486–4383 Stantec (614) 486–4387	DW 4 DDILLED CLIAET DLAN O	DIVISION USE ONLY	OWNER							
						MKSK			MKSK	MAVCV	RW-4 DRILLED SHAFT PLAN 2		CONTRACTOR		<u></u>	
											INSPECTOR		SCALE: 1/8" = 1'-0"	SHEET: S-107		
						LANDSCAPE ARCHITECTURE + URBAN PLANNING			AGREEMENT COMP	LETED	SCALE. 1/8 = 1 -0	3-107				
									RPD CKD CLD C	ON. DR.	CONTRACT DRAWING NO.	RECORD PLAN NO.				
									INDEX REC DETAIL FII	ORD E	CC-16423					

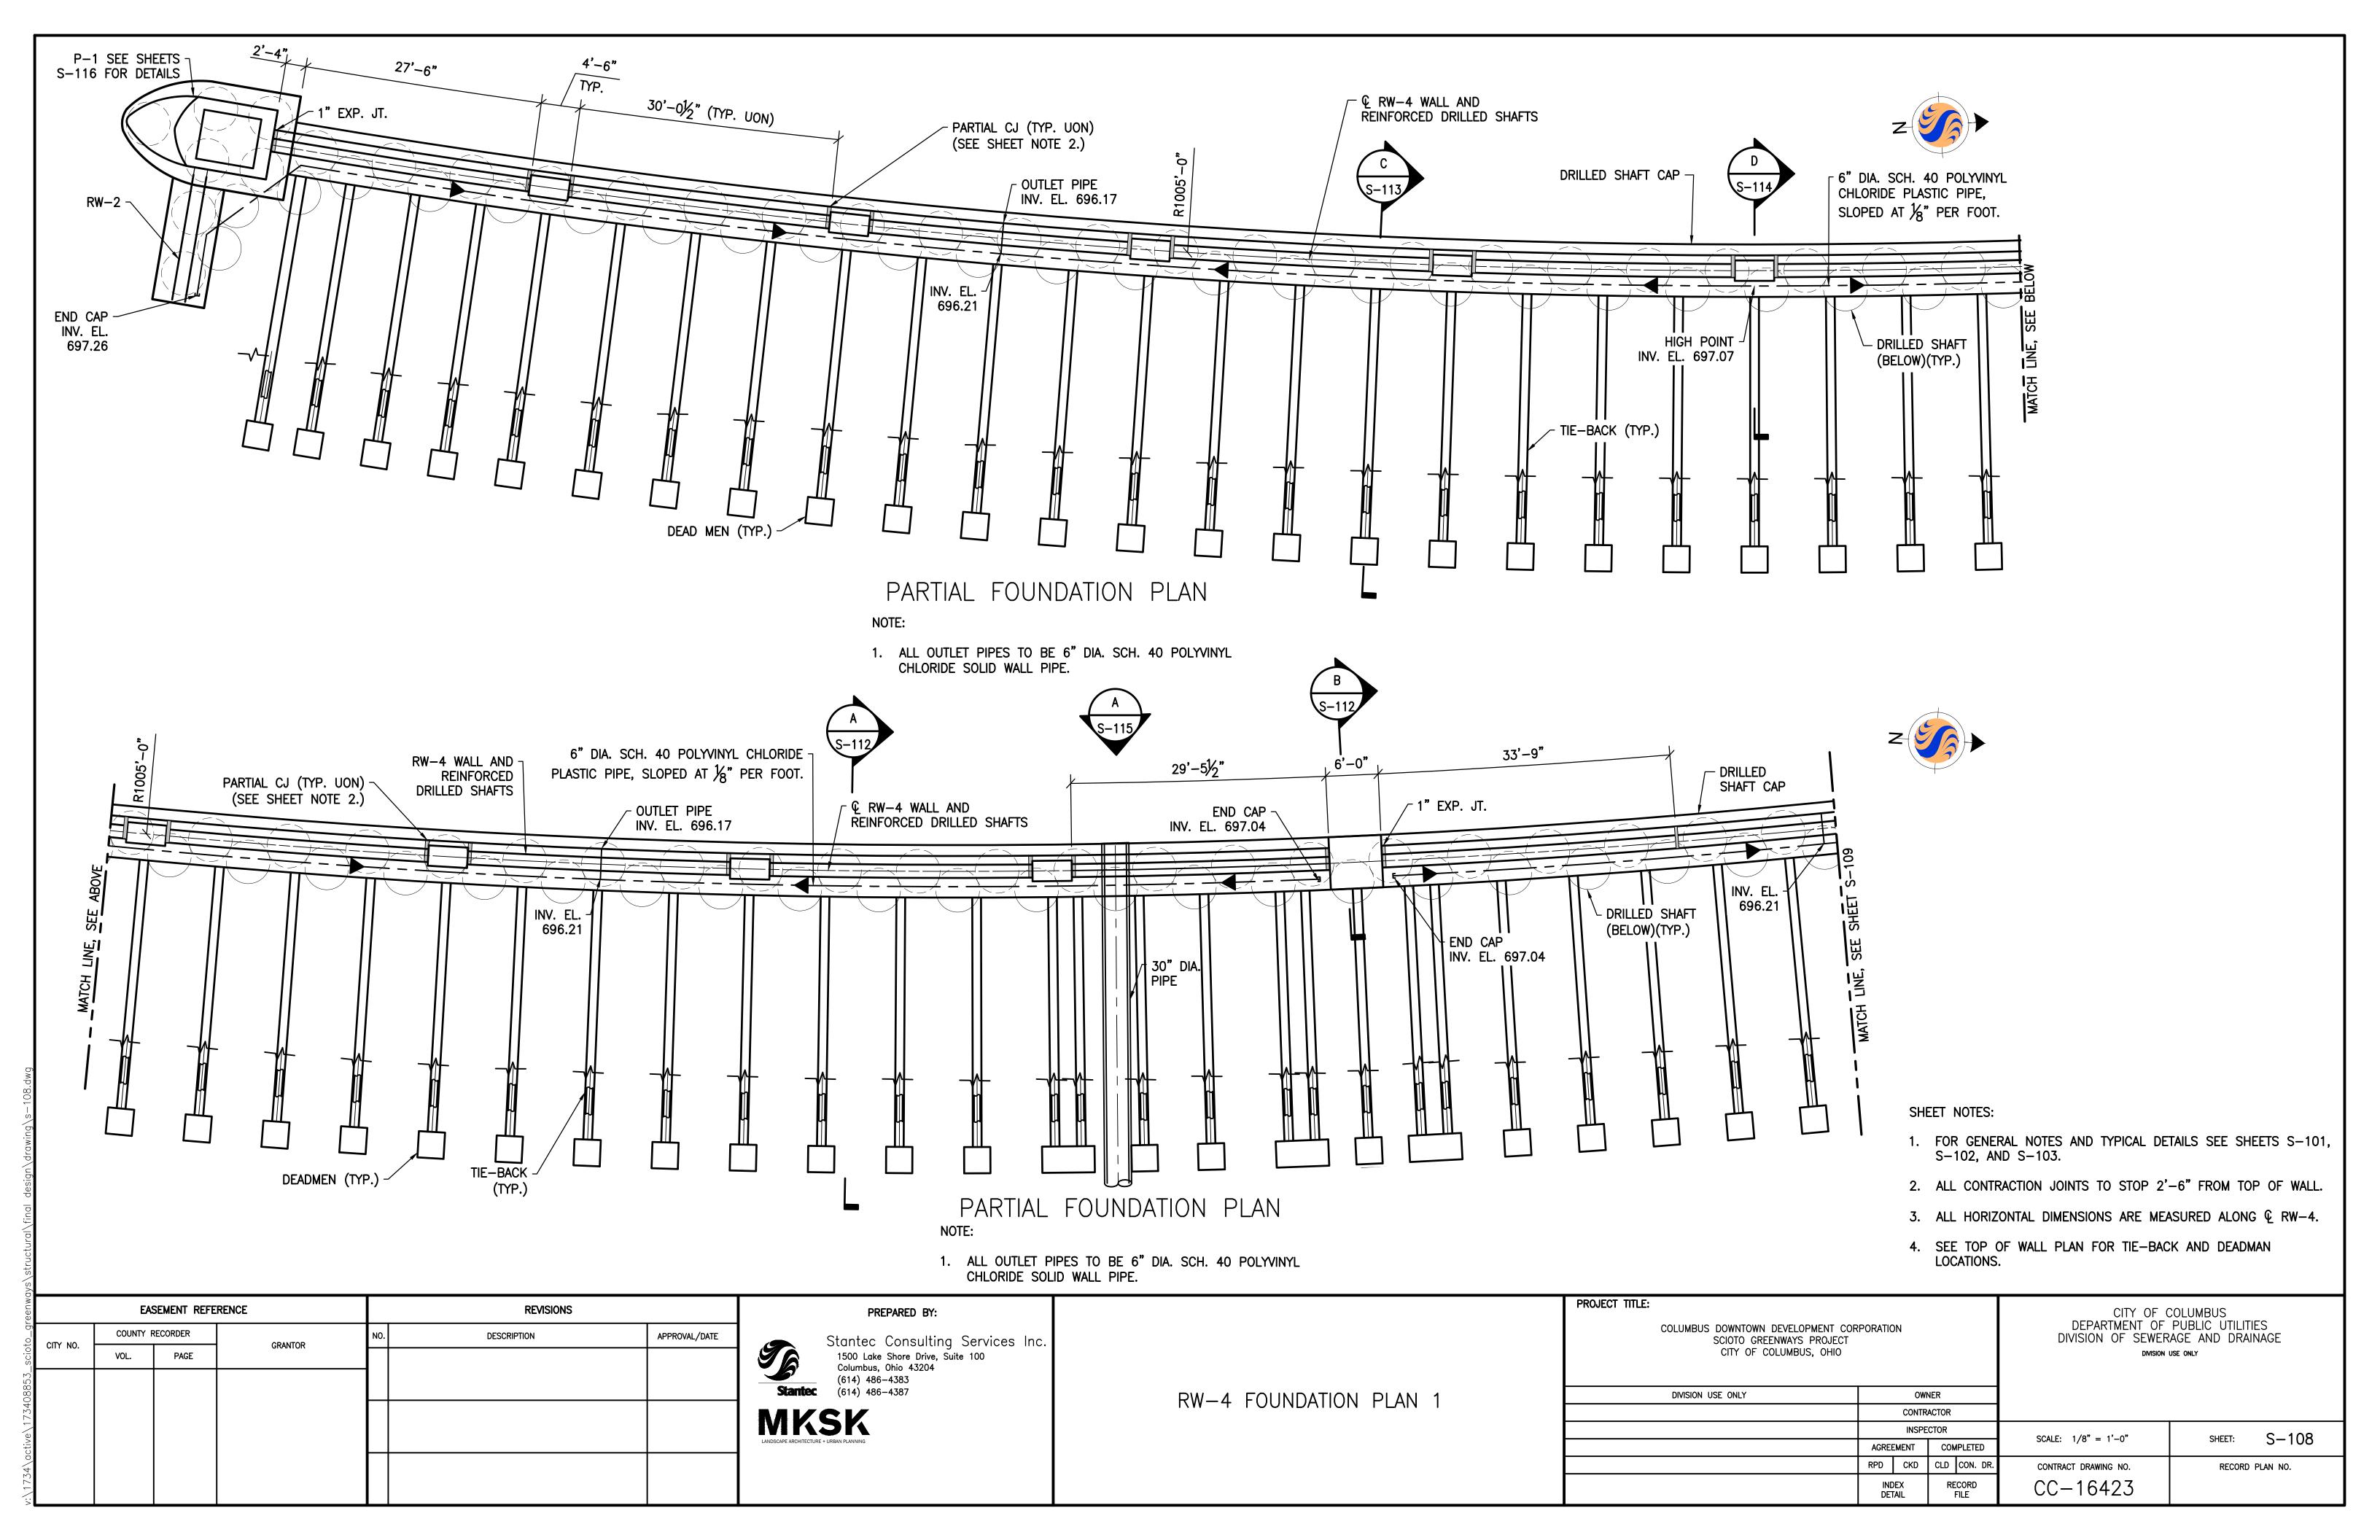


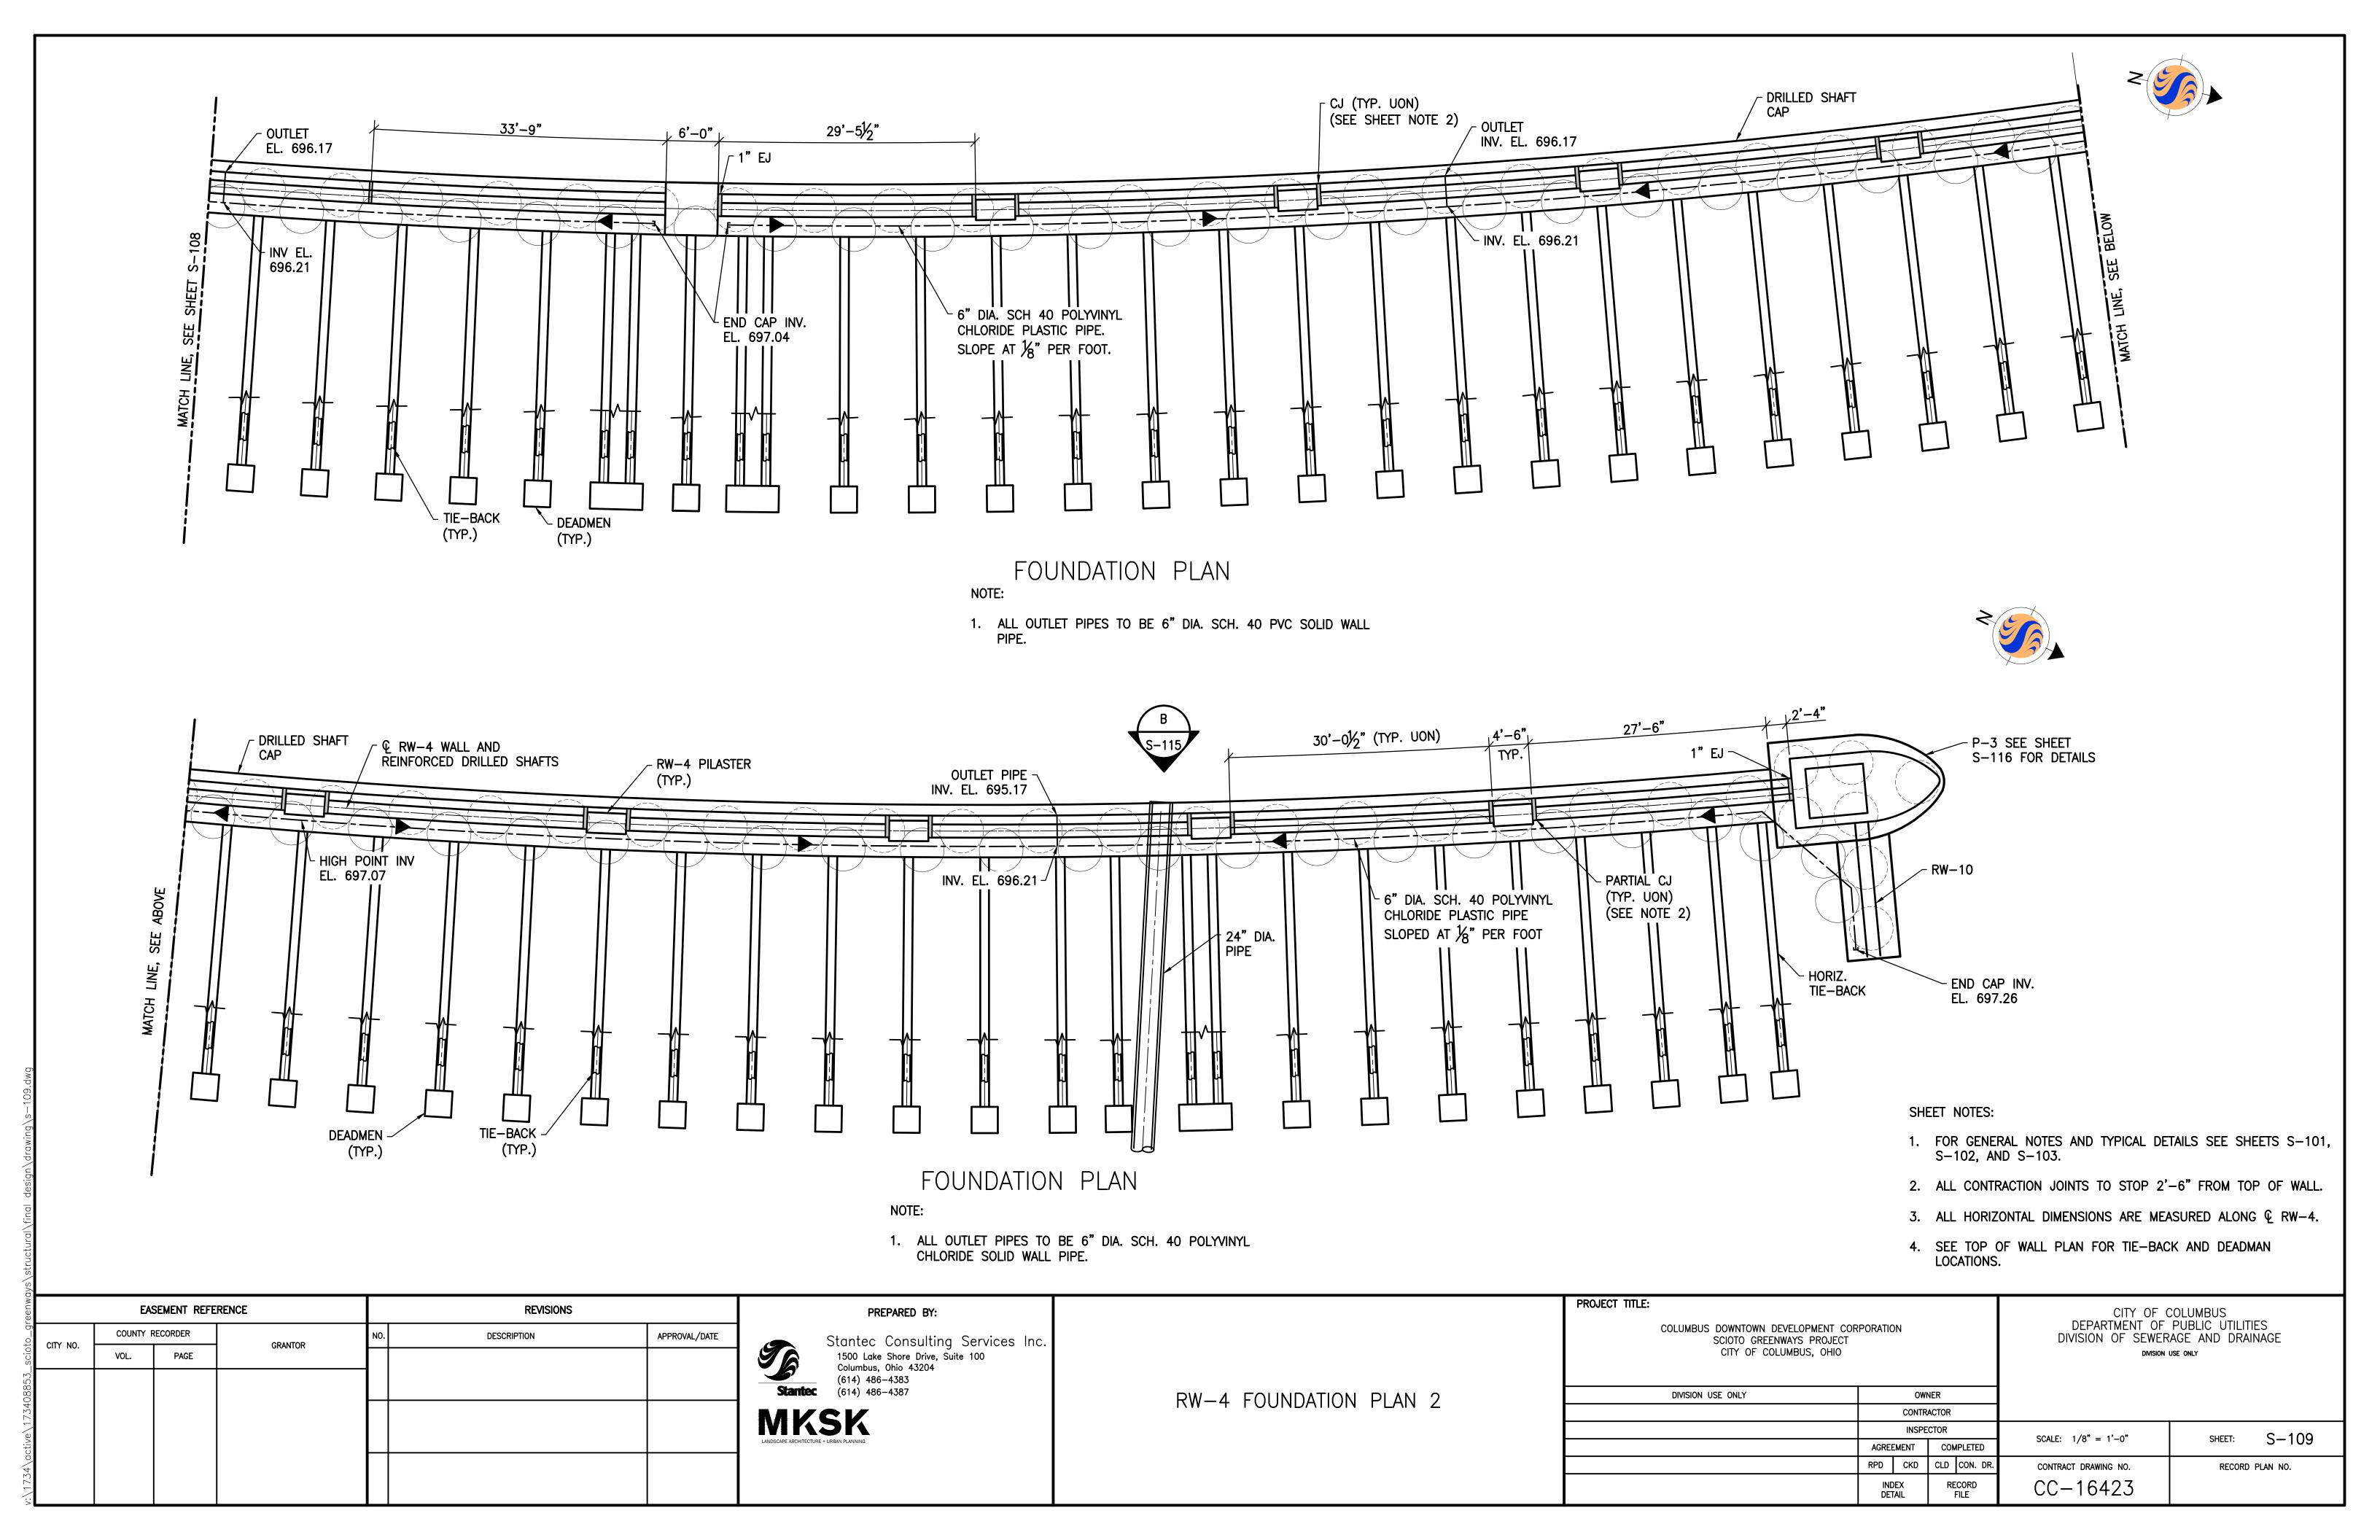

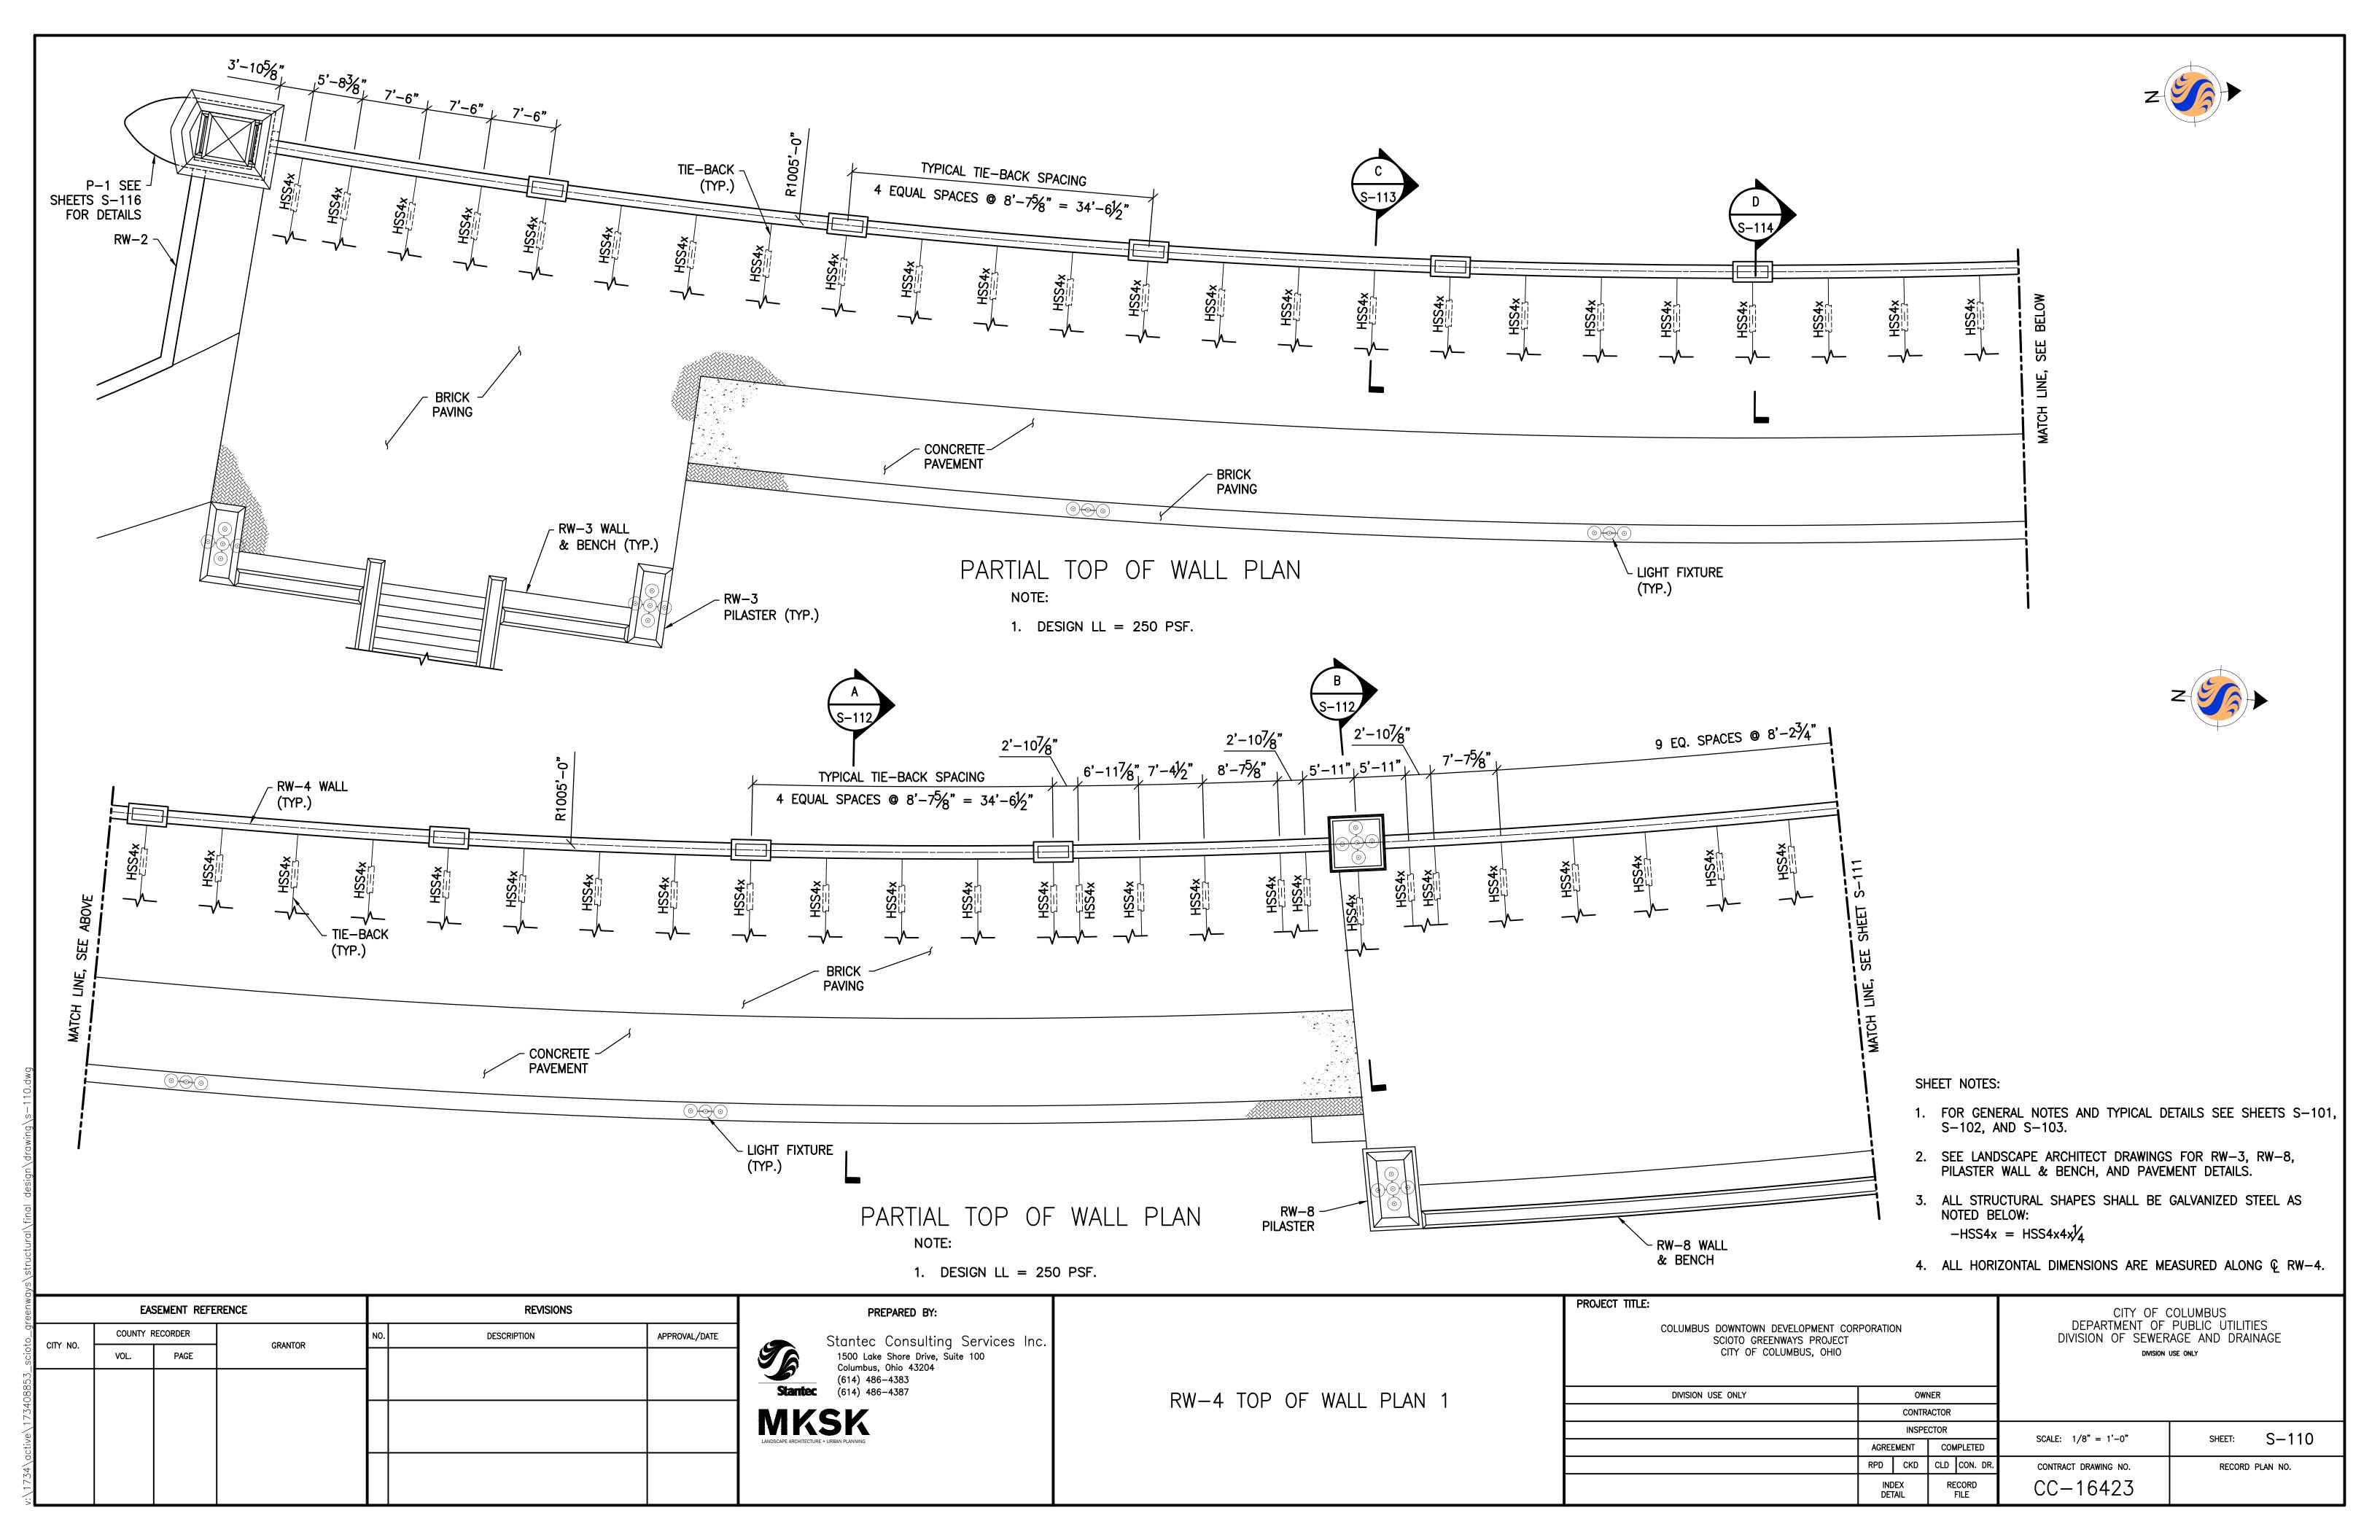

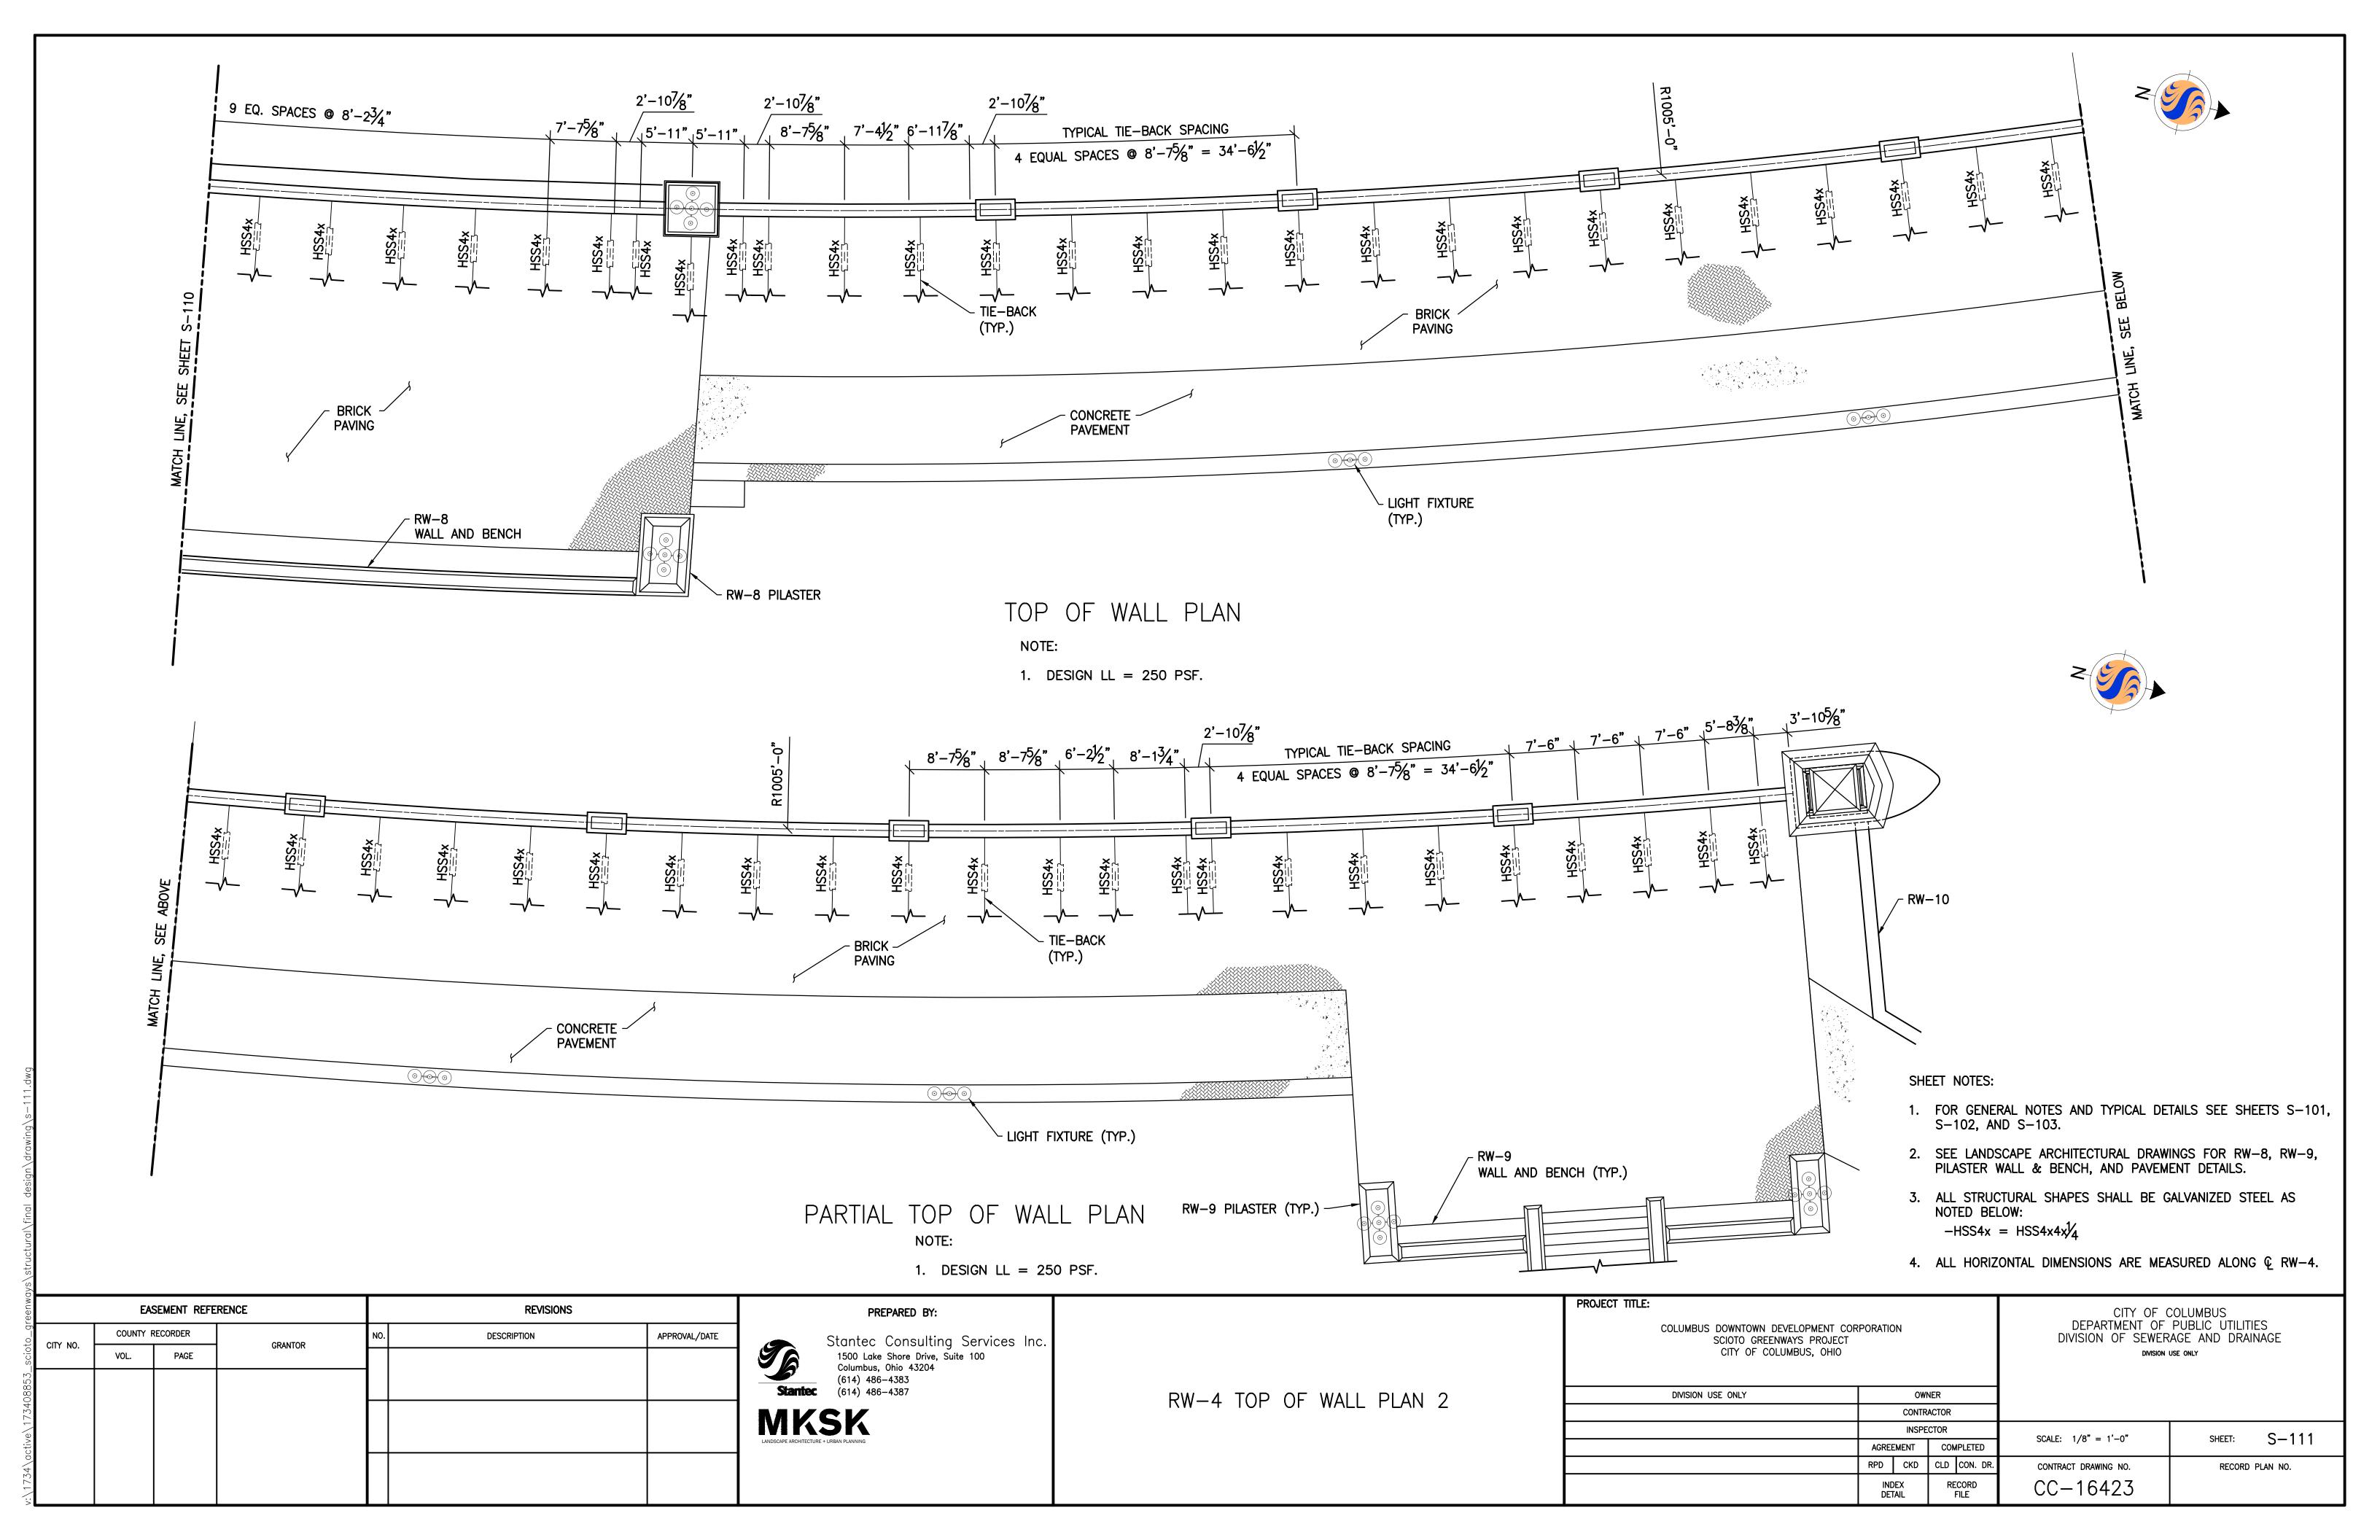

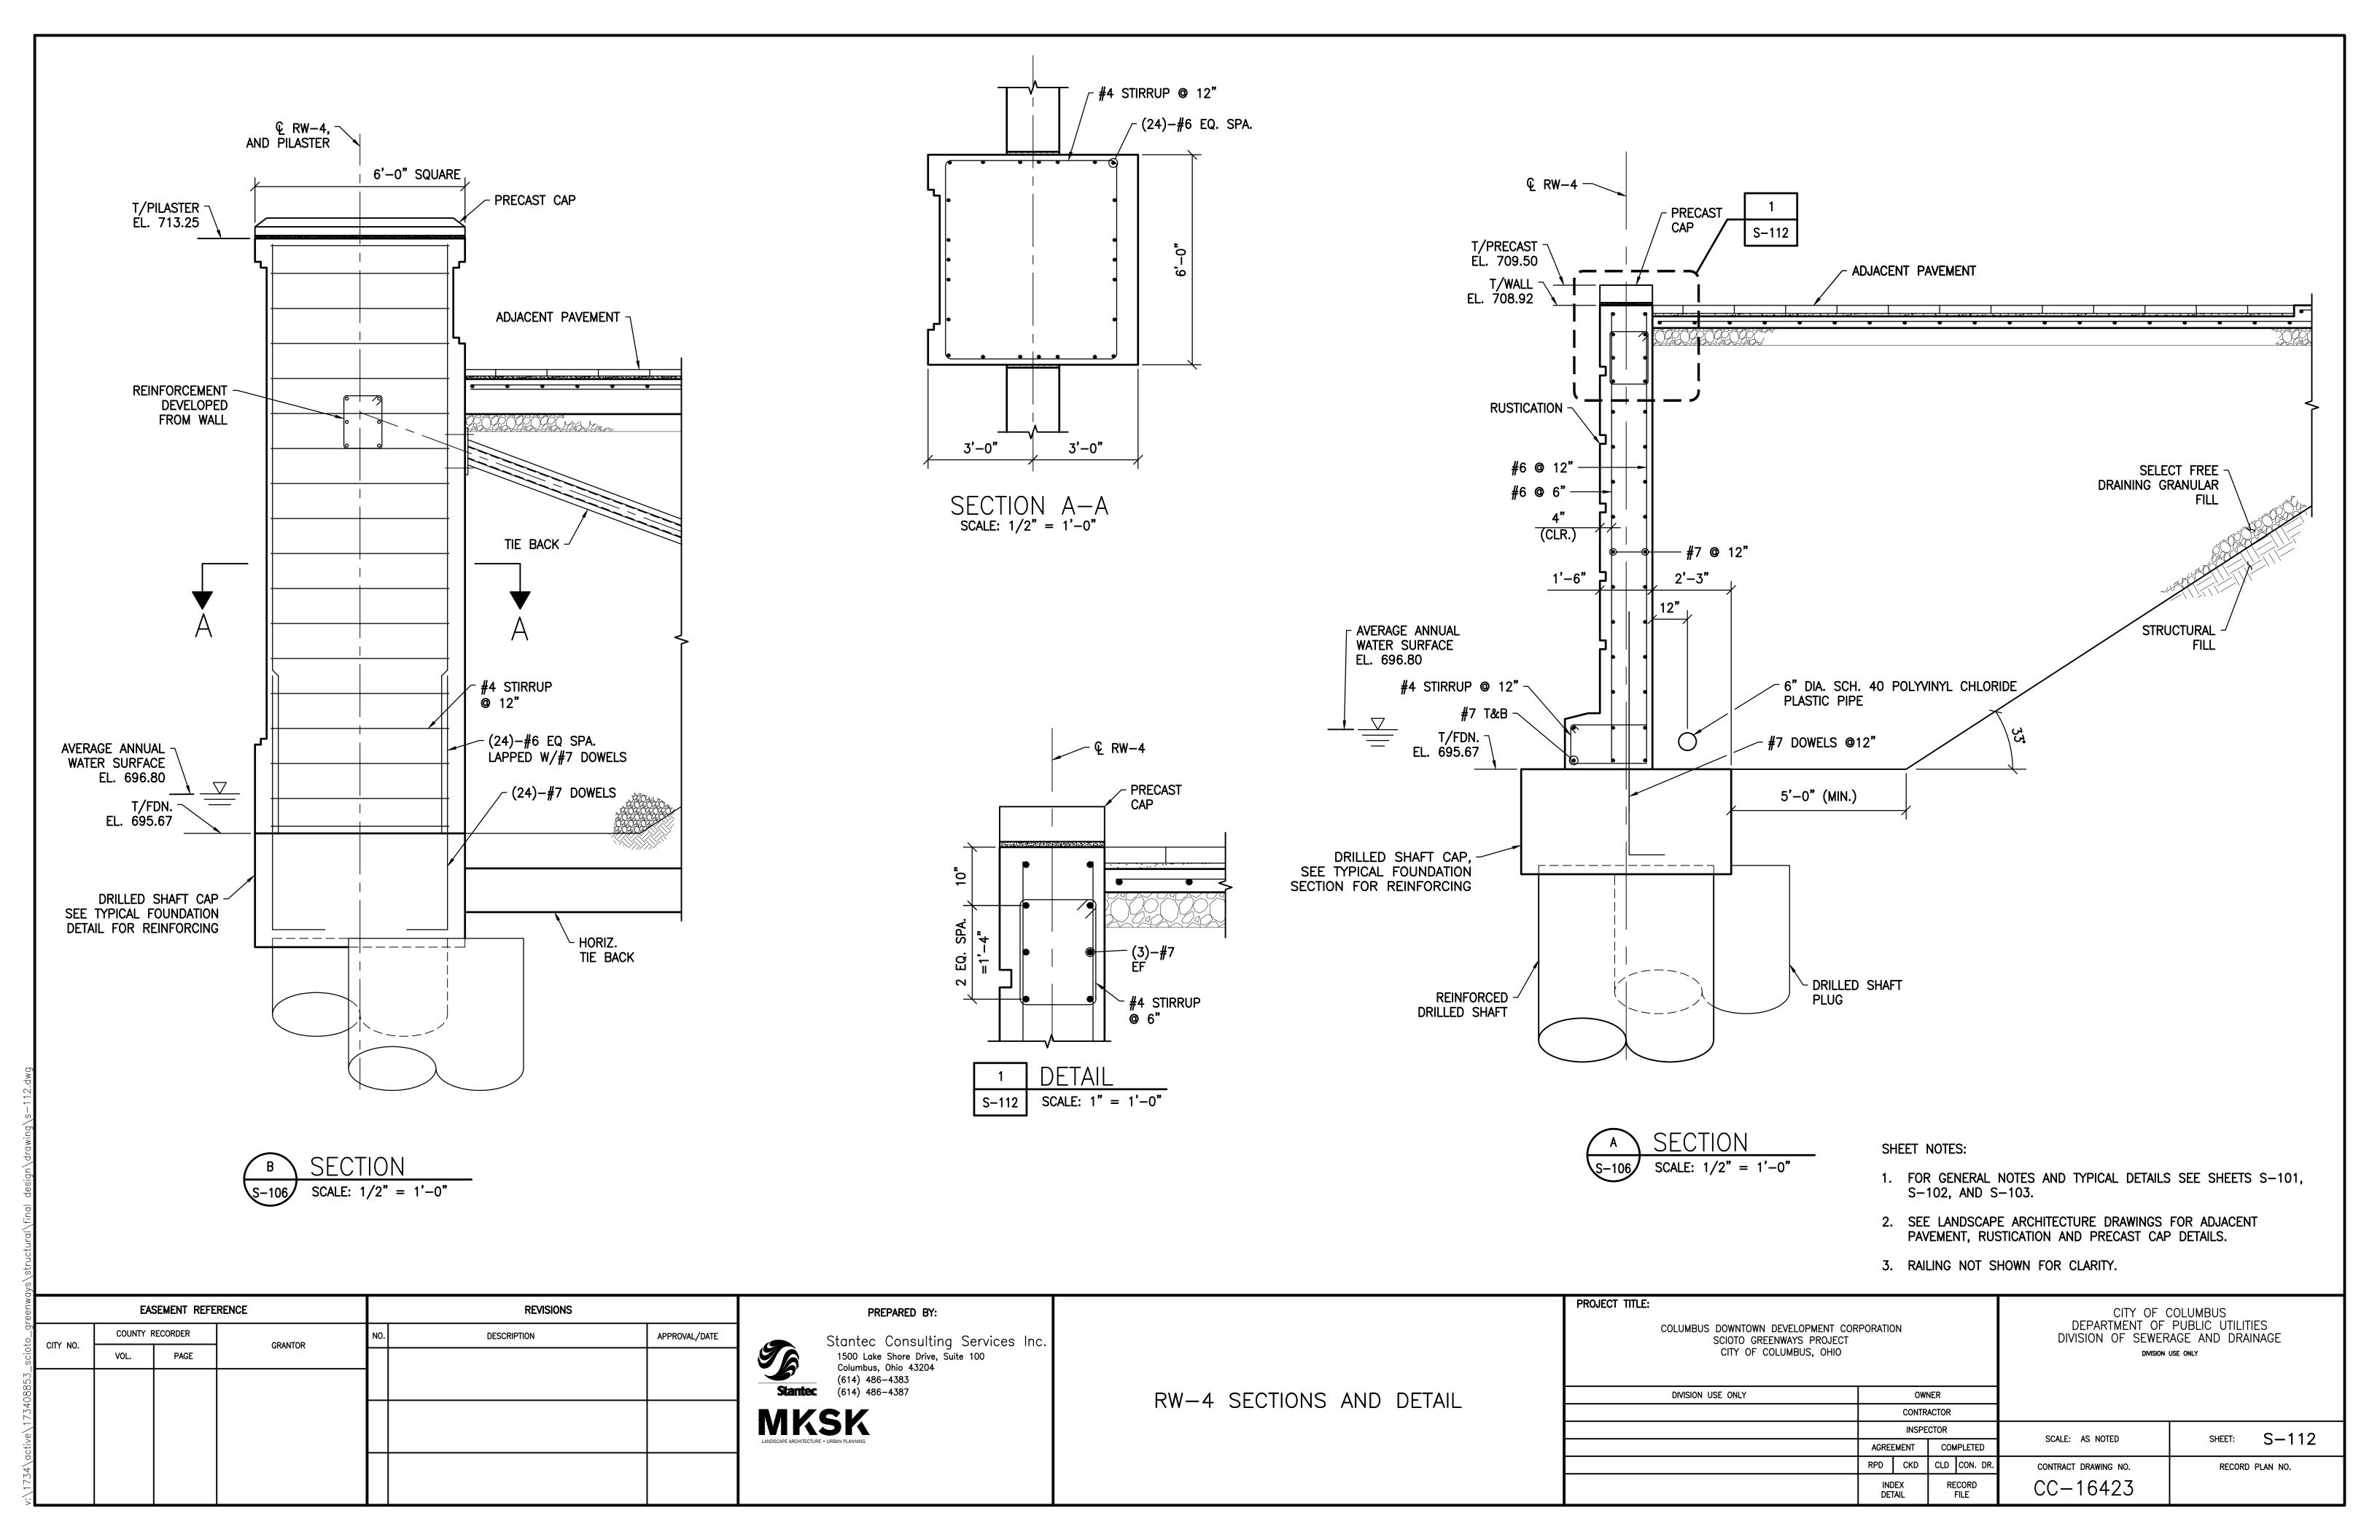

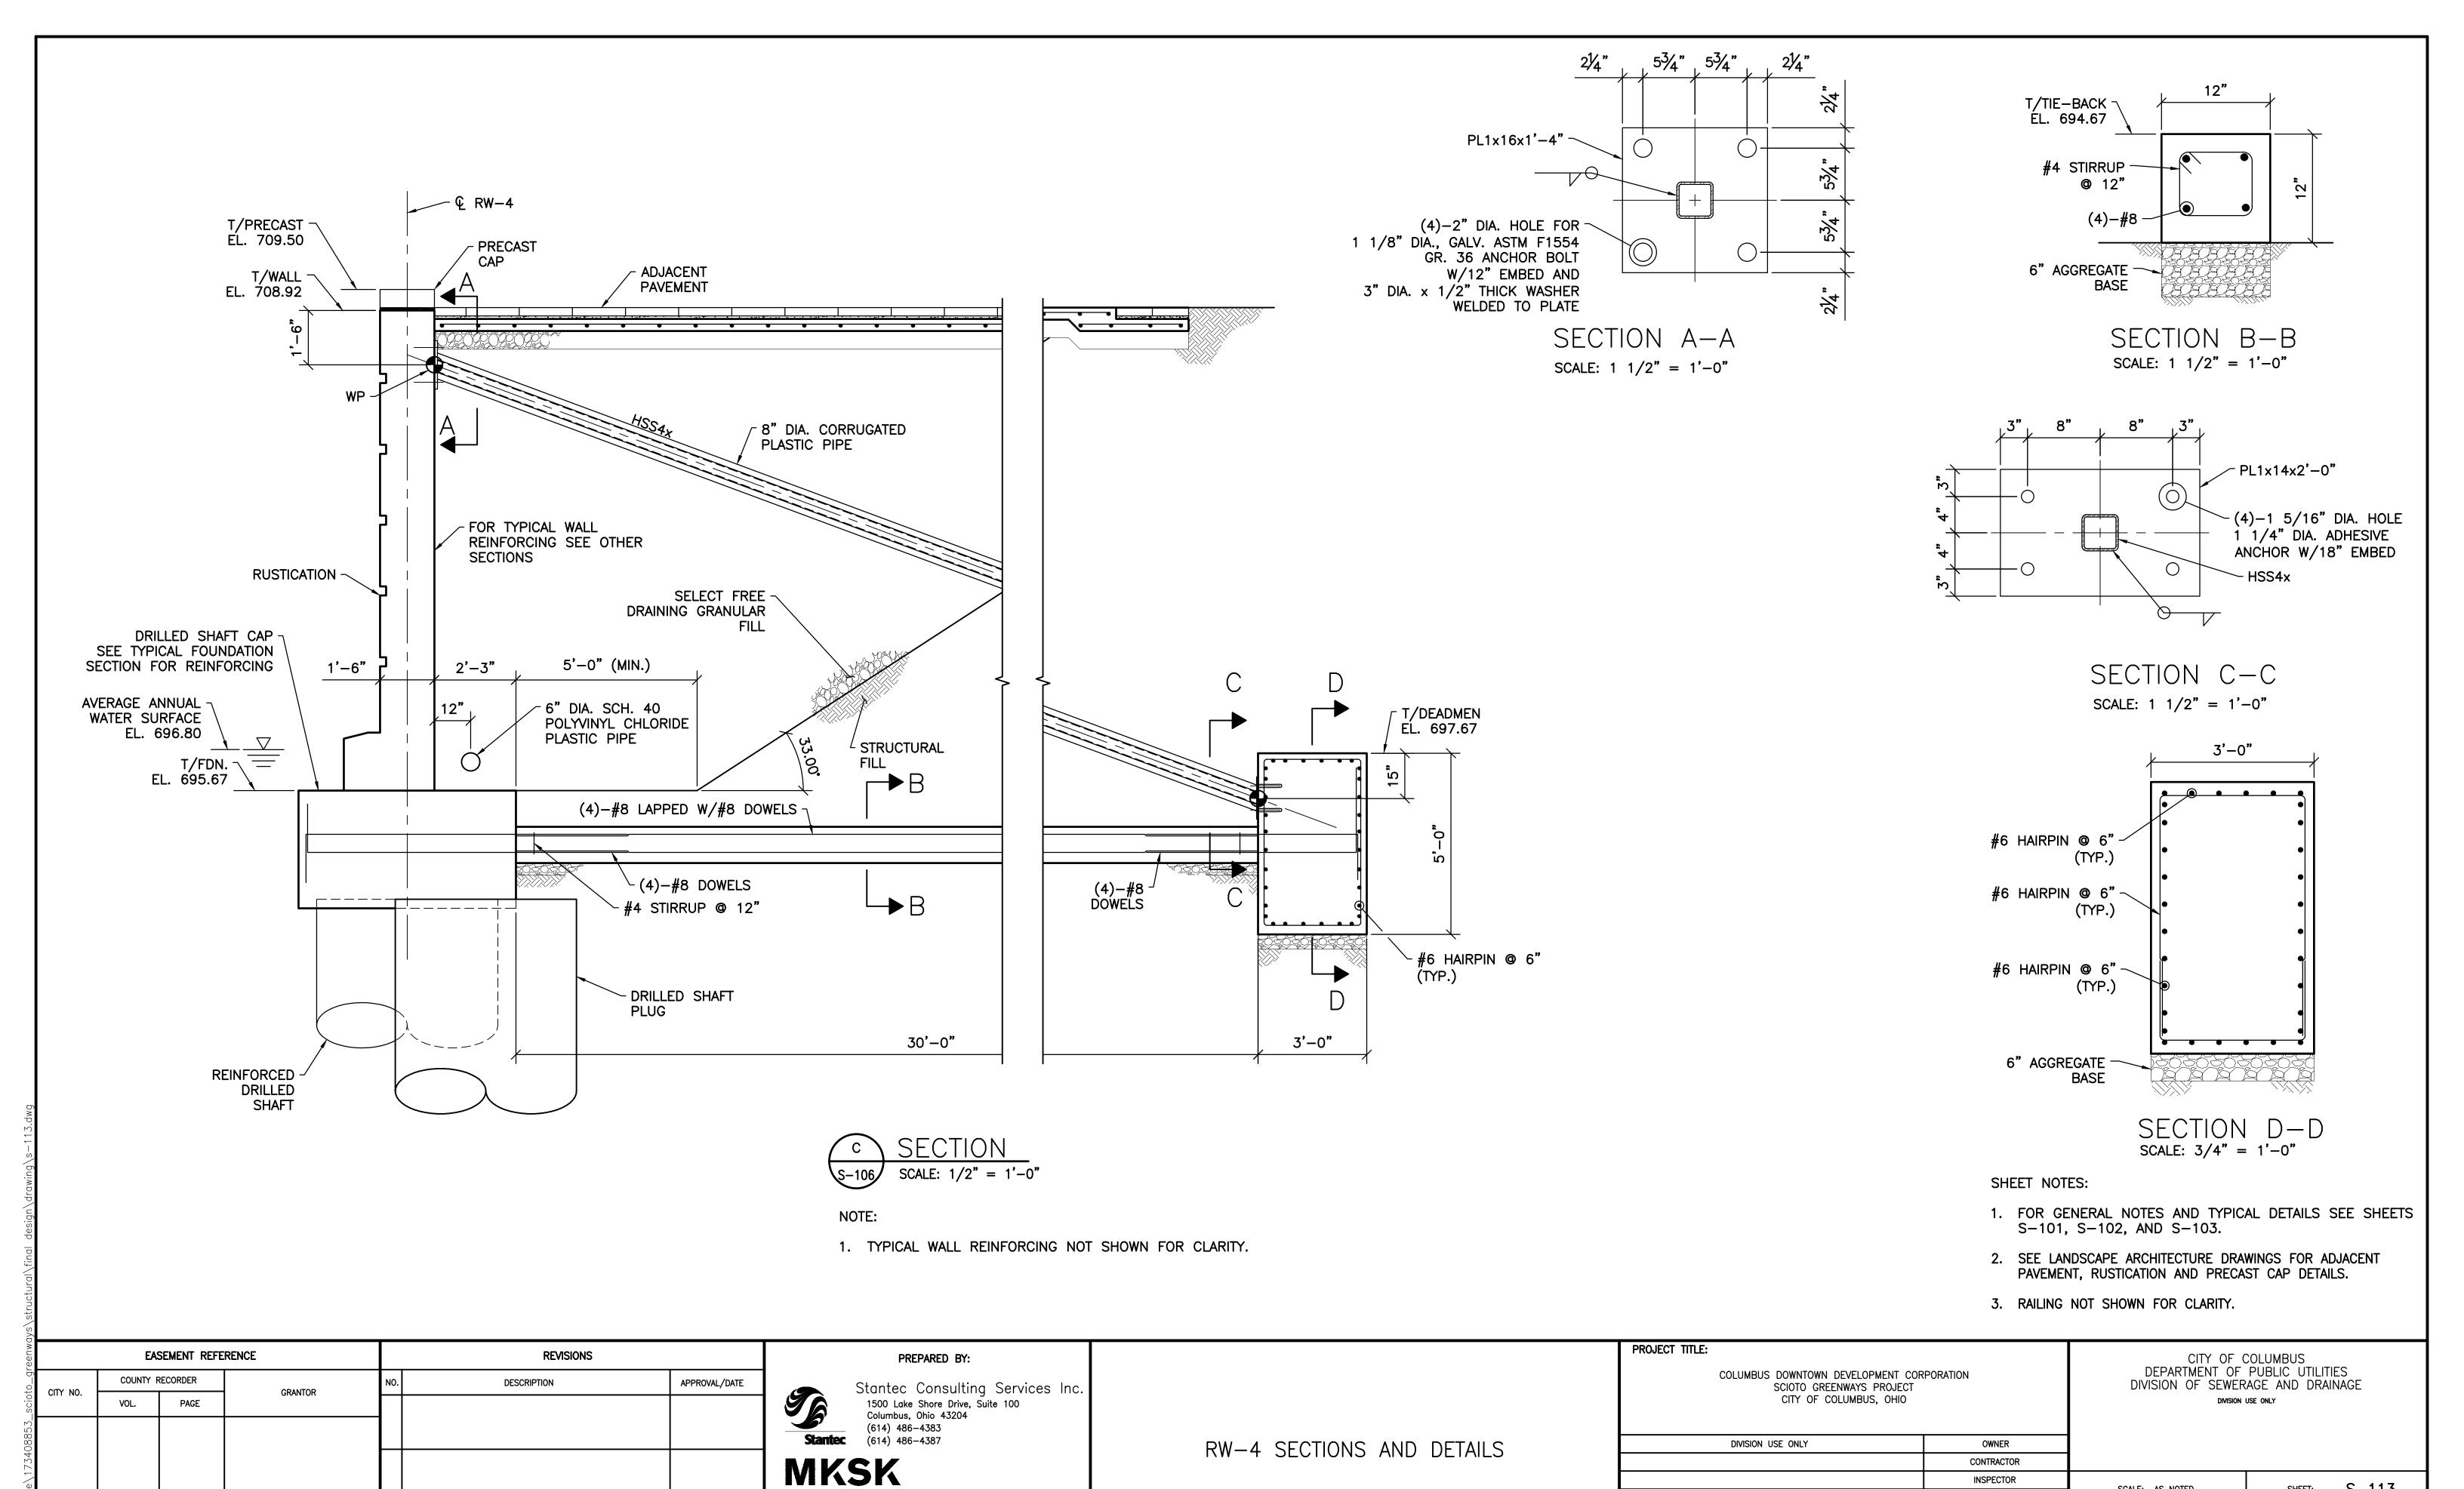

INSPECTOR

RPD CKD CLD CON. DR.

COMPLETED

RECORD FILE

AGREEMENT

INDEX DETAIL


SCALE: AS NOTED


CONTRACT DRAWING NO.

CC-16423

SHEET: S-113

RECORD PLAN NO.

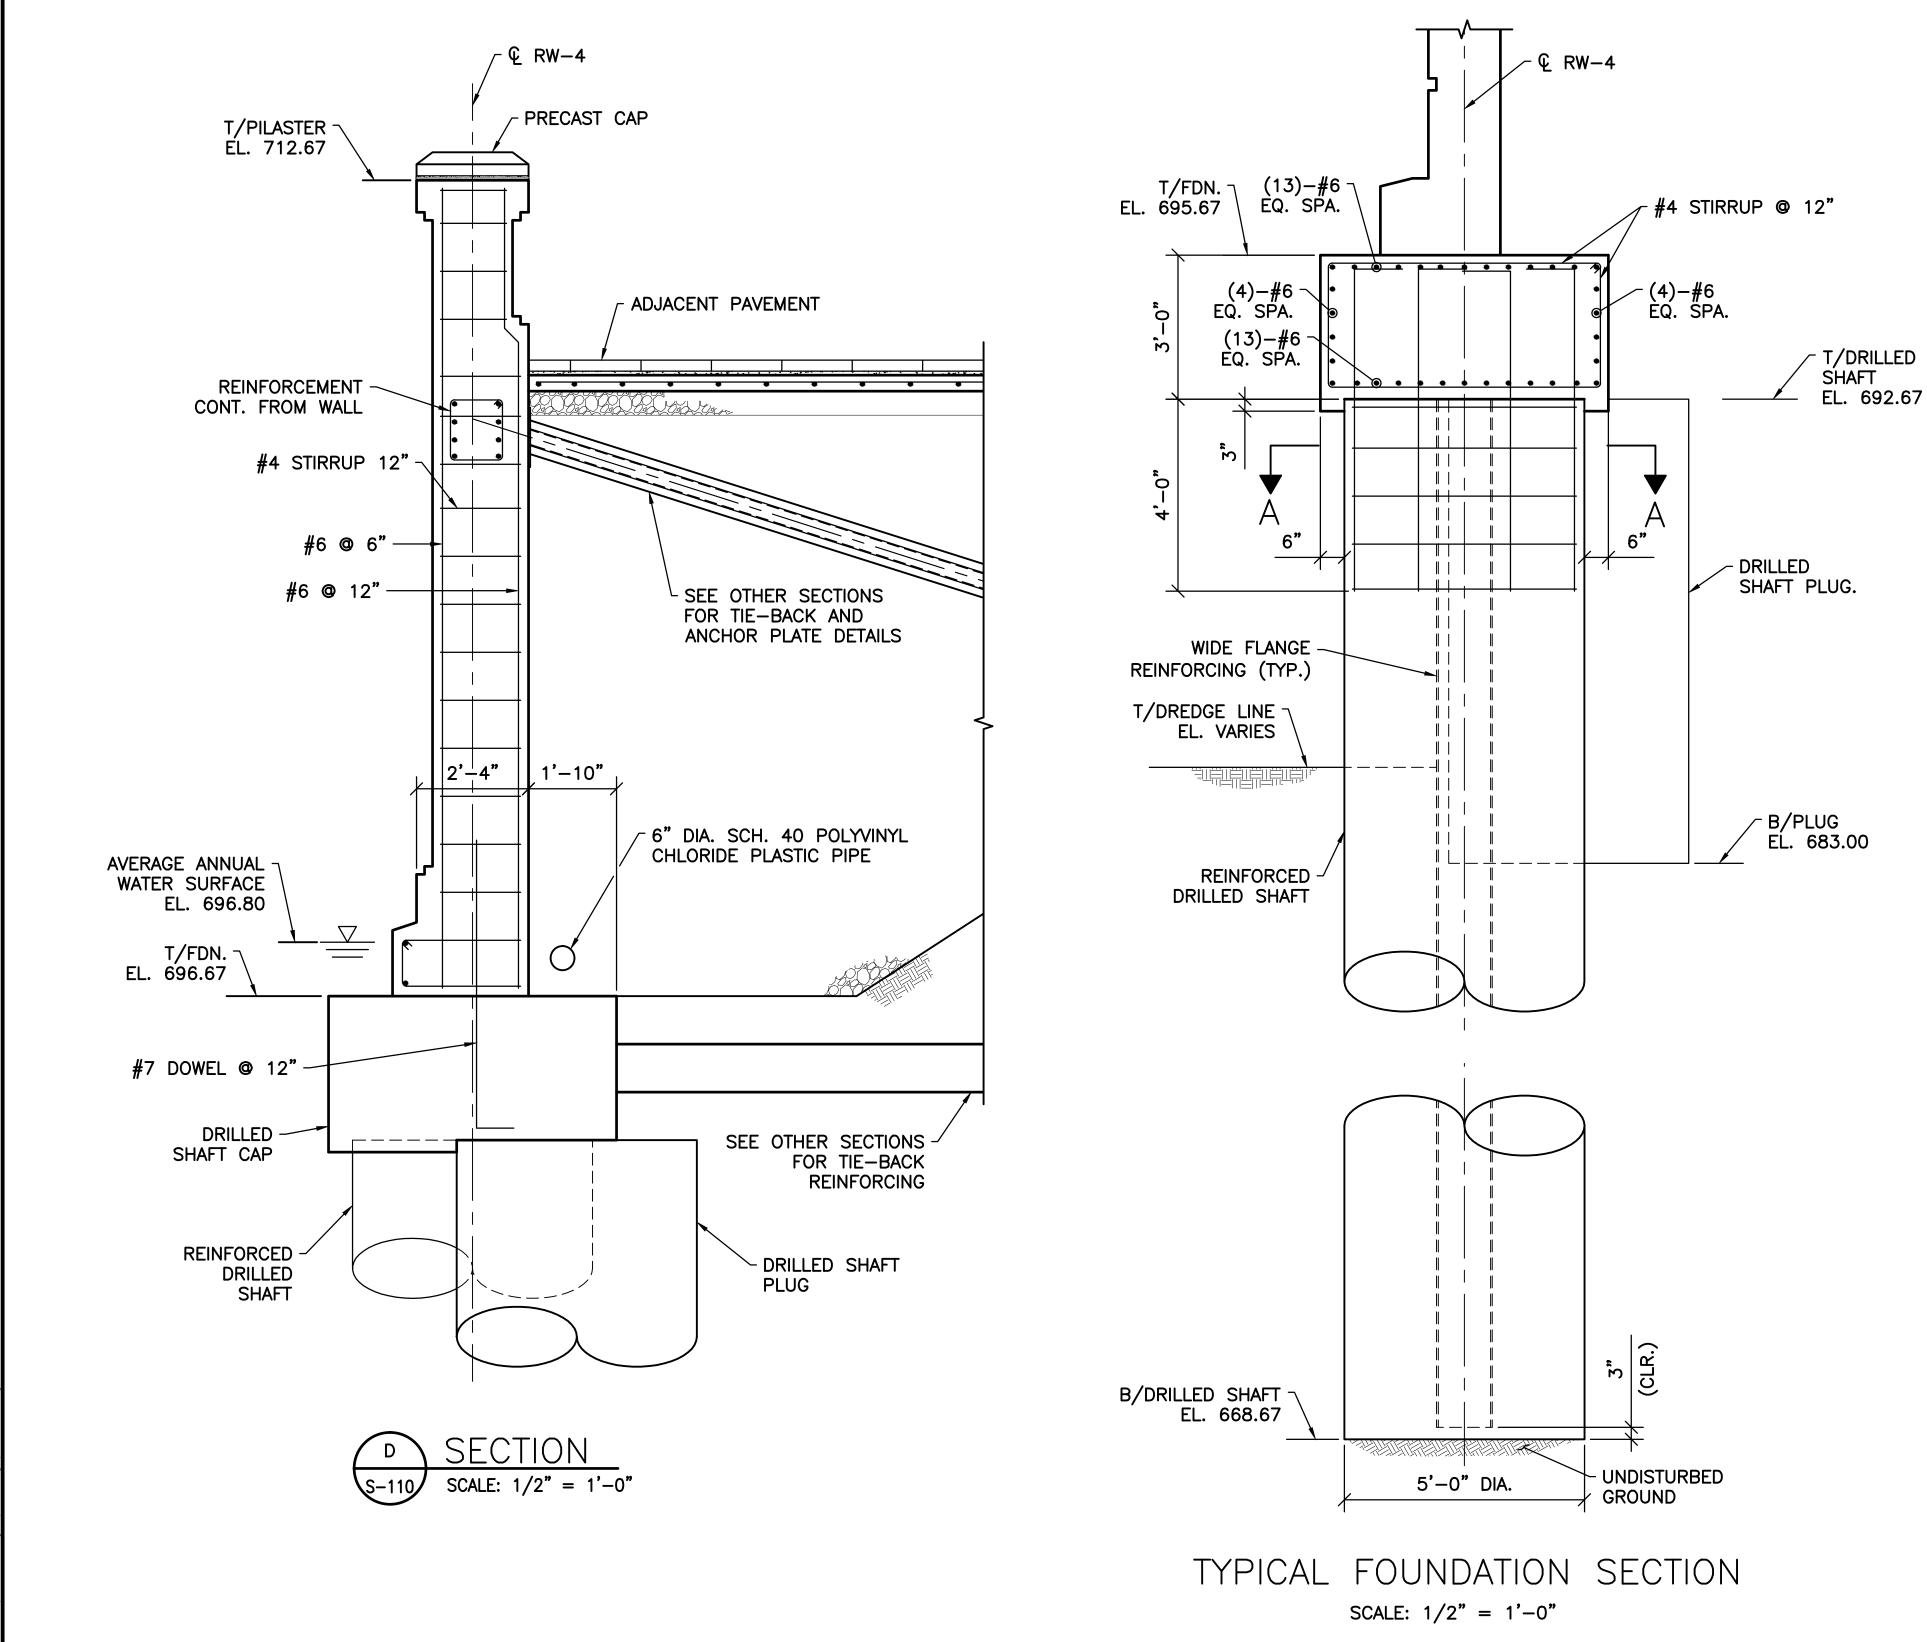

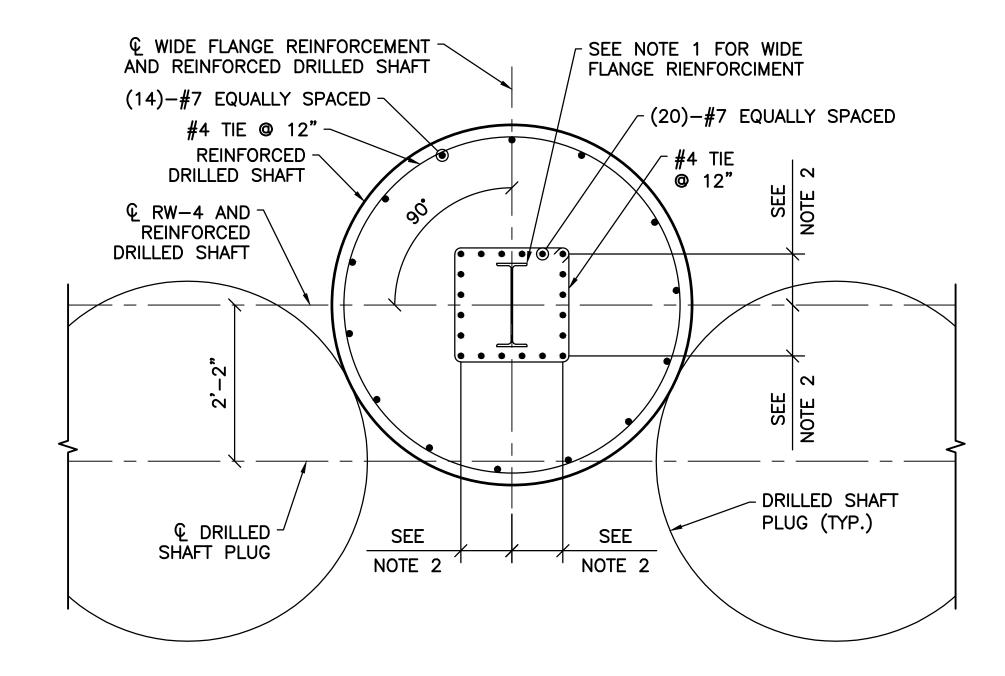

SECTION A-A SCALE: 3/4" = 1'-0"

NOTE:

- 1. WIDE FLANGE REINFORCING FOR REINFORCED DRILLED SHAFTS:
 -REINFORCED DRILLED SHAFTS 11 THRU 185 = W14x26
 -REINFORCED DRILLED SHAFTS 1,3,193, AND 195 = W21x55
- 2. DIMENSION TO INTERIOR REINFORCING:

 -REINFORCED DRILLED SHAFTS 11 THRU 185 = 8½


 -REINFORCED DRILLED SHAFTS 1,3,193 AND 195 = 11½


SHEET NOTES:

- 1. FOR GENERAL NOTES AND TYPICAL DETAILS SEE SHEETS S-101, S-102, AND S-103.
- 2. SEE LANDSCAPE ARCHITECTURE DRAWINGS FOR ADJACENT PAVEMENT, RUSTICATION AND PRECAST CAP DETAILS.

$\stackrel{\frown}{\frown}$												
eenwo		EASEMENT REFE	RENCE		REVISIONS		PREPARED BY:		PROJECT TITLE:		CITY OF	COLUMBUS
to_gı	CITY NO.	COUNTY RECORDER	GRANTOR	NO.	DESCRIPTION	APPROVAL/DATE	Stantec Consulting Services Inc.		COLUMBUS DOWNTOWN DEVELOPI SCIOTO GREENWAYS F	PROJECT	DEPARTMENT OF DIVISION OF SEWER	COLUMBUS PUBLIC UTILITIES RAGE AND DRAINAGE
scio		VOL. PAGE					1500 Lake Shore Drive, Suite 100 Columbus, Ohio 43204		CITY OF COLUMBUS	, OHIO	DMISION	USE ONLY
8853							(614) 486–4383 Stantec (614) 486–4387		DIVISION USE ONLY	OWNER		
7340							RAVCV	RW-4 SECTIONS 3		CONTRACTOR		
(e/1							MKSK			INSPECTOR	SCALE: AS NOTED	SHEET: S-114
activ							LANDSCAPE ARCHITECTURE + URBAN PLANNING			AGREEMENT COMPLETED		3-117
34/0										RPD CKD CLD CON. DR.	CONTRACT DRAWING NO.	RECORD PLAN NO.
:\173										INDEX RECORD DETAIL FILE	CC-16423	


.o_greenways\structural\final design\drawing\s-114.dwg

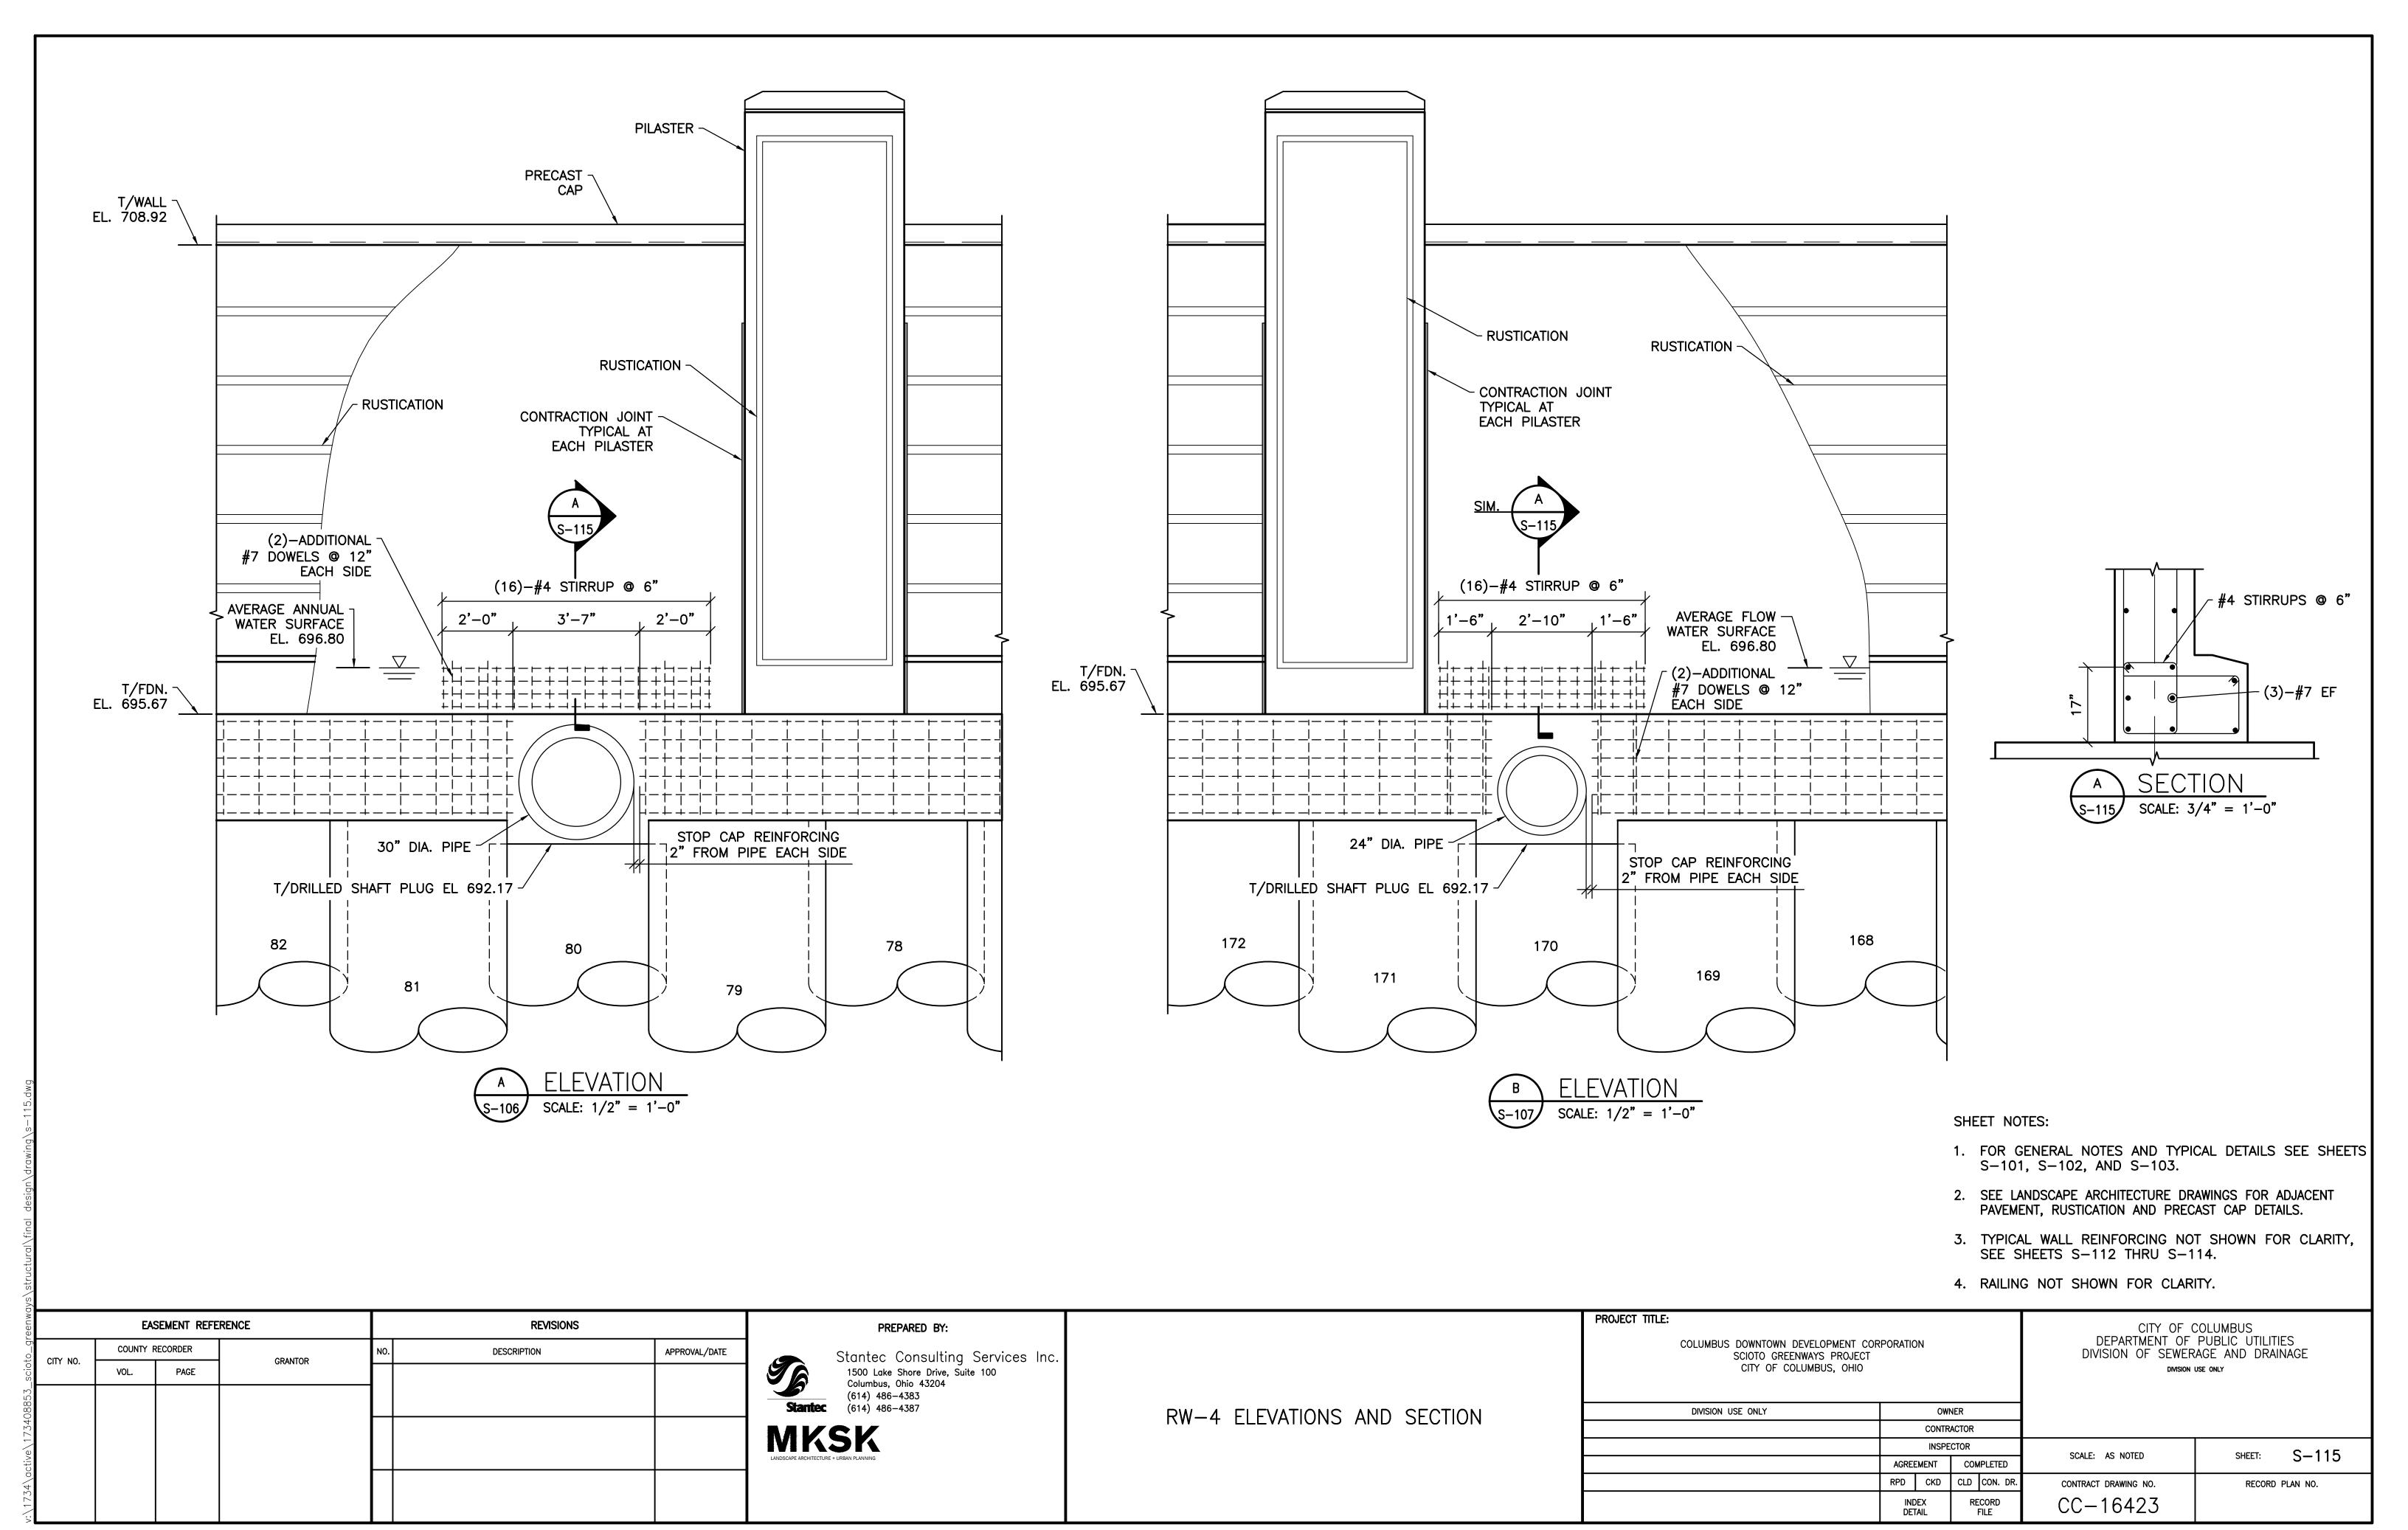

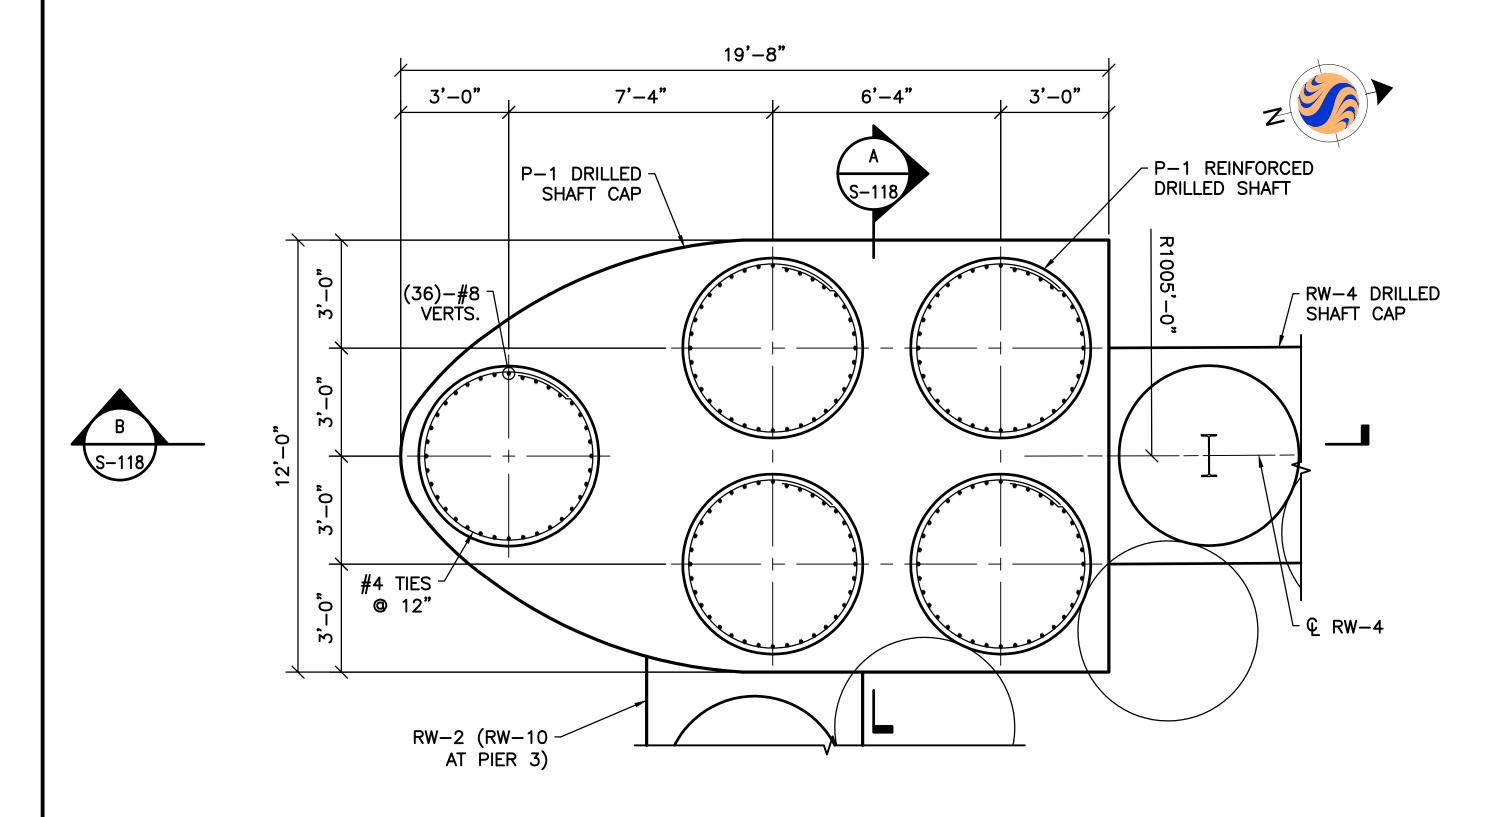

P-1 DRILLED SHAFT PLAN SCALE: 3/8" = 1'-0"

- 1. MAX. ALLOWABLE STRONG AXIS LATERAL CAPACITY OF REINFORCED DRILLED SHAFTS = XX TONS.
- 2. MAX. ALLOWABLE WEAK AXIS LATERAL CAPACITY OF REINFORCED DRILLED SHAFTS = XX TONS.
- 3. MAX. VERTICAL CAPACITY OF REINFORCED DRILLED SHAFTS

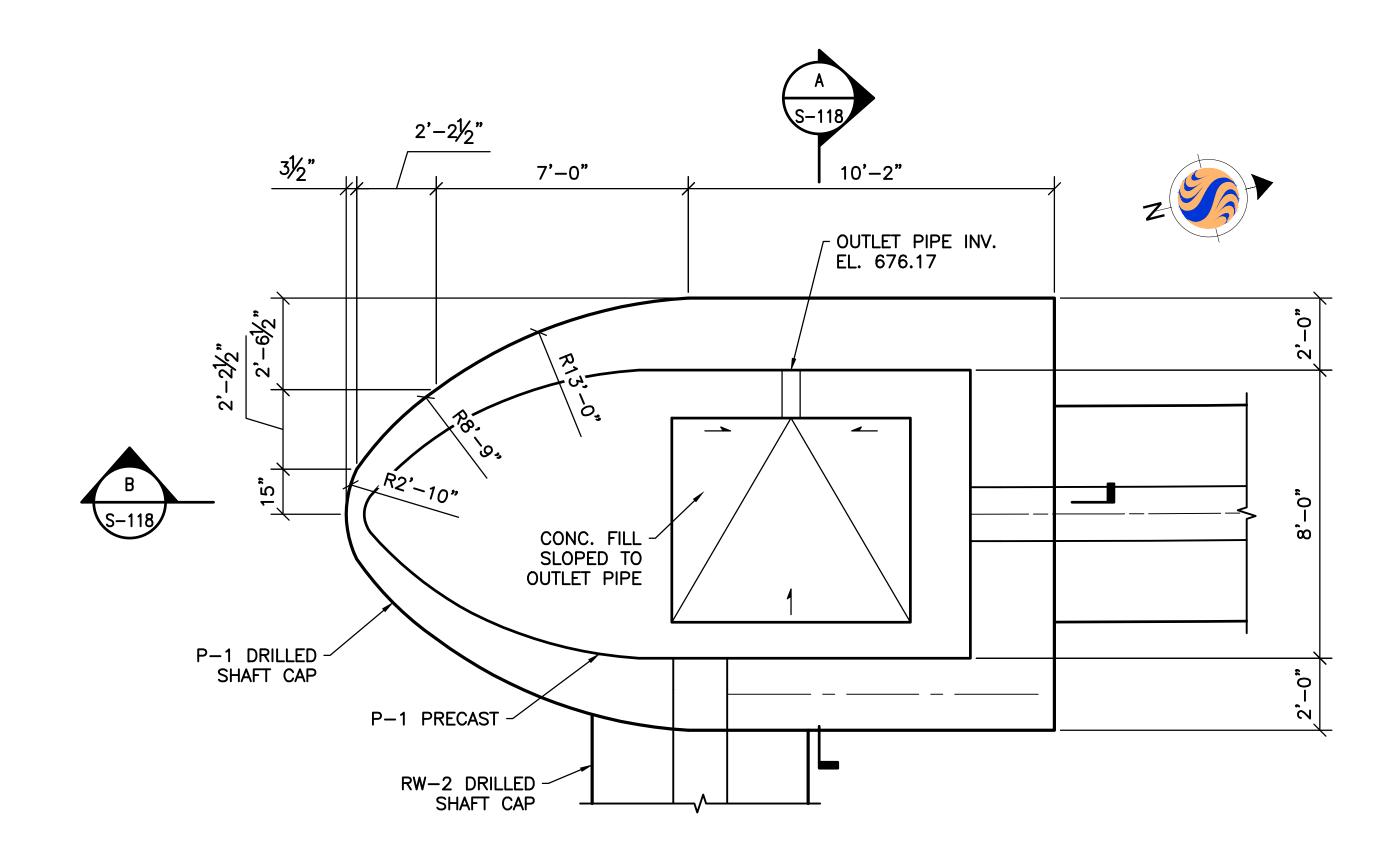

P-1 FOUNDATION PLAN

SCALE: 3/8" = 1'-0"


1. OUTLET PIPE TO BE 6" DIA. SCH. 40 POLYVINYL CHLORIDE SOLID WALL PIPE.


SHEET NOTES:

- 1. FOR GENERAL NOTES AND TYPICAL DETAILS SEE SHEETS S-101, S-102, AND S-103.
- 2. P-3 OPPOSITE HAND.

reenw		EAS	SEMENT REFE	RENCE		REVISIONS		PREPARED BY:	
to_gr	CITY NO.	COUNTY R	ECORDER	GRANTOR	NO.	DESCRIPTION	APPROVAL/DATE	Stantec Consulting Services Inc.	
SCIO	CITT NO.	VOL.	PAGE	GIANTON				1500 Lake Shore Drive, Suite 100 Columbus, Ohio 43204	
8853								(614) 486–4383 Stantec (614) 486–4387	P-1 AND $P-3$ DRILLED SHAFT AND FOUNDATION
7340								MKSK	PLANS
tive\1								LANDSCAPE ARCHITECTURE + URBAN PLANNING	
4\ac.									
173									

PROJECT TITLE: COLUMBUS DOWNTOWN DEVELOPMENT COP SCIOTO GREENWAYS PROJECT CITY OF COLUMBUS, OHIO	RPORATIO	DN			DEPARTMENT OF DIVISION OF SEWER	COLUMBUS PUBLIC UTILITIES PAGE AND DRAINAGE USE ONLY
DIVISION USE ONLY		OWI	NER			
		CONTR	ACTOR			
		INSPE	CTOR		SCALE: AS NOTED	SHEET: S-116
	AGRE	EMENT	COM	/PLETED	SCALE: AS NOTED	3-110
	RPD	CKD	CLD	CON. DR.	CONTRACT DRAWING NO.	RECORD PLAN NO.
	INE DET	DEX FAIL		CORD FILE	CC-16423	

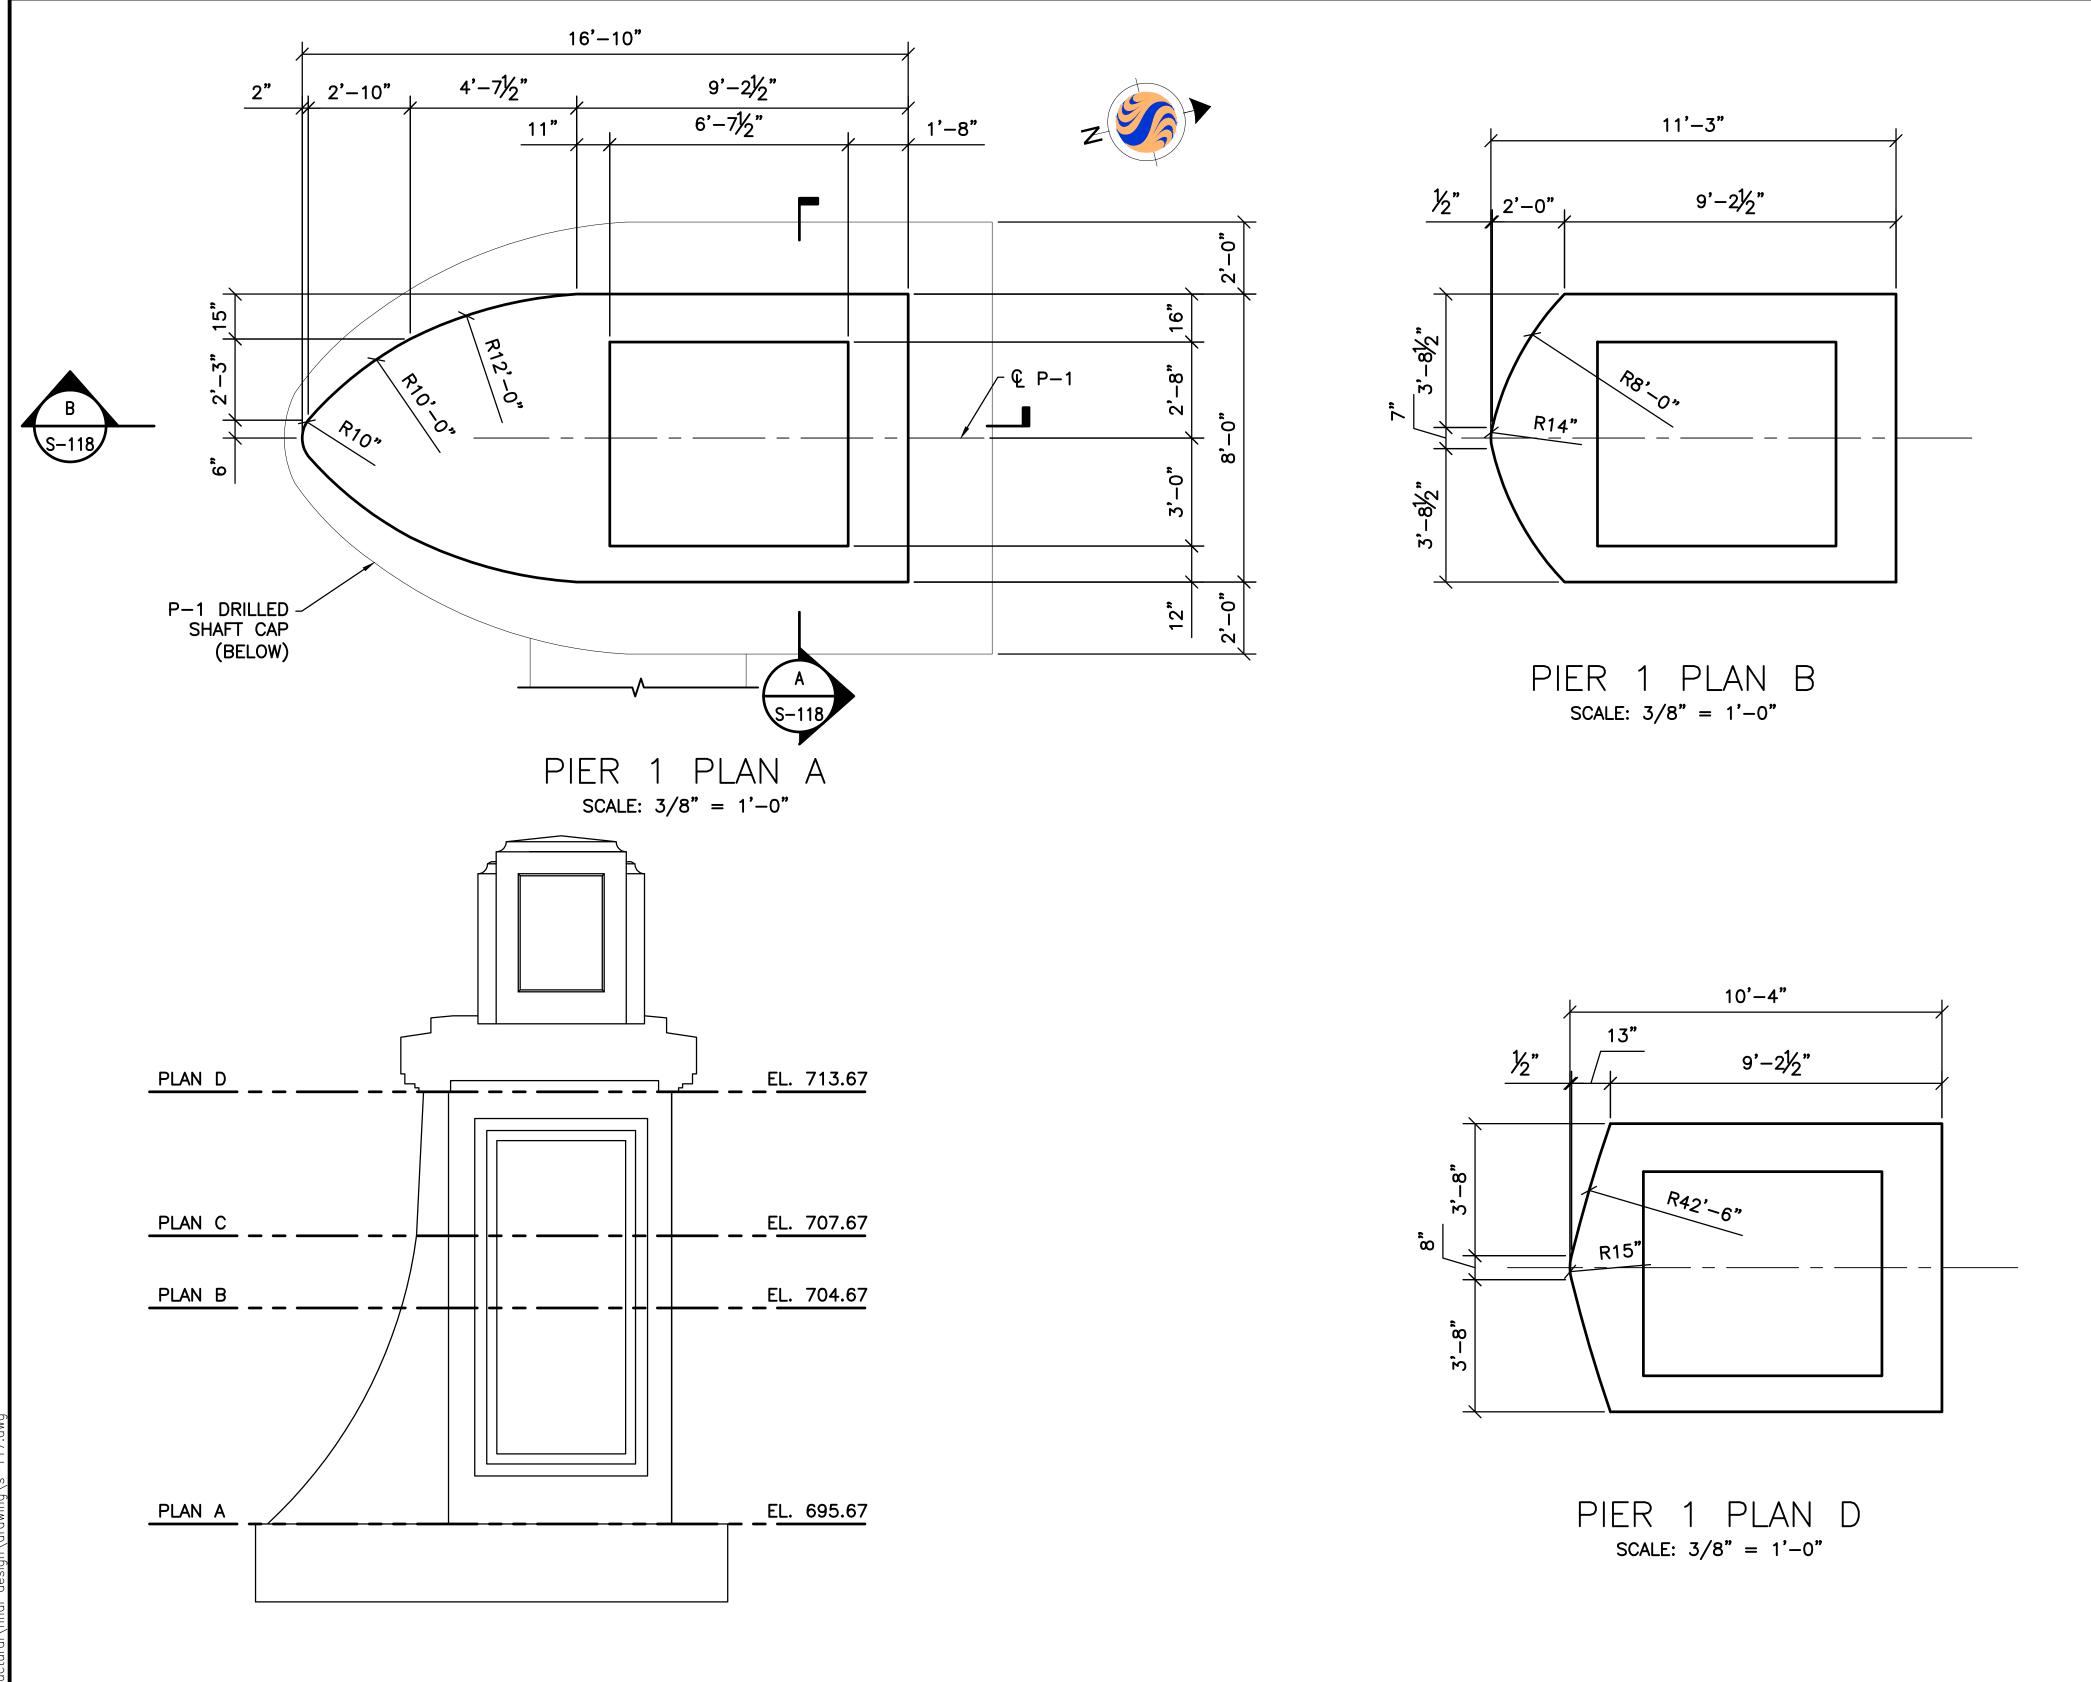

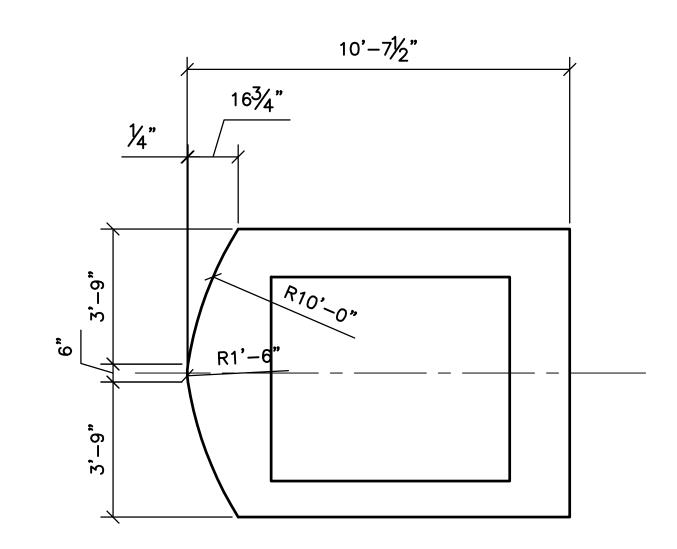


PIER 1 PLAN C scale: 3/8" = 1'-0"


SHEET NOTES:


- 1. FOR GENERAL NOTES AND TYPICAL DETAILS SEE SHEETS S-101, S-102, AND S-103.
- 2. P-3 OPPOSITE HAND.
- 3. RW-2 AND RW-4 NOT SHOWN FOR CLARITY.


геепжа	EAS	SEMENT REFERENCE		REVISIONS		PREPARED BY:		PROJECT TITLE:			CITY OF CO DEPARTMENT OF F	DLUMBUS
city No.	COUNTY R	RECORDER GRANTOR	NO.	DESCRIPTION	APPROVAL/DATE	Stantec Consulting Services Inc.		COLUMBUS DOWNTOWN DEVEL SCIOTO GREENWAY	S PROJECT		DIVISION OF SEWERA	GE AND DRAINAGE
0.000	VOL.	PAGE				1500 Lake Shore Drive, Suite 100 Columbus, Ohio 43204		CITY OF COLUME	BUS, OHIO		DIVISION US	E ONLY
38853						(614) 486–4383 Stantec (614) 486–4387	D 1 AND D 3 WALL DLANC	DIVISION USE ONLY	OWNER			
734(MAVCV	P-1 AND P-3 WALL PLANS		CONTRACTOR			
(e)						MKSK			INSPECTOR		SCALE: AS NOTED	SHEET: S-117
activ						LANDSCAPE ARCHITECTURE + URBAN PLANNING			AGREEMENT CO	MPLETED	SOALE. AS NOTED	3-117
04/0									RPD CKD CLD	CON. DR.	CONTRACT DRAWING NO.	RECORD PLAN NO.
V:\173									INDEX R DETAIL	ECORD FILE	CC-16423	


lesign\drawing\s-117.dwg

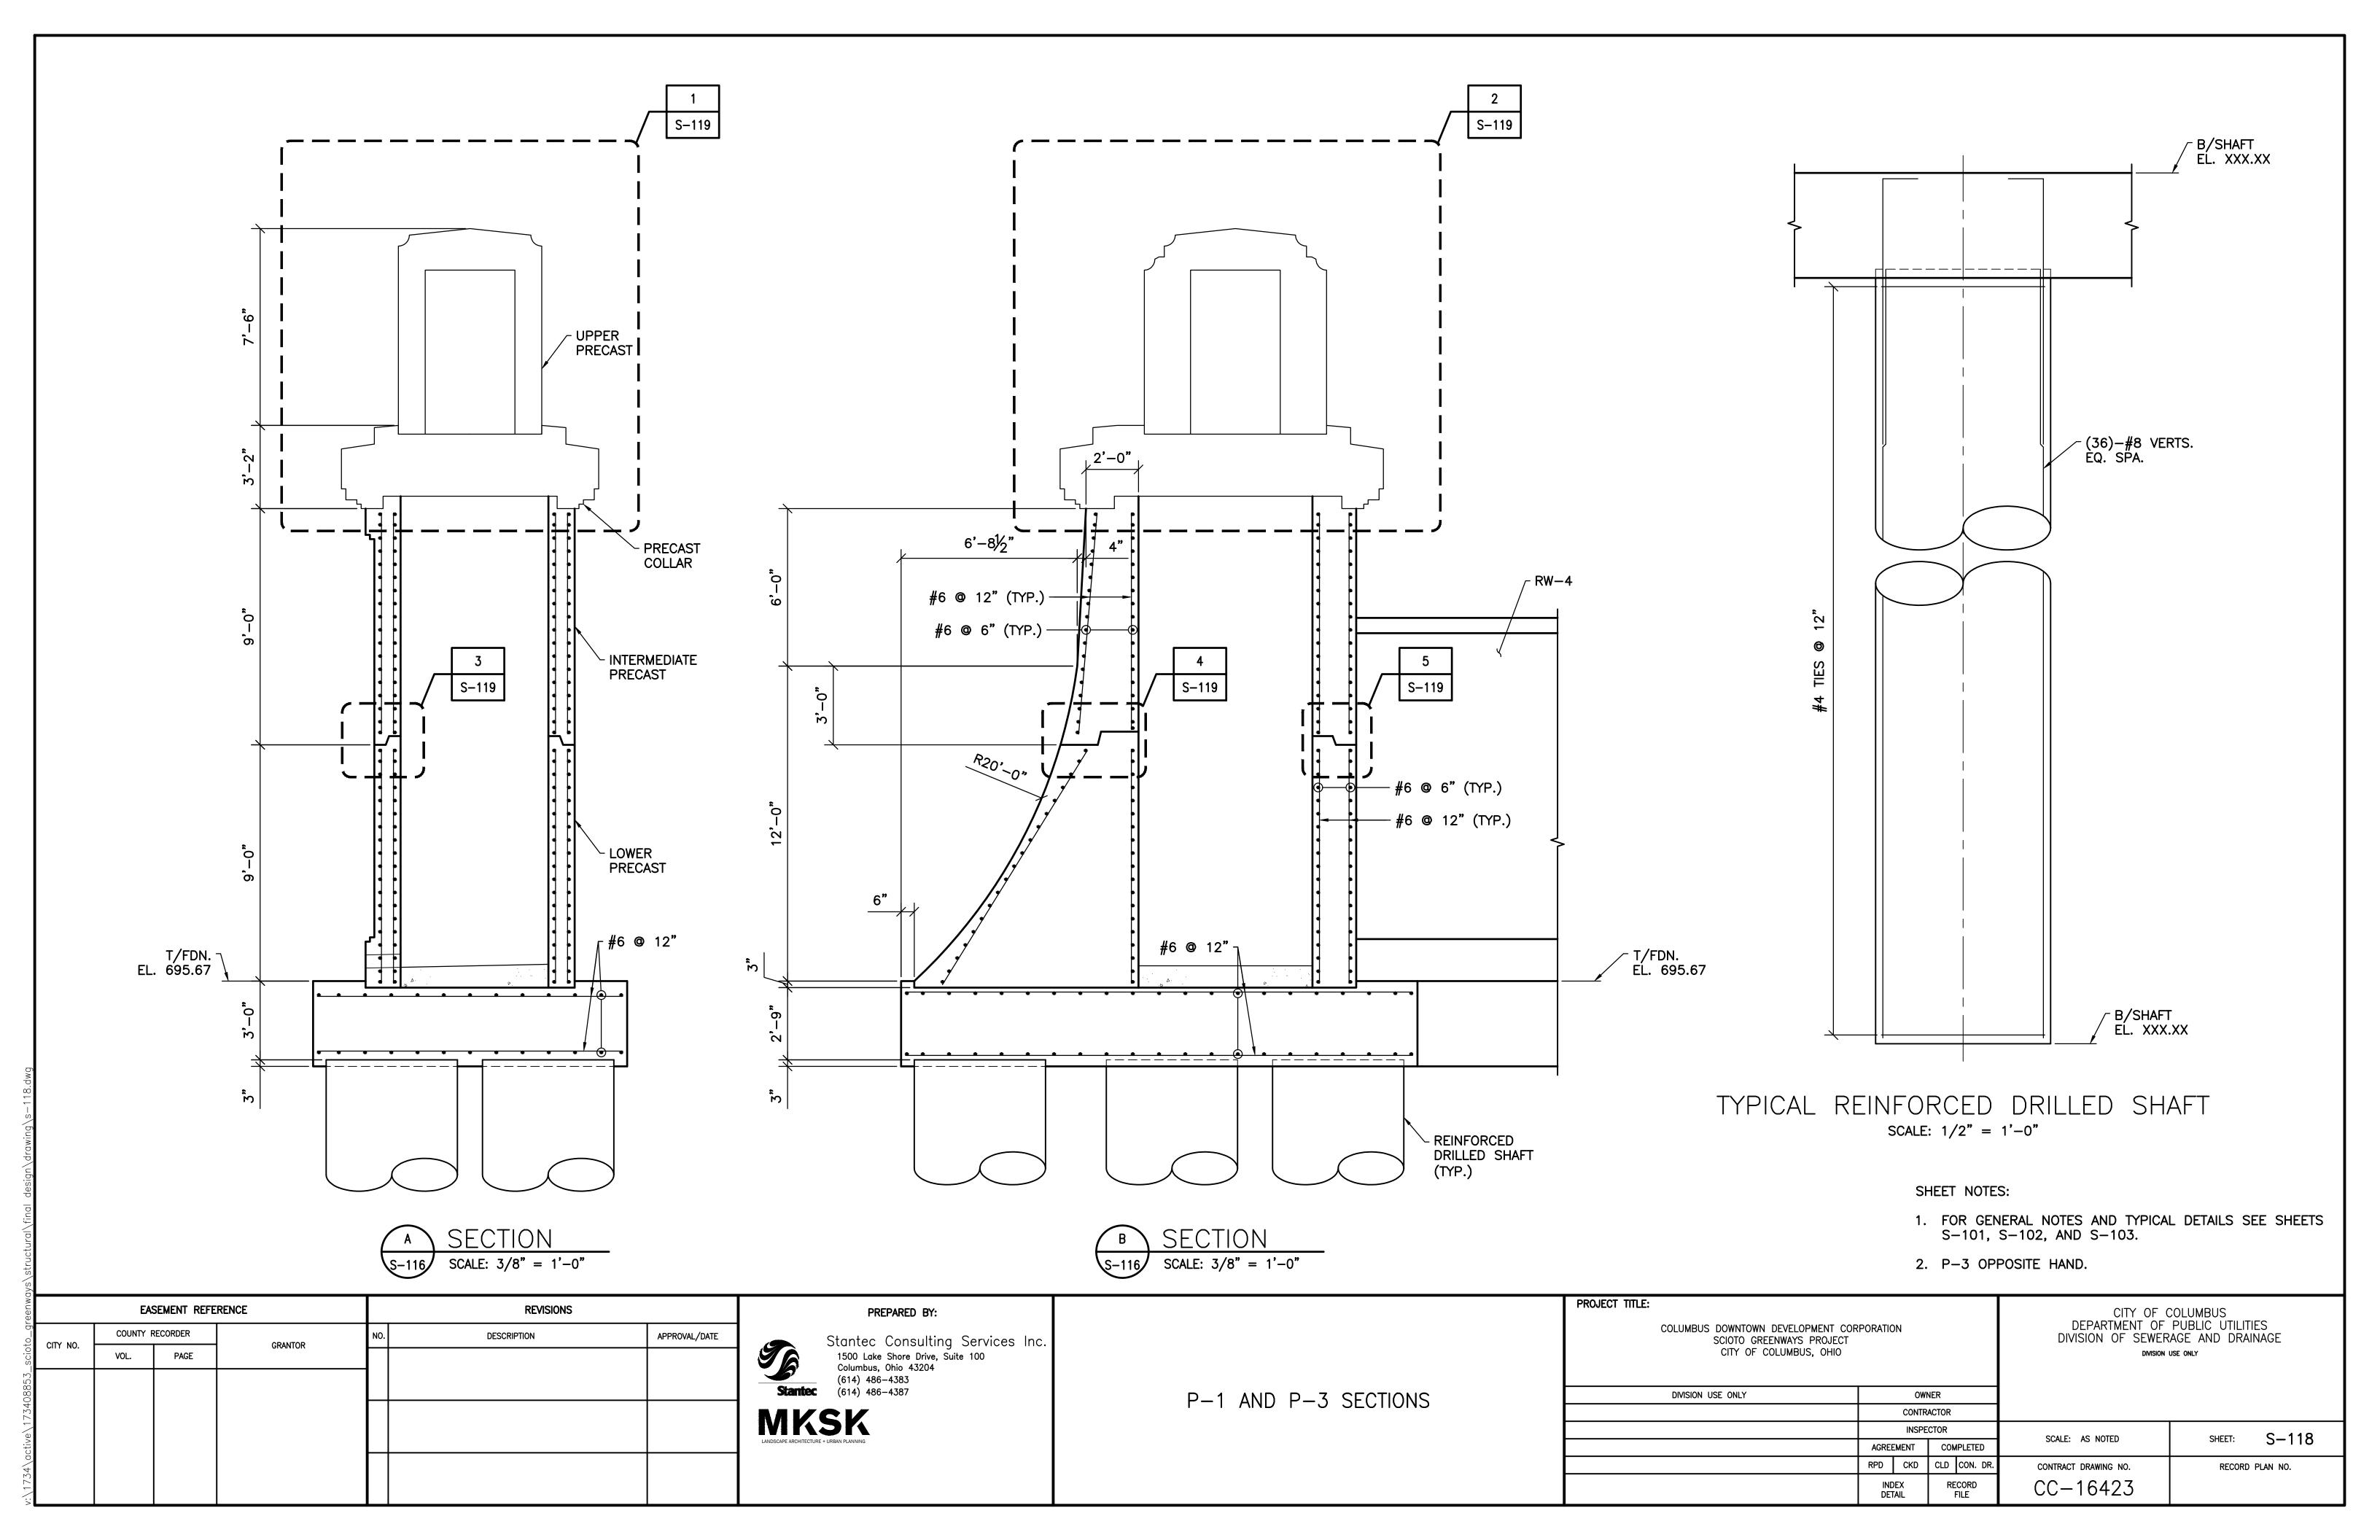


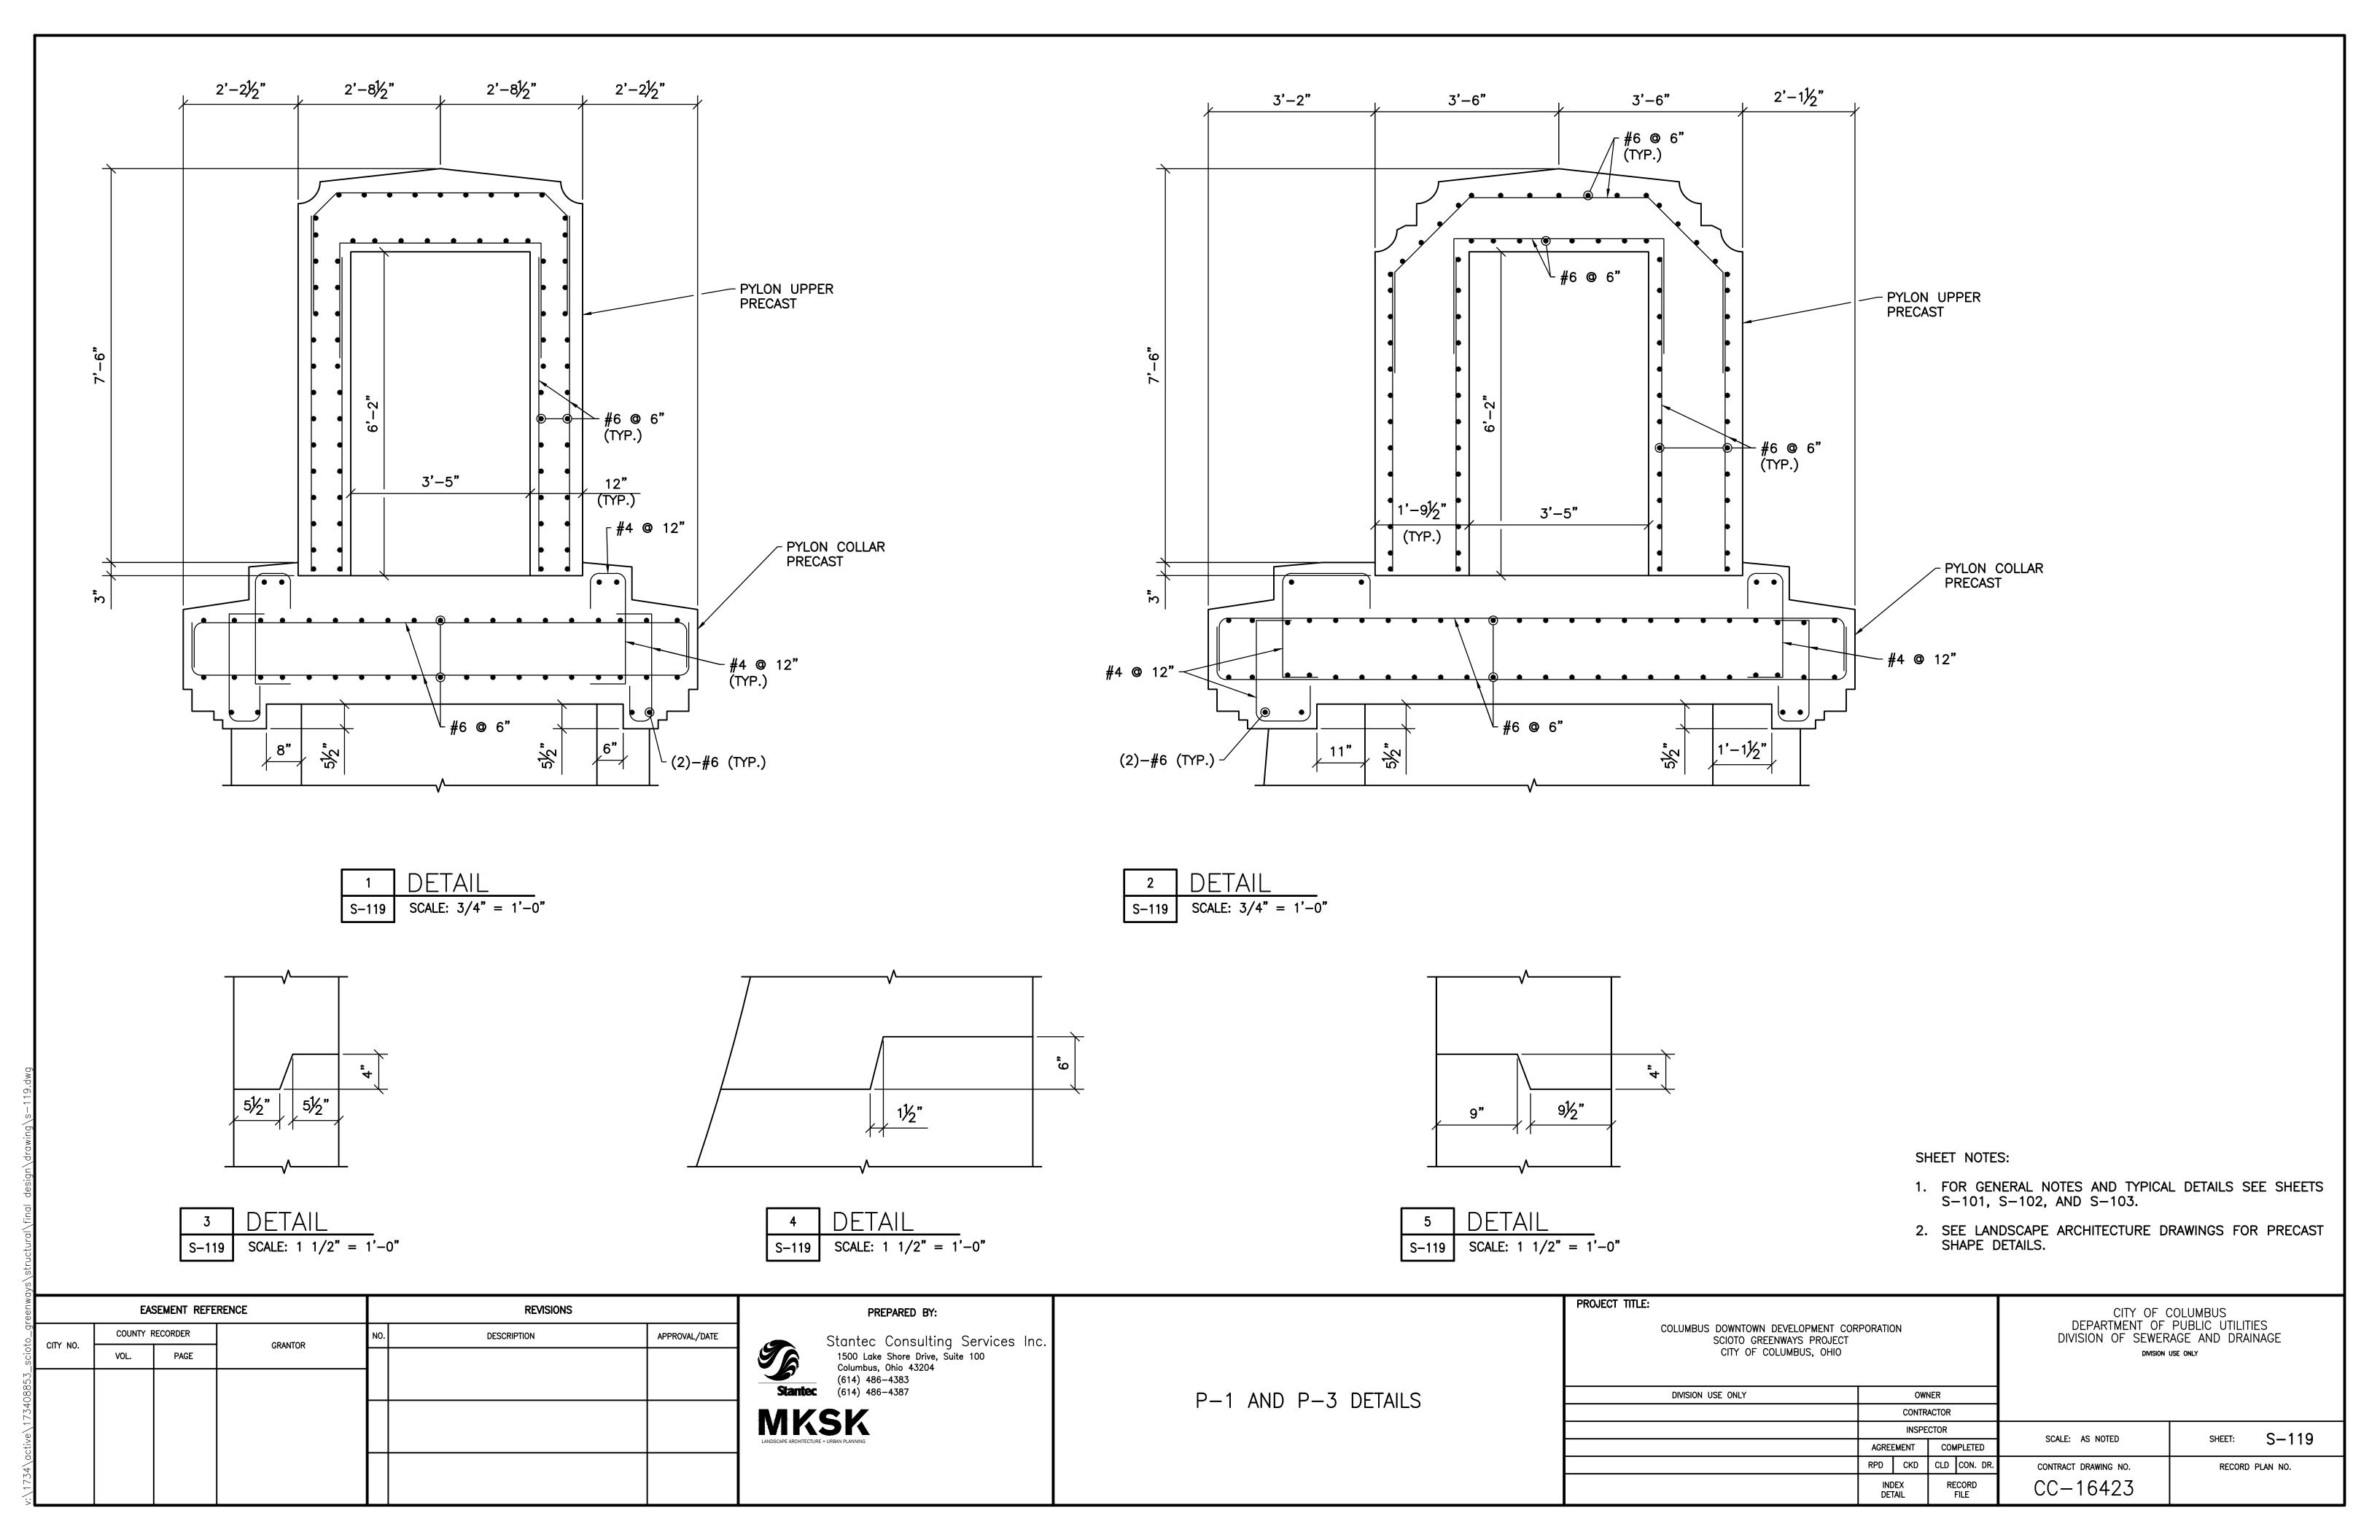

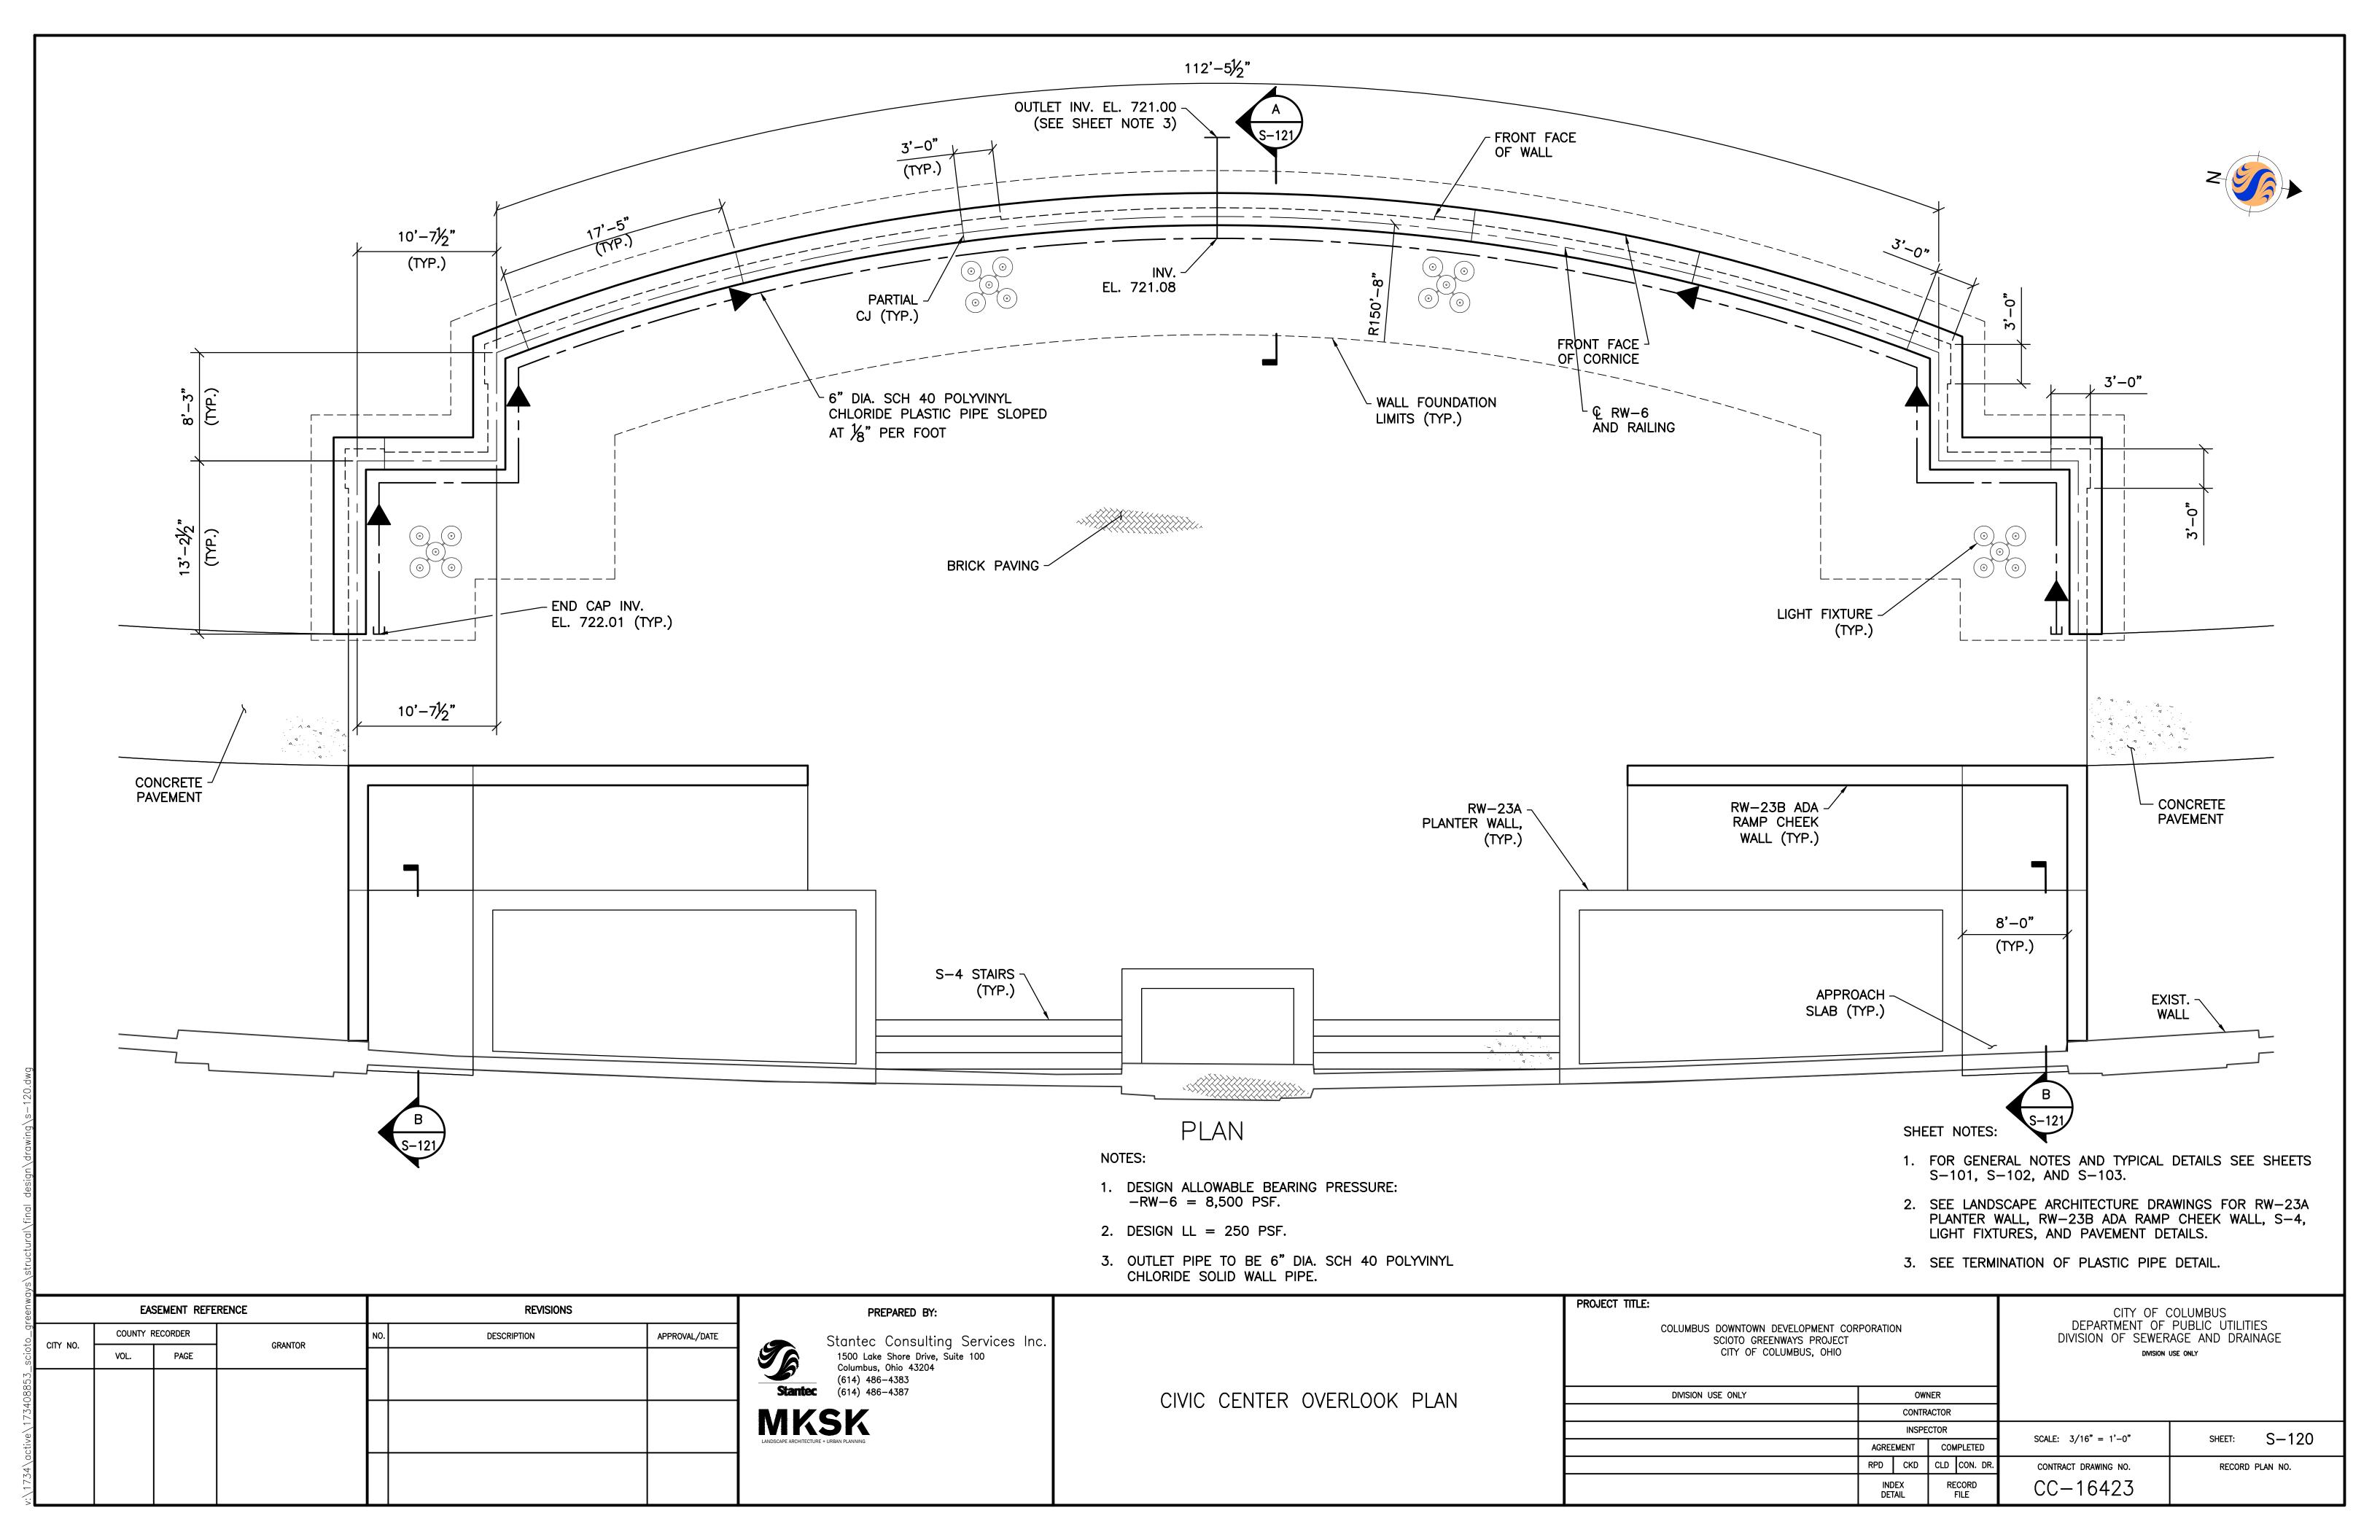

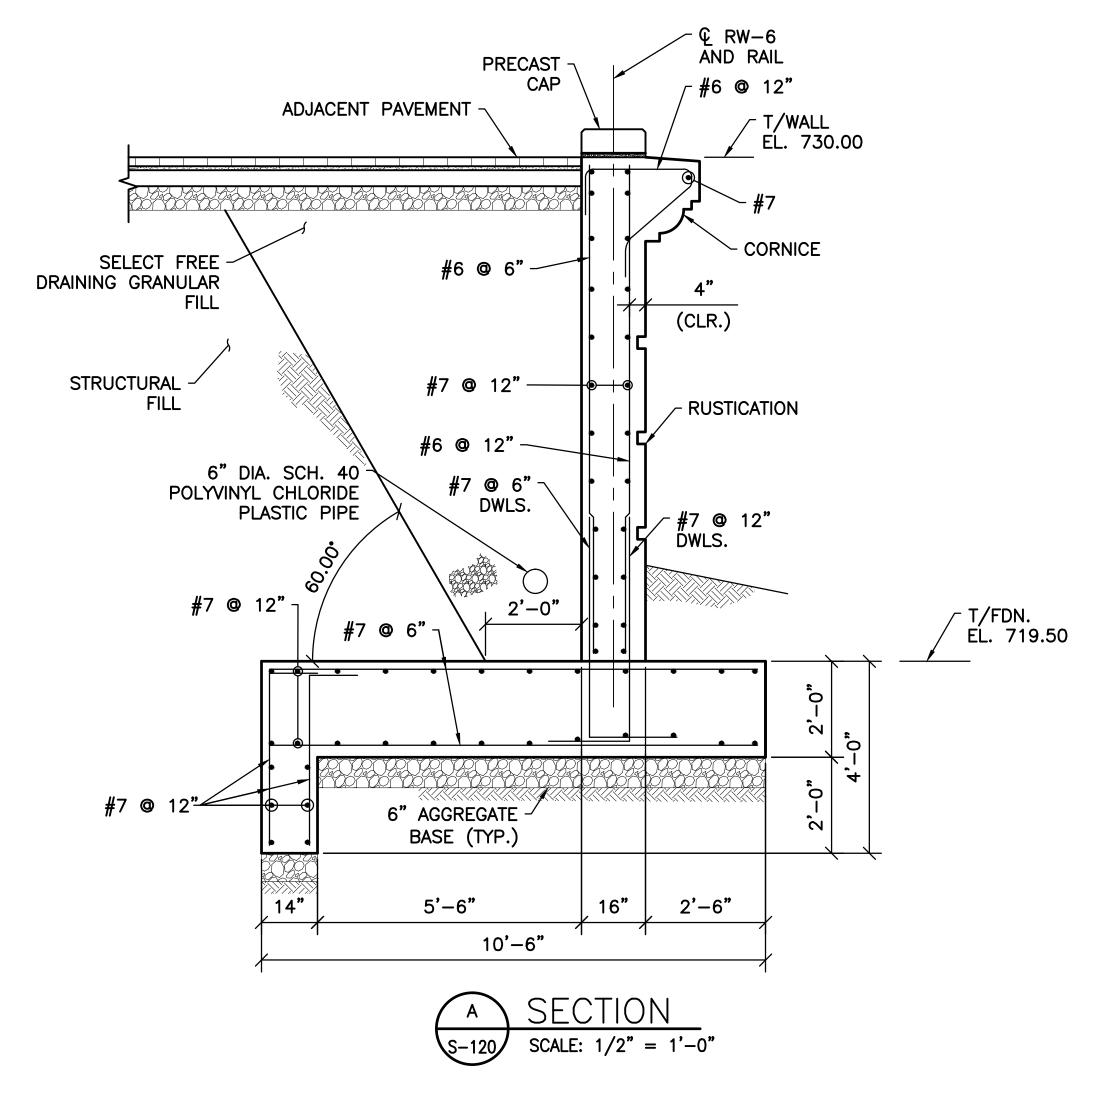

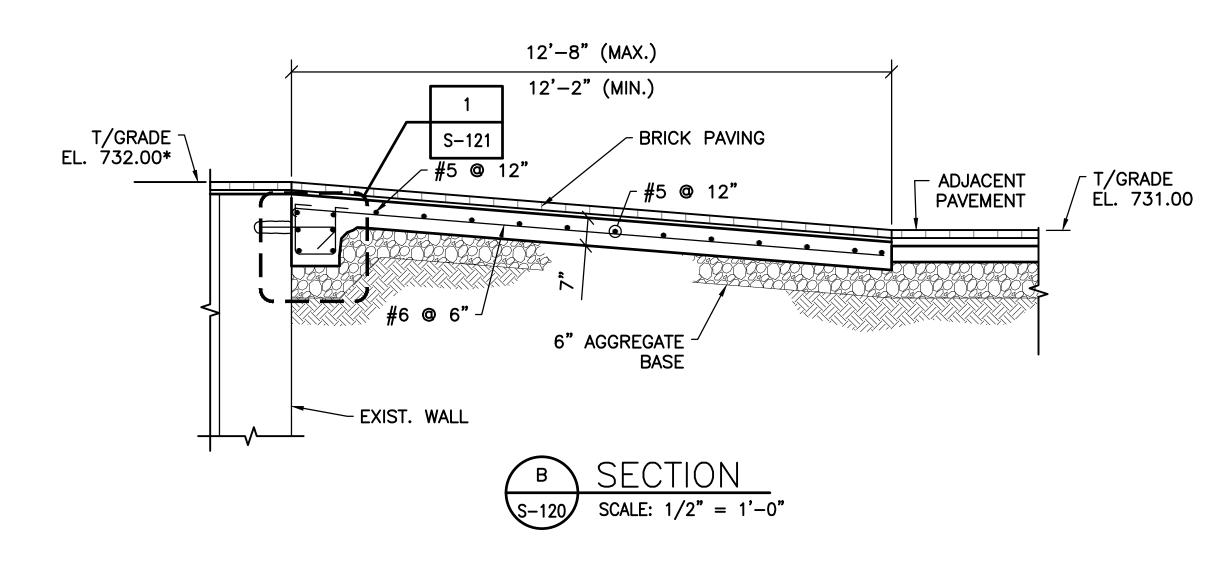

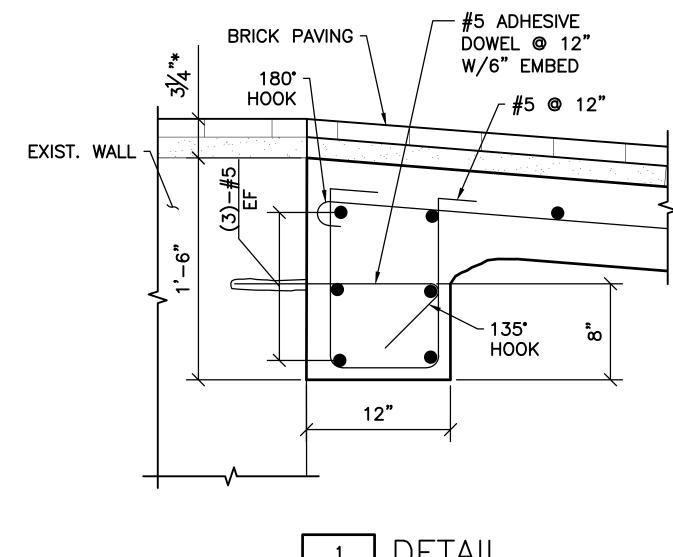

NOTE:

1. RAILING NOT SHOWN FOR CLARITY.

SHEET NOTES:


1. FOR GENERAL NOTES AND TYPICAL DETAILS SEE SHEETS S-101, S-102, AND S-103.


S-121 SCALE: $1 \frac{1}{2} = 1'-0"$


2. SEE LANDSCAPE ARCHITECTURE DRAWINGS FOR RUSTICATION, CORNICE, PRECAST CAP, AND PAVEMENT DETAILS.

3									DET/ (IEO:		
	EA	SEMENT REFERENC)E	REVISIONS		PREPARED BY:		PROJECT TITLE:		CITY OF C DEPARTMENT OF	OLUMBUS
CITY NO.	COUNTY	RECORDER	GRANTOR	NO. DESCRIPTION	APPROVAL/DATE	Stantec Consulting Services Inc.		COLUMBUS DOWNTOWN DEVELOPM SCIOTO GREENWAYS F	ROJECT	DIVISION OF SEWERA	AGE AND DRAINAGE
SCIO	VOL.	PAGE				1500 Lake Shore Drive, Suite 100 Columbus, Ohio 43204		CITY OF COLUMBUS,	OHIO	DMISION U	SE ONLY
2822						(614) 486–4383 Stantec (614) 486–4387			01111150		
) - -						(017) 400 4007	CIVIC CENTER OVERLOOK SECTIONS AND DETAIL	DIVISION USE ONLY	OWNER		
70/						MKSK			CONTRACTOR		
บ									INSPECTOR	SCALE: AS NOTED	SHEET: S-121
						LANDSCAPE ARCHITECTURE + URBAN PLANNING			AGREEMENT COMPLETED	SCALE. AS NOTED	3-121
94 \ 0									RPD CKD CLD CON. DR.	CONTRACT DRAWING NO.	RECORD PLAN NO.
									INDEX RECORD DETAIL FILE	CC-16423	


73408853 crists arecommens of resolutions final decises drawing 121 dws

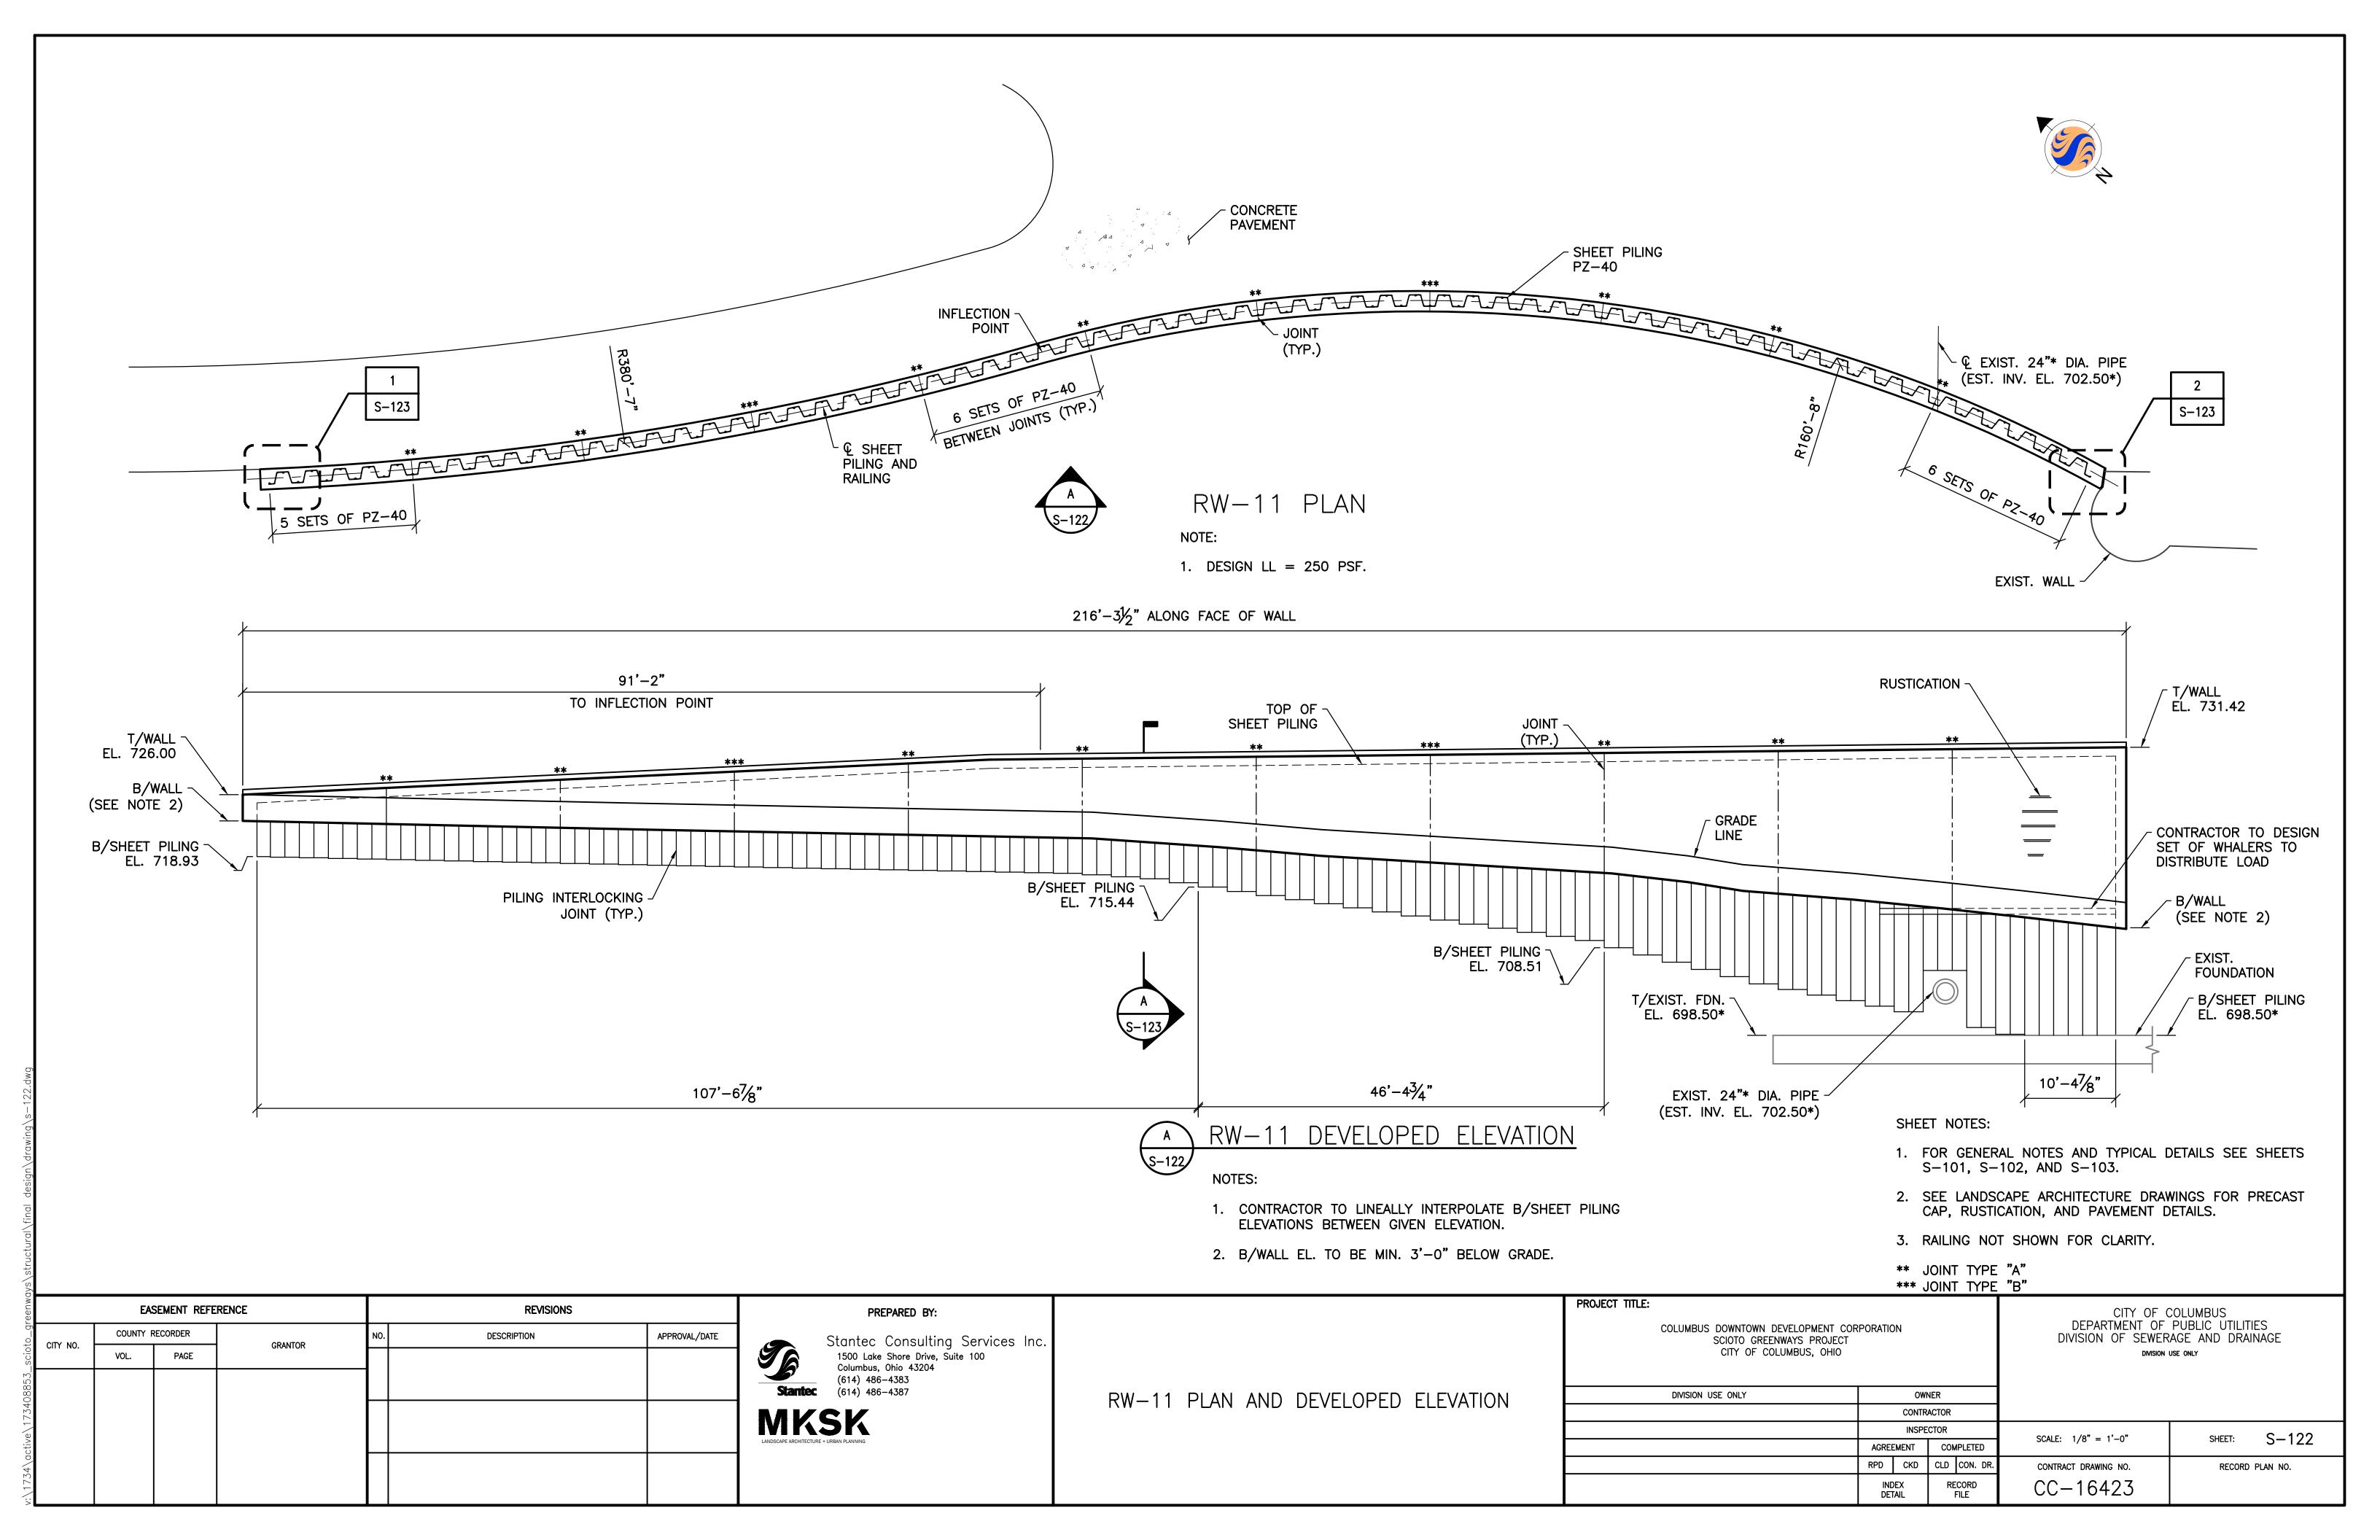

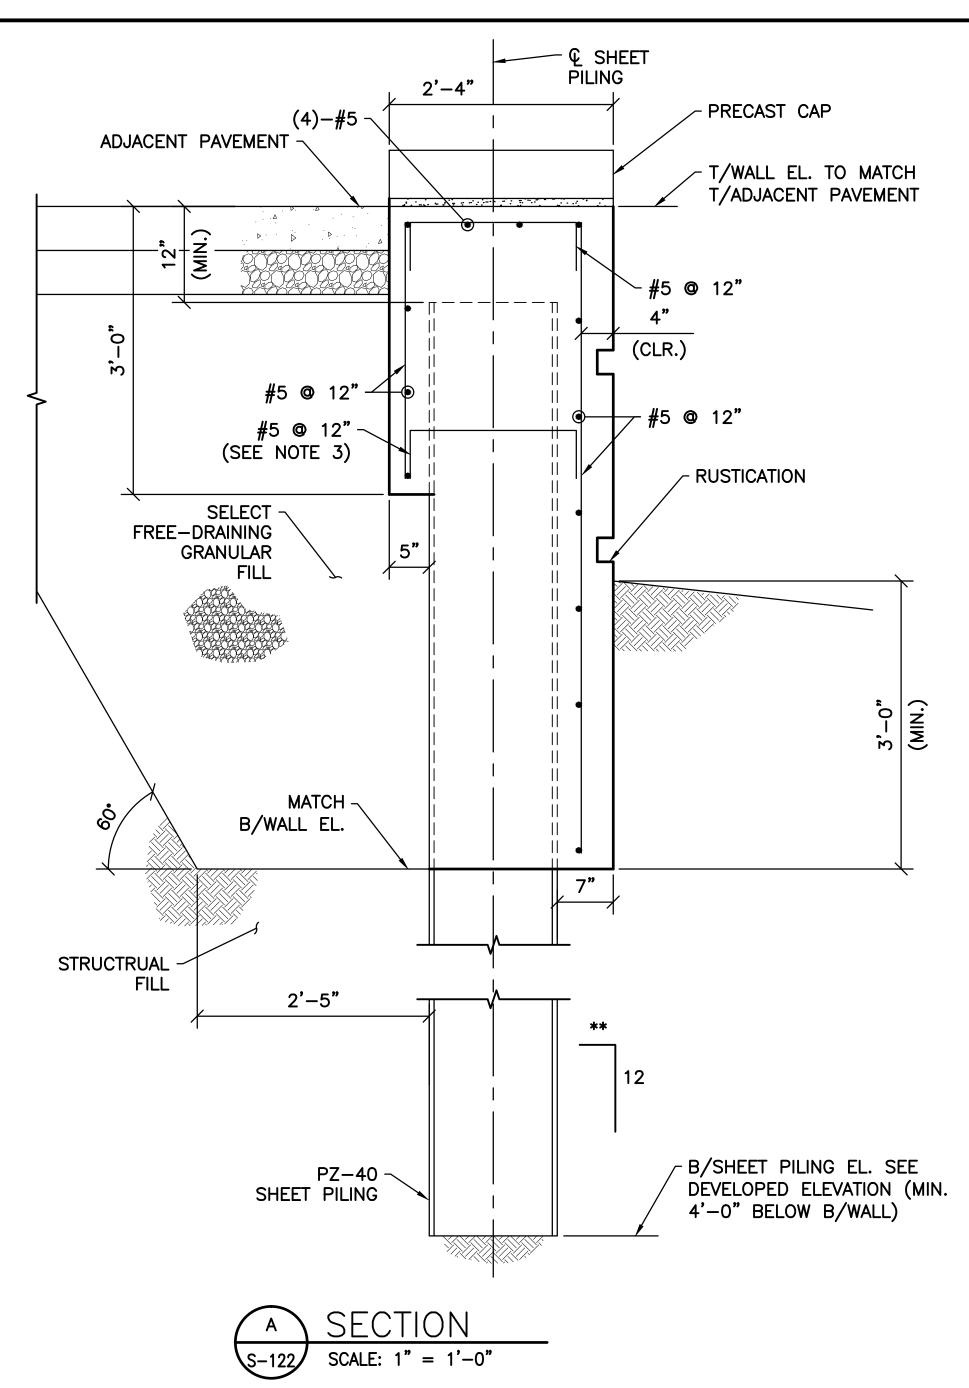

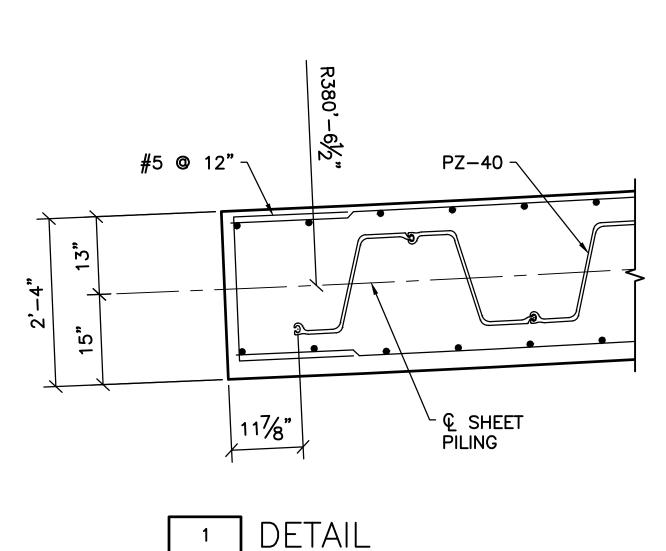

SCALE: 3/4" = 1'-0"

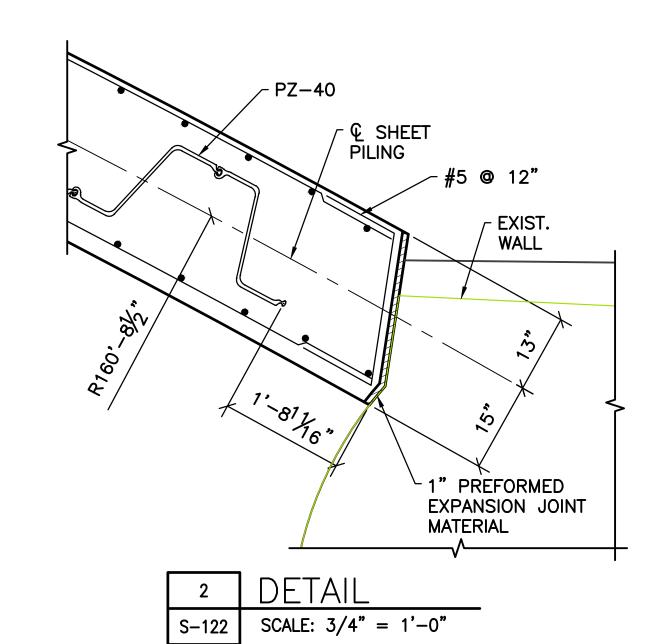

NOTES:

- 1. SEE SHEET S-122 FOR ELEVATIONS.
- 2. RAILING NOT SHOWN FOR CLARITY.
- 3. BURN HOLES IN SHEET PILING TO PASS REINFORCING.
- ** BATTER SHEET PILE AT 1/8" PER 12" TO ACCOMMODATE DEFLECTION IN WALL. PLACE FILL BEHIND WALL PRIOR TO PLACEMENT OF CONCRETE.


SHEET NOTES:

- 1. FOR GENERAL NOTES AND TYPICAL DETAILS SEE SHEETS S-101, S-102, AND S-103.
- 2. SEE LANDSCAPE ARCHITECTURE DRAWINGS FOR ADJACENT PAVEMENT, PRECAST CAP, AND RUSTICATION DETAILS.

reenwo	EAS	SEMENT REFERENCE			REVISIONS			PREPARED BY:		PROJECT TITLE:		CITY OF (COLUMBUS PUBLIC UTILITIES
otc	COUNTY R	RECORDER	GRANTOR	NO.	DESCRIPTION	APPROVAL/DATE		Stantec Consulting Services Inc.		COLUMBUS DOWNTOWN DEVELOPM SCIOTO GREENWAYS PI	ENT CORPORATION POJECT	DEPARTMENT OF DIVISION OF SEWER	RAGE AND DRAINAGE
CIT NO.	VOL.	PAGE	GRANTOR				96	1500 Lake Shore Drive, Suite 100 Columbus, Ohio 43204		CITY OF COLUMBUS,		DIVISION	USE ONLY
.853 __							Stanted	_ (614) 486-4383			1		
000							Junte	(614) 460-4367	RW-11 SECTION AND DETAILS	DIVISION USE ONLY	OWNER		
734							RAL	CV	1111 11 32311311 711123		CONTRACTOR		
(e)							MK				INSPECTOR	SCALE: 1" = 1'-0"	SHEET: S-123
ctiv							LANDSCAPE ARCHITECTU	TURE + URBAN PLANNING			AGREEMENT COMPLETED	SUALL. I — I U	J— 125
24\Q											RPD CKD CLD CON. DR.	CONTRACT DRAWING NO.	RECORD PLAN NO.
173											INDEX RECORD DETAIL FILE	CC-16423	

and 501 - a formation final final decision of the second o




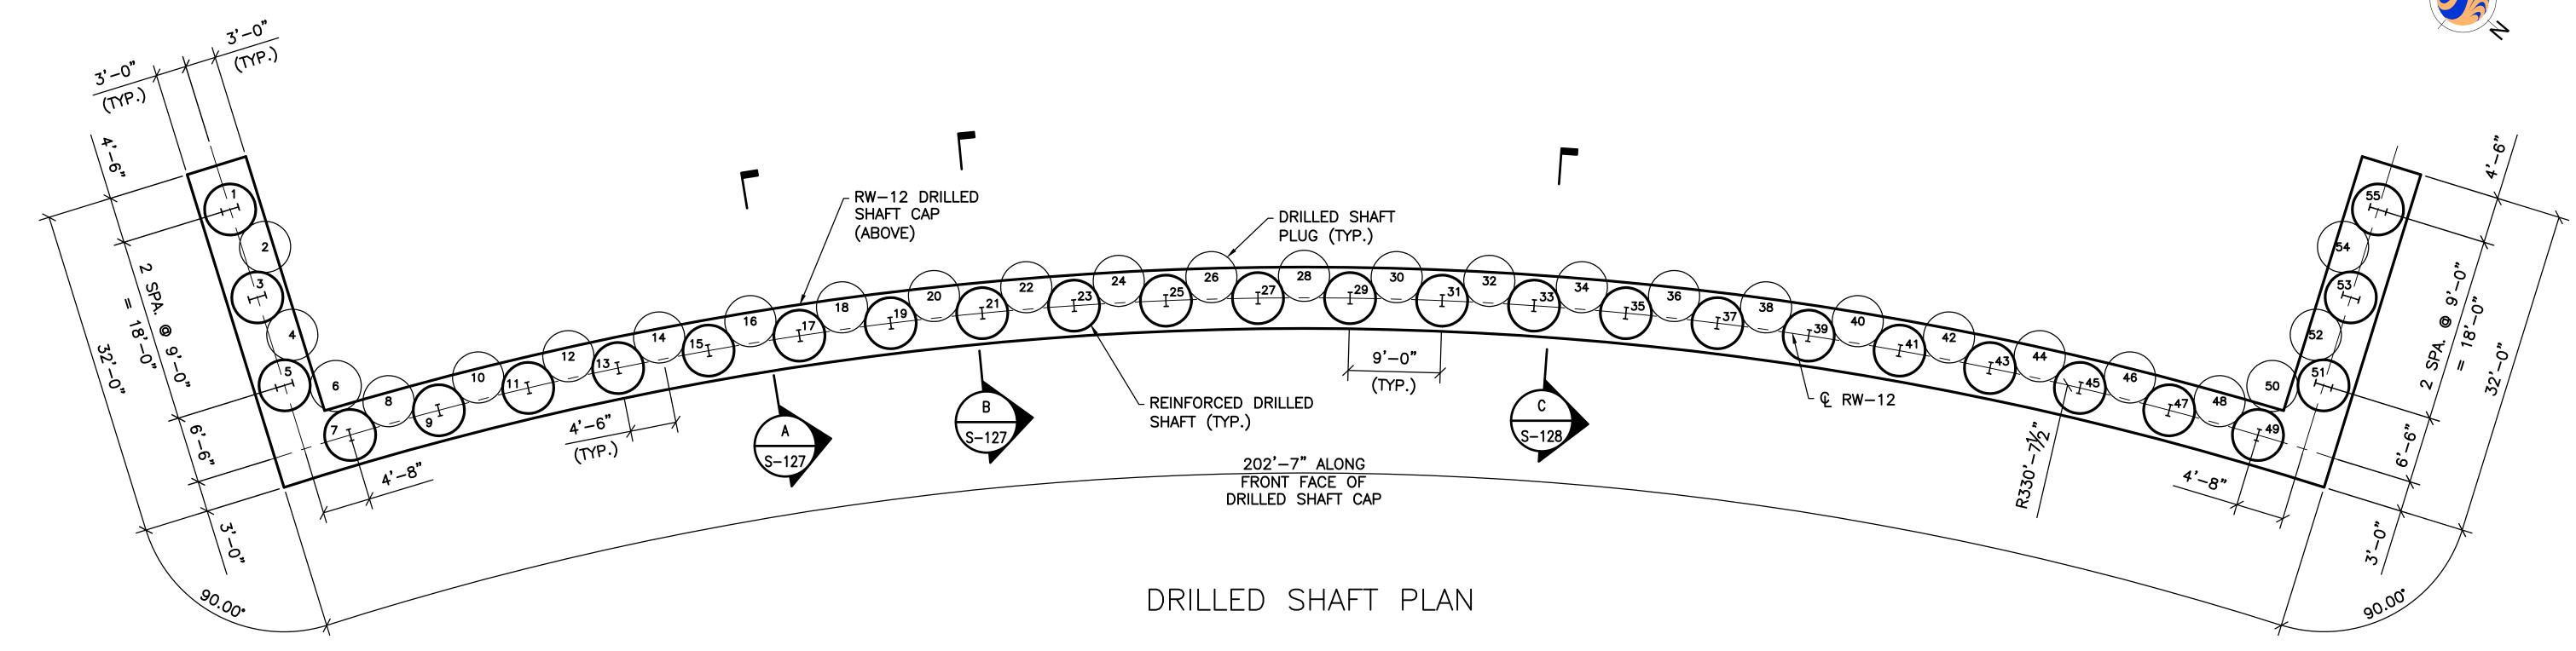

SHEET NOTES:

- 1. FOR GENERAL NOTES AND TYPICAL DETAILS SEE SHEETS S-101, S-102, AND S-103.
- 2. ALL DRILLED SHAFTS TO BE 5'-0" DIA.
- 3. MAX ALLOWABLE LATERAL CAPACITY OF REINFORCED DRILLED SHAFTS 1 THRU 5 AND 51 THRU 55 = 28 TONS
- 4. MAX ALLOWABLE VERTICAL CAPACITY OF REINFORCED DRILLED SHAFTS = 153 TONS

eenwe	EAS	SEMENT REFER	RENCE		REVISIONS		PREPARED BY:		PROJECT TITLE:		CITY OF (COLUMBUS
oto city no.	COUNTY F	RECORDER	GRANTOR	NO.	DESCRIPTION	APPROVAL/DATE	Stantec Consulting Services Inc.		COLUMBUS DOWNTOWN DEVELOPMENT SCIOTO GREENWAYS PROJ	CT	DEPARTMENT OF DIVISION OF SEWER	PUBLIC UTILITIES RAGE AND DRAINAGE
Scio	VOL.	PAGE	Sivarion				1500 Lake Shore Drive, Suite 100 Columbus, Ohio 43204		CITY OF COLUMBUS, OH	0	DIVISION	USE ONLY
853							(614) 486–4383 Stantec (614) 486–4387					
804							Stantec (614) 486–4387	RW-12 DRILLED SHAFT PLAN	DIVISION USE ONLY	OWNER		
734							RAVCV			CONTRACTOR		
(e)							MKSK			INSPECTOR	SCALE: 1/8" = 1'-0"	SHEET: S-124
ctiv							LANDSCAPE ARCHITECTURE + URBAN PLANNING			AGREEMENT COMPLETED	SCALE: 1/6 = 1-0	3-124
4/0										RPD CKD CLD CON. DR.	CONTRACT DRAWING NO.	RECORD PLAN NO.
v:\173										INDEX RECORD DETAIL FILE	CC-16423	

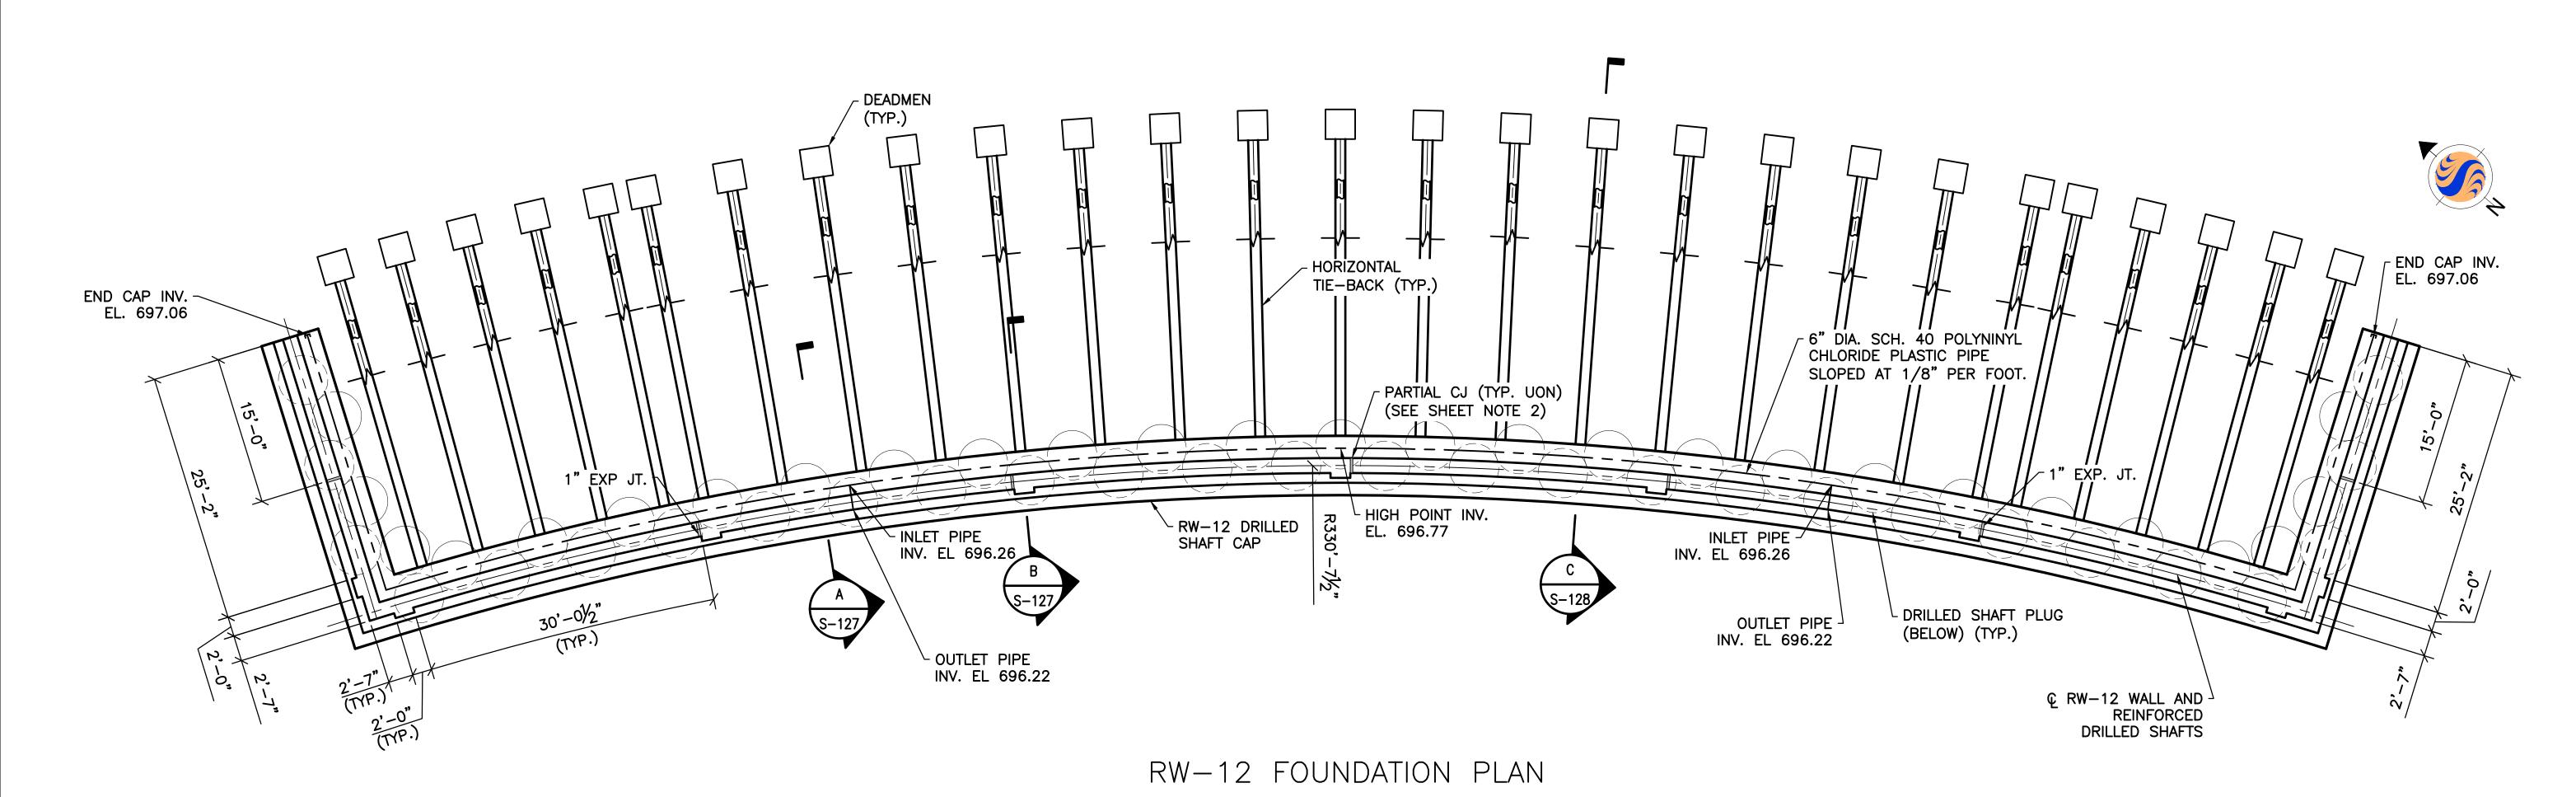


SHEET NOTE:


1. ALL OUTLET PIPES TO BE 6" DIA. SCH. 40 POLYVINYL CHLORIDE SOLID WALL PIPE.

SHEET NOTE:

- 1. FOR GENERAL NOTES AND TYPICAL DETAILS SEE SHEETS S-101, S-102, AND S-103.
- 2. ALL CONSTRUCTION JOINTS TO STOP 3'-0" FROM TOP OF WALL.


eenwe		EASEMENT REFE	RENCE		REVISIONS		PREPARED BY:		PROJECT TITLE:		CITY OF (COLUMBUS
oto_gr		Y RECORDER	GRANTOR	NO. DESCRIP	TION	APPROVAL/DATE	Stantec Consulting Services Inc.		COLUMBUS DOWNTOWN DEVELOPM SCIOTO GREENWAYS P	ROJECT	CITY OF (DEPARTMENT OF DIVISION OF SEWER	AGE AND DRAINAGE
SCIO	VOL.	PAGE					1500 Lake Shore Drive, Suite 100 Columbus, Ohio 43204		CITY OF COLUMBUS,	OHIO	DMSION	use only
8853							(614) 486–4383 Stantec (614) 486–4387	DW 40 FOLINDATION DI ANI	DIVISION USE ONLY	OWNER		
340								RW-12 FOUNDATION PLAN	DIVISION USE UNEI	CONTRACTOR	1	
173							MKSK					
é										INSPECTOR	SCALE: 1/8" = 1'-0"	SHEET: S-125
cti							LANDSCAPE ARCHITECTURE + URBAN PLANNING			AGREEMENT COMPLETED	30/LE. 1/0 - 1 0	3-129
34\a										RPD CKD CLD CON. DR.	CONTRACT DRAWING NO.	RECORD PLAN NO.
v:\173										INDEX RECORD DETAIL FILE	CC-16423	

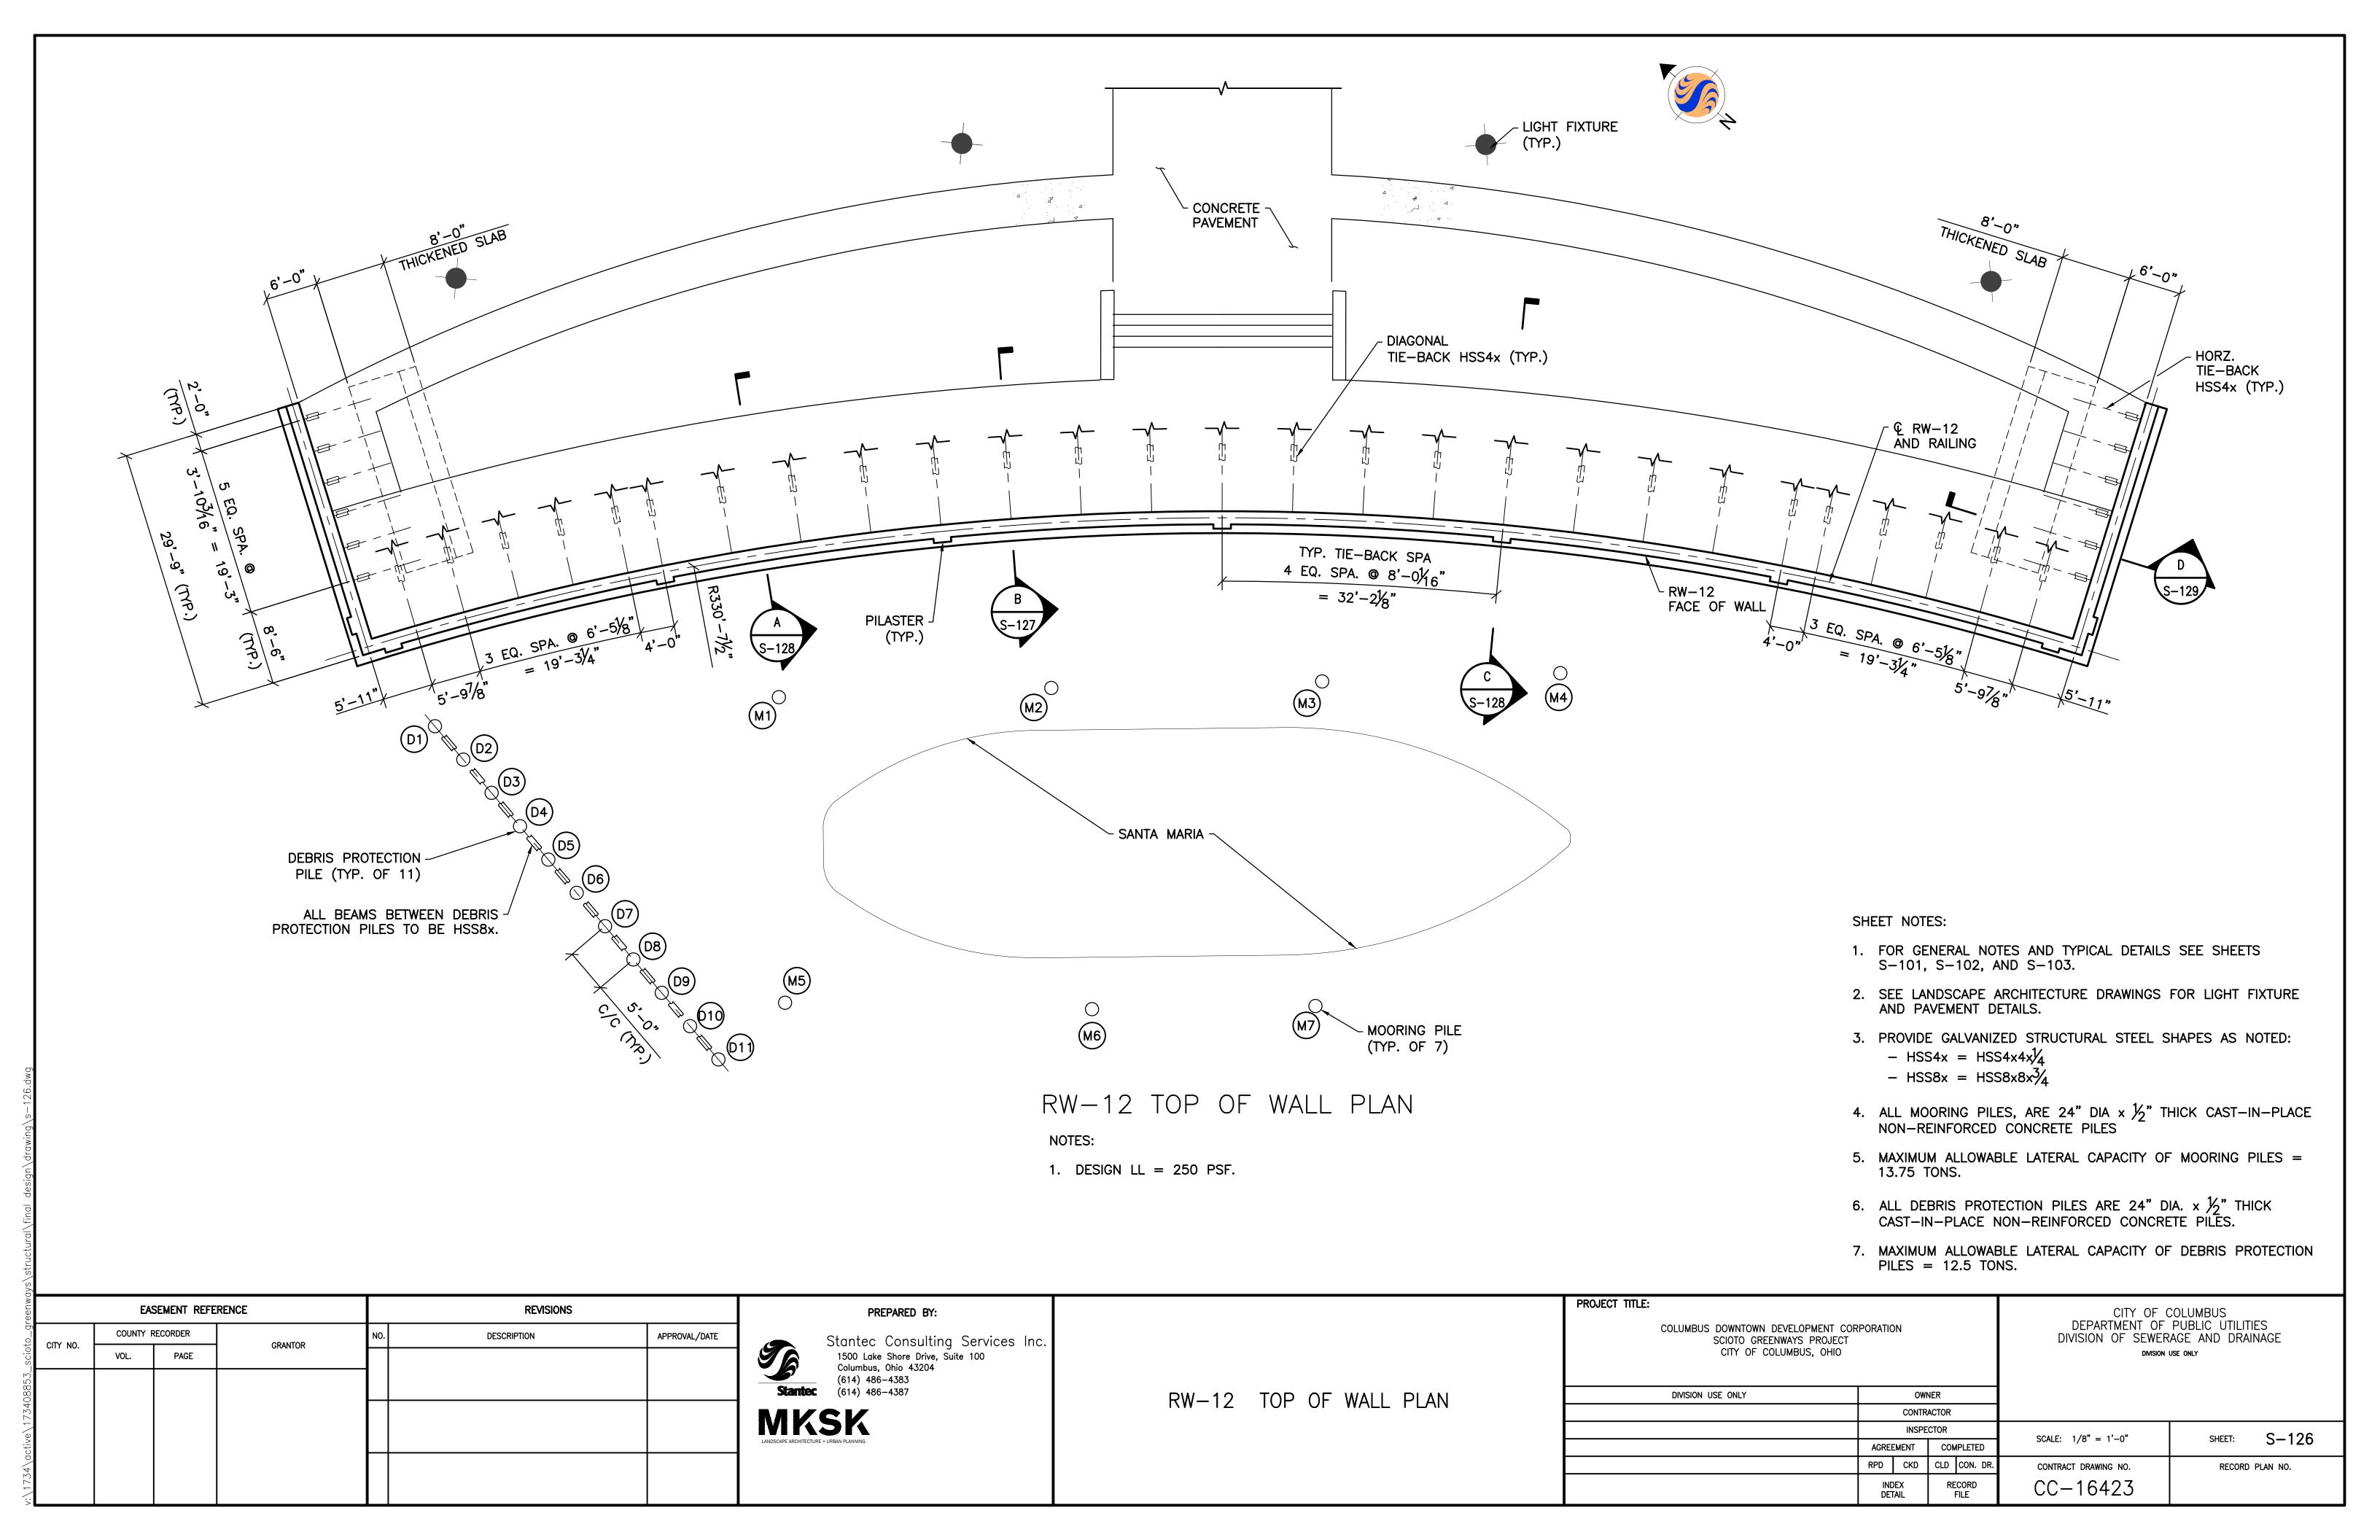


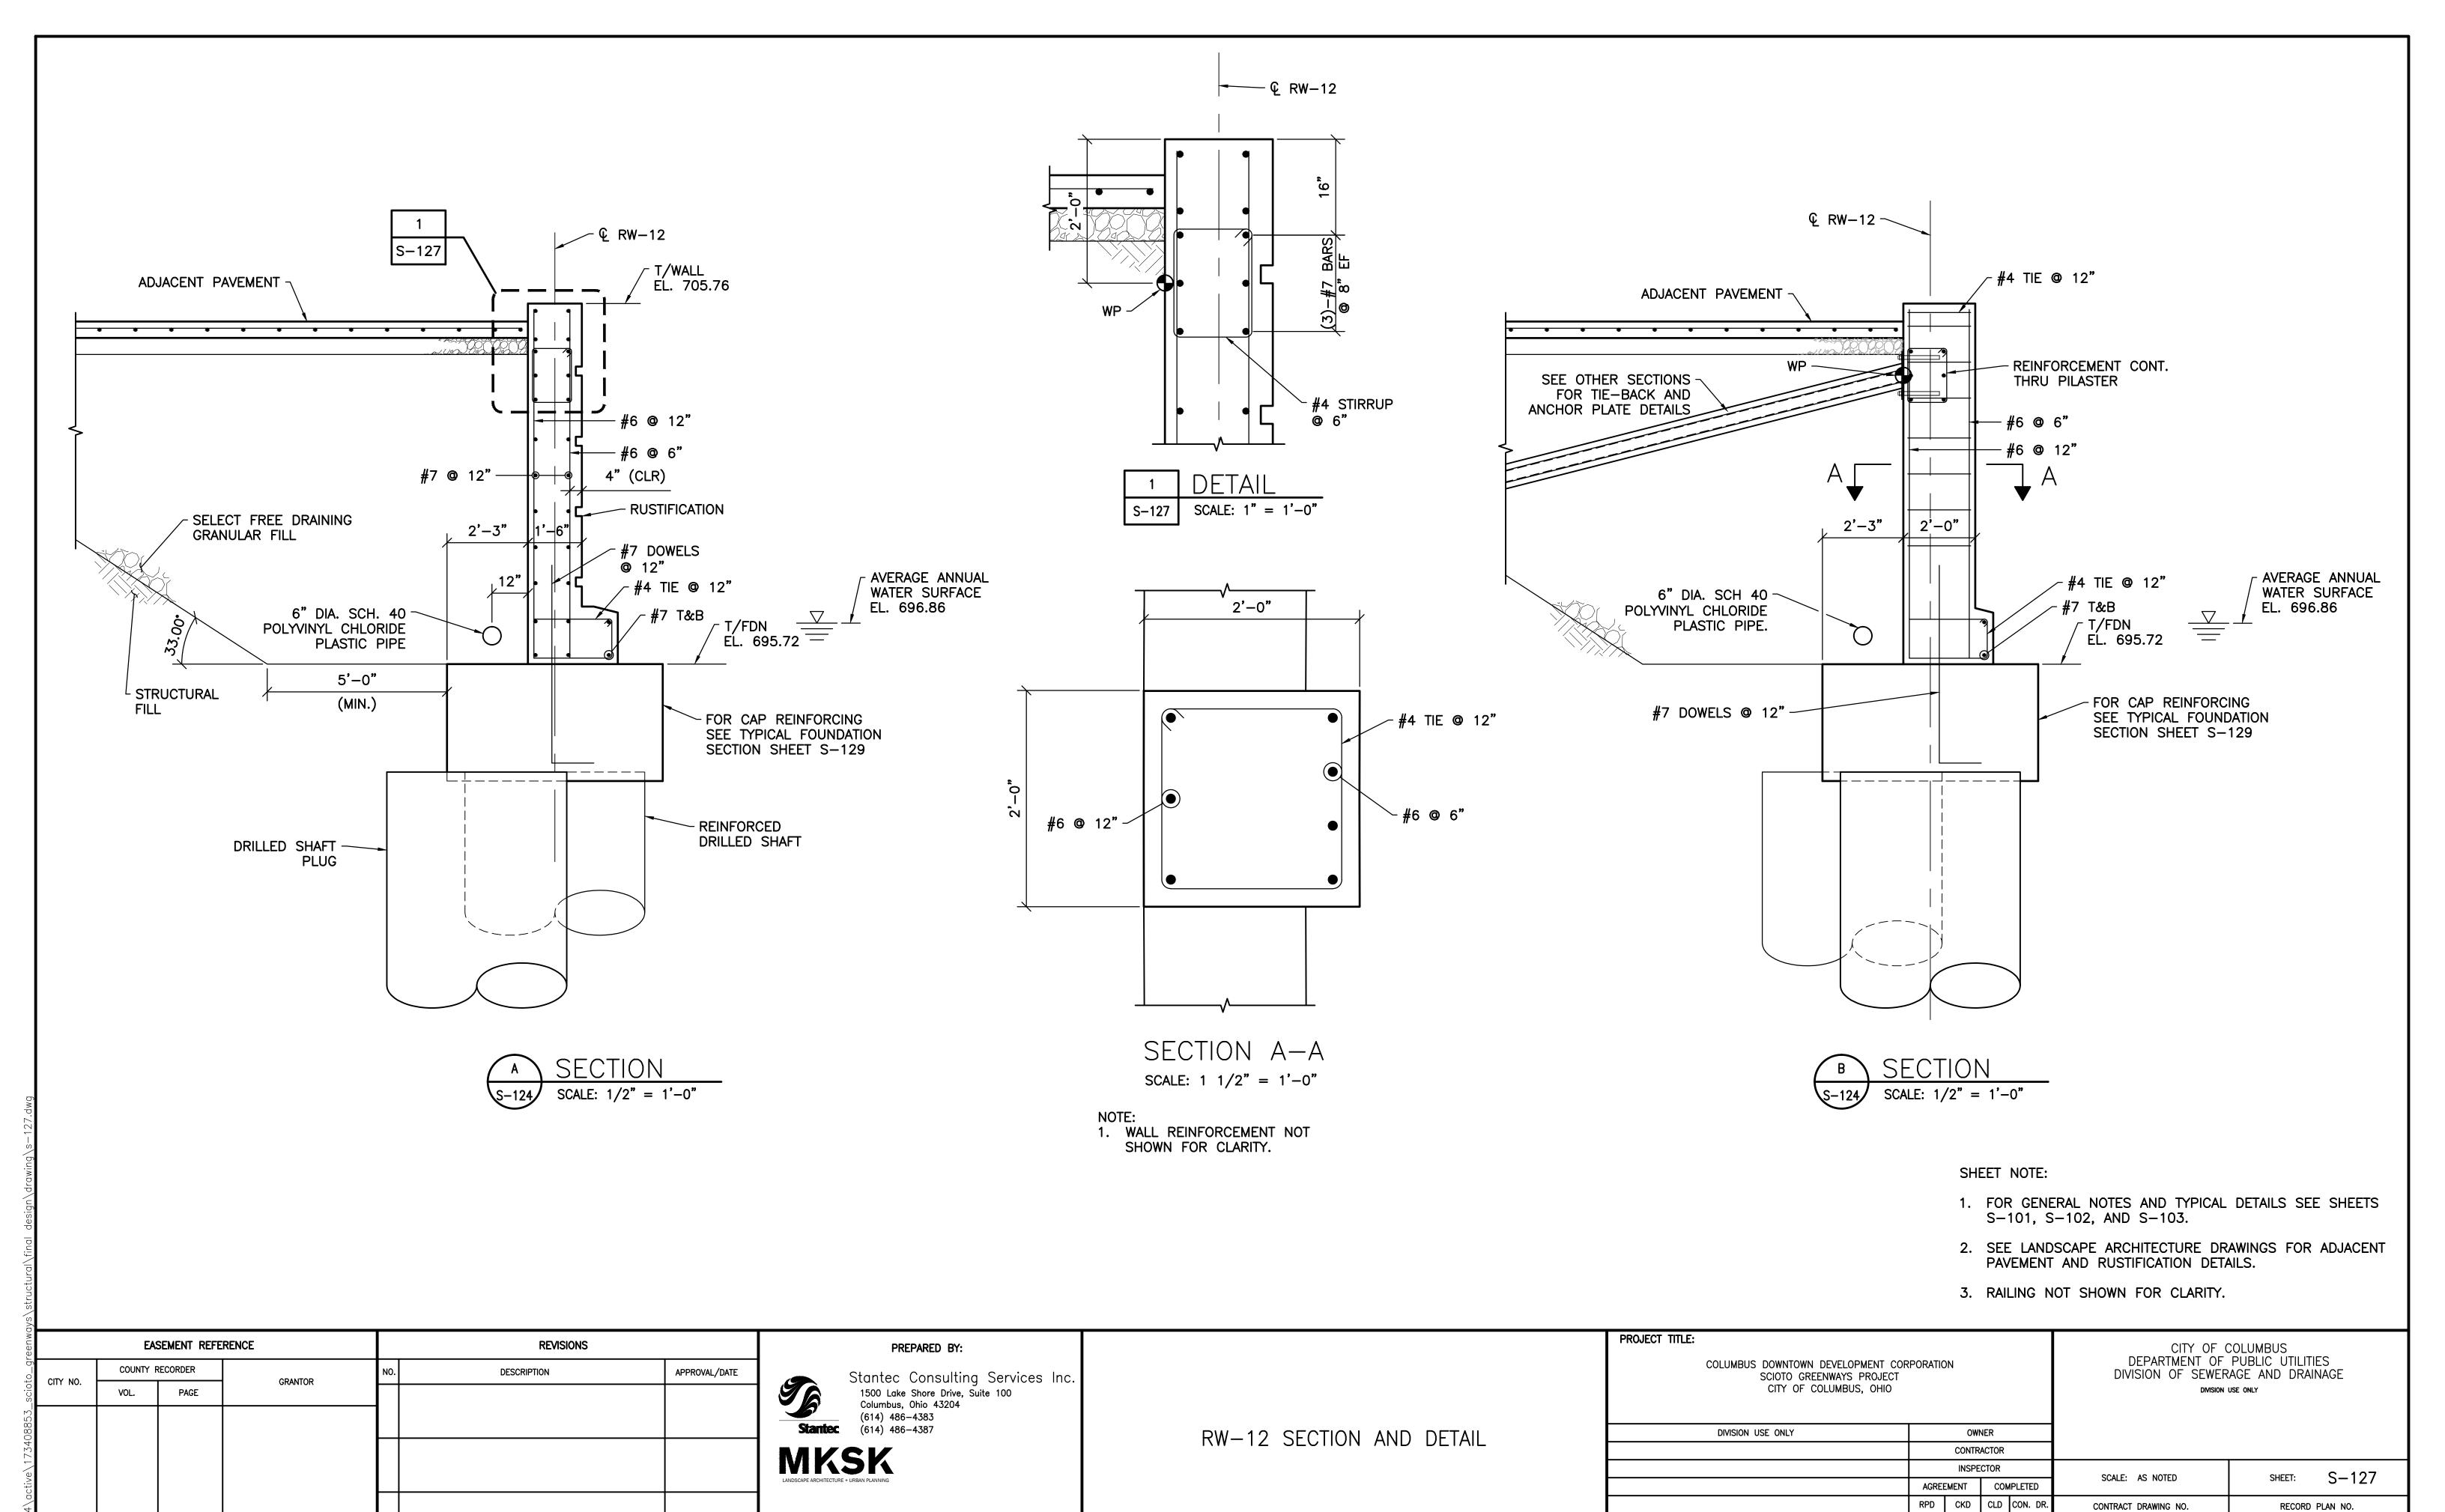


RECORD FILE

INDEX DETAIL CC-16423

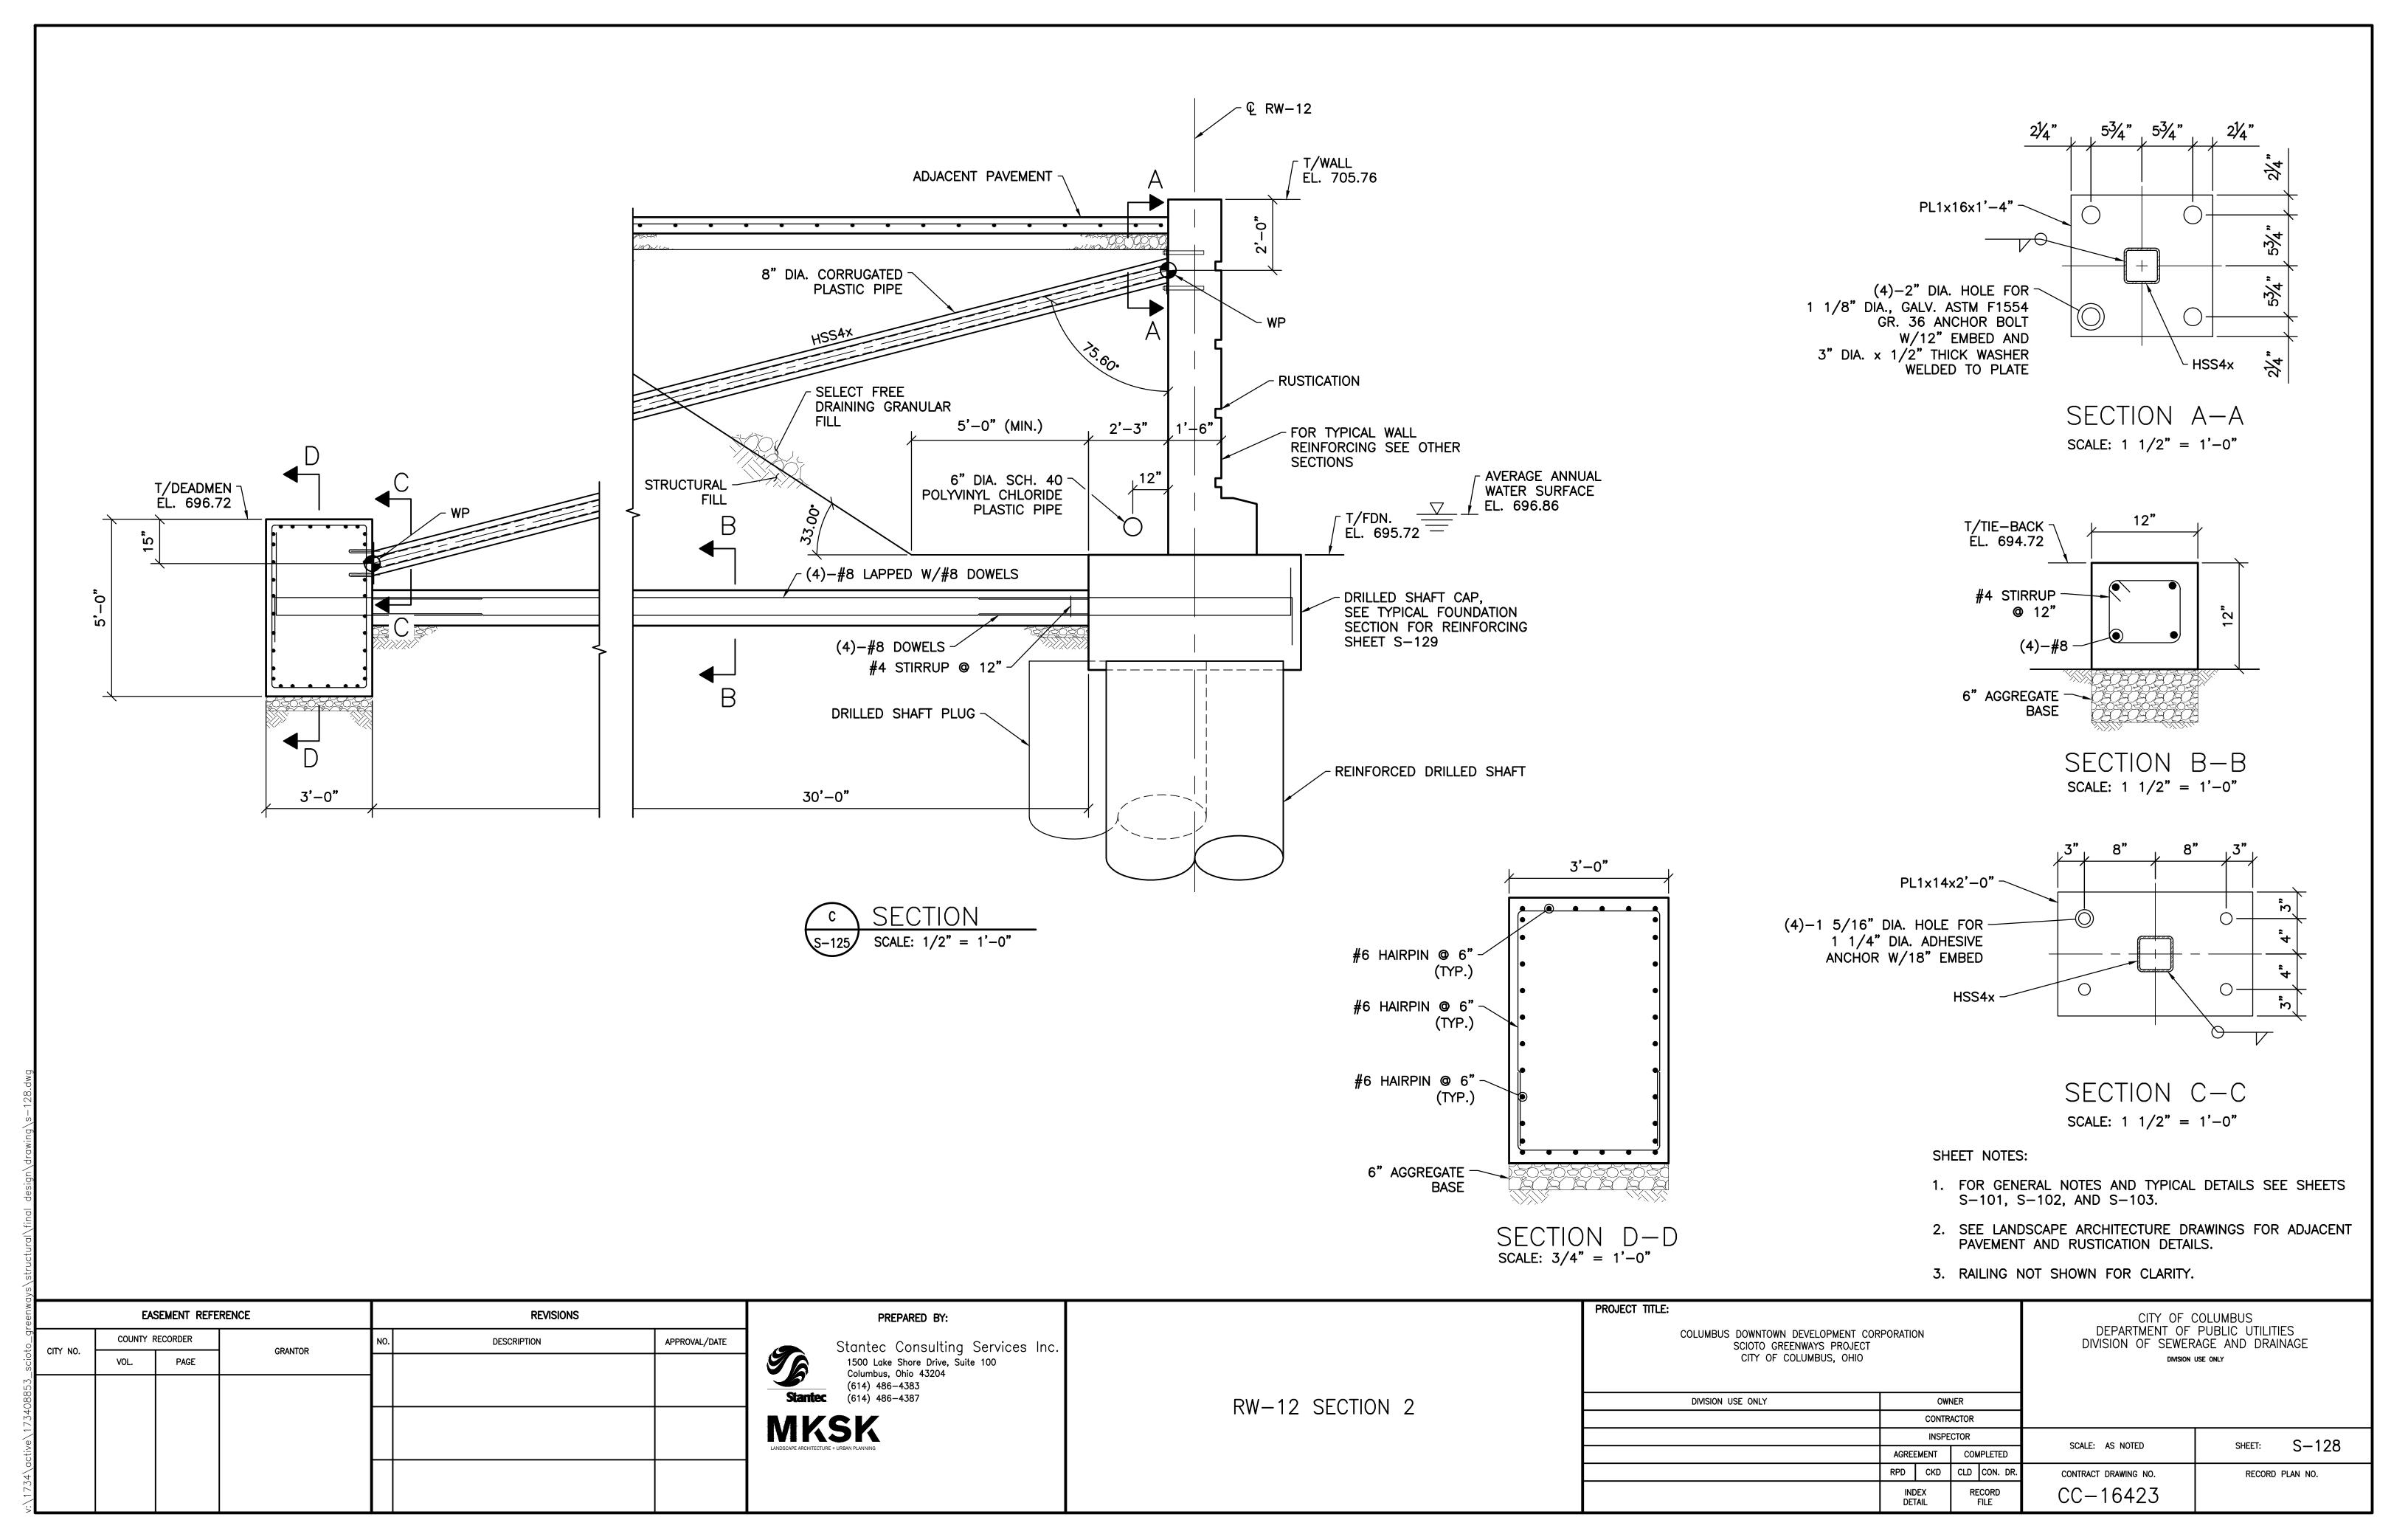

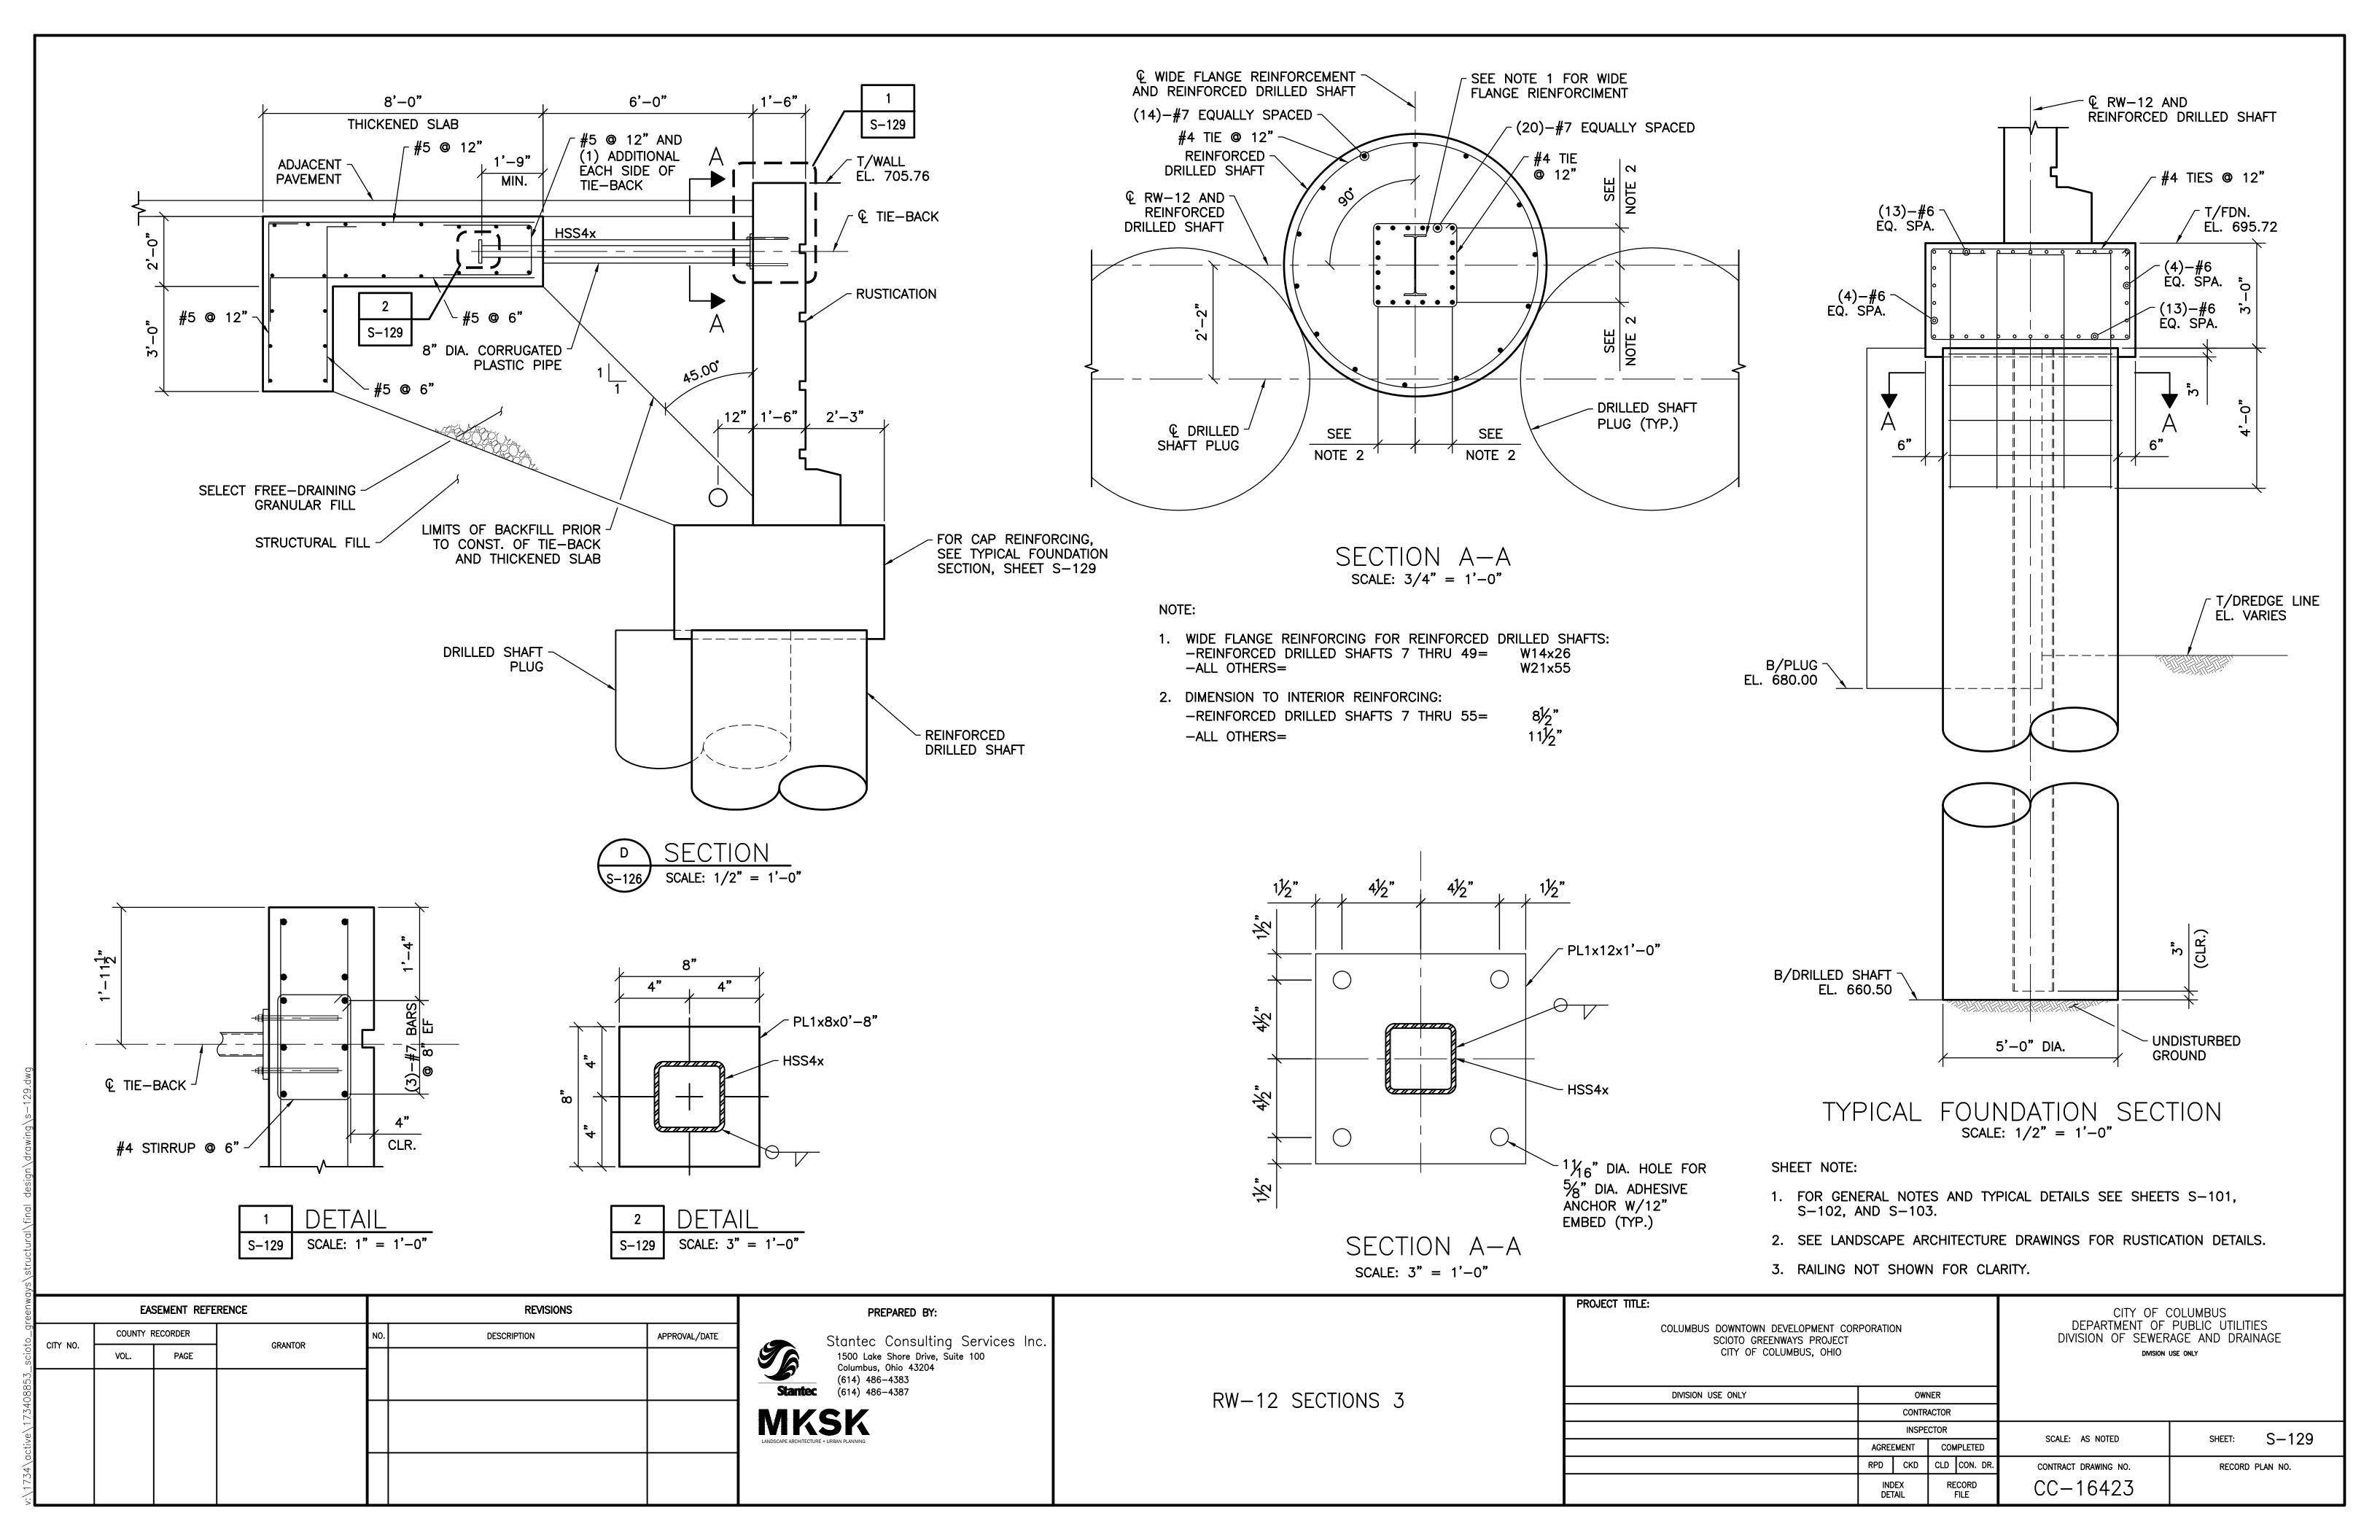

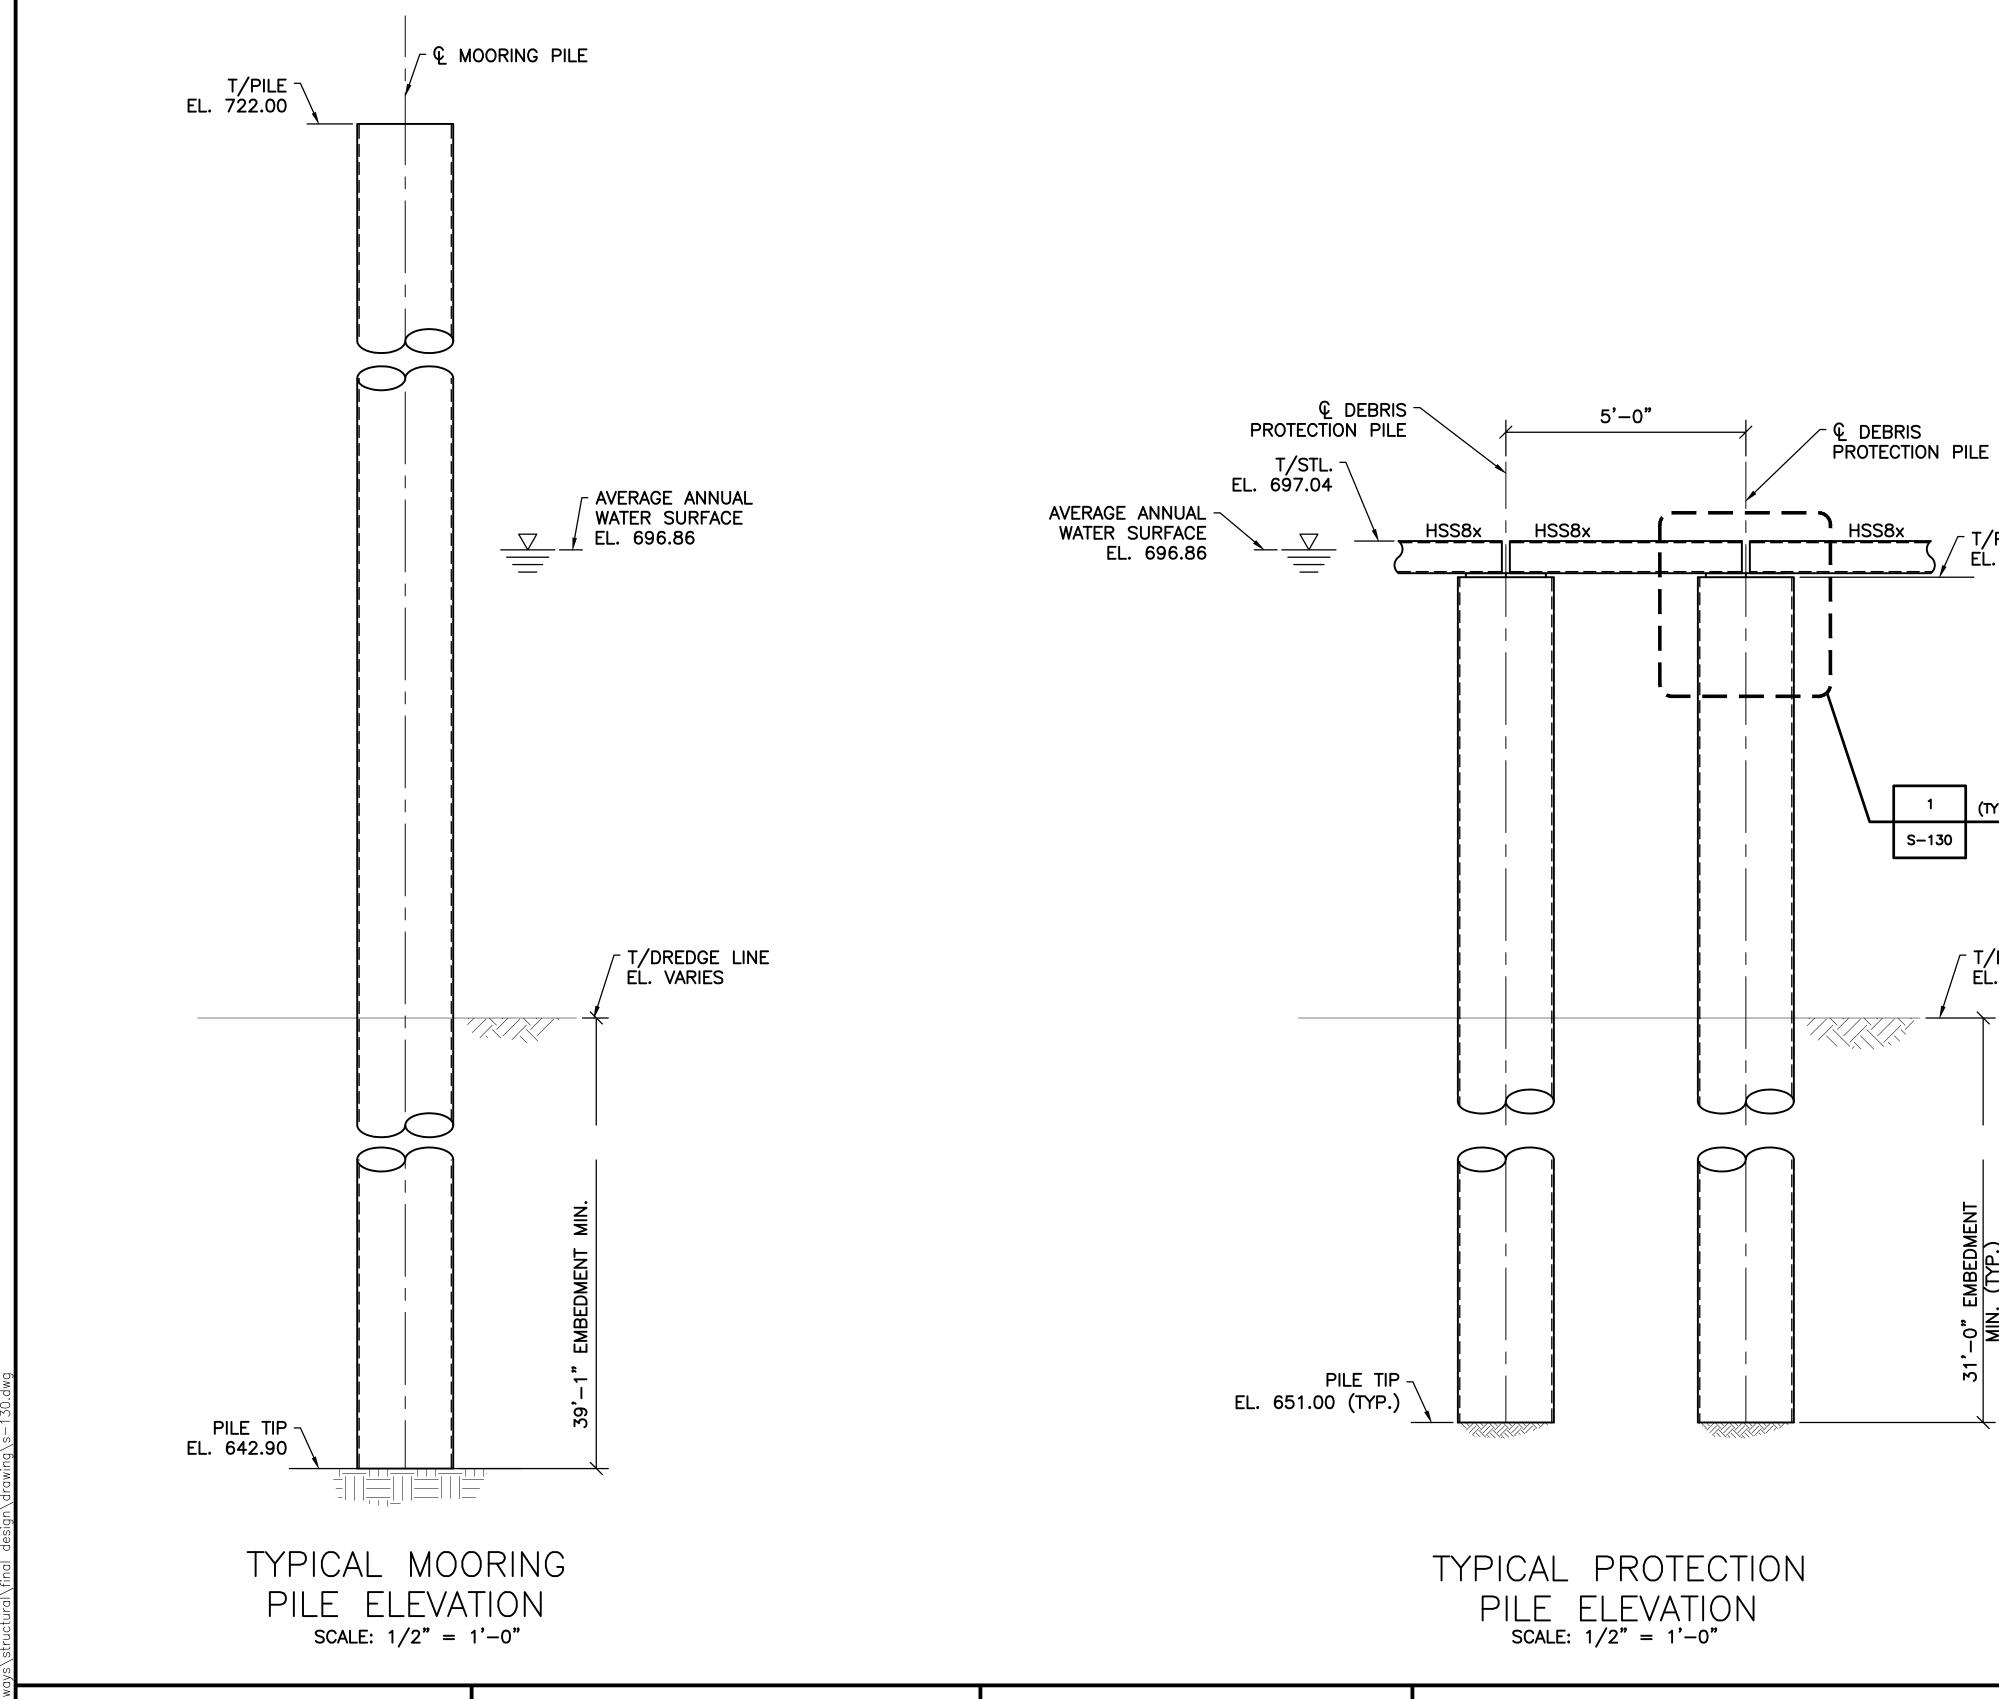

PROTECTION PILE - € POST € DEBRIS -PROTECTION PILE AND HSS8x HSS8x HSS8x TYP. 5/16 / └ PL1x10x0'-10" (TYP.) ~ 24" DIA. PILE FILL WITH -CONCRETE € DEBRIS 1/2" CLOSURE PLATE (TYP.) PROTECTION PILE ┌ € POST € POST \ HSS8x HSS8x 5/16 TYP -PL1x10x0'-10" (TYP.) HSS8x -POST 24" DIA. PILE DETAIL

S-130 SCALE: $1 \frac{1}{2} = 1'-0"$

SHEET NOTE:

- 1. FOR GENERAL NOTES AND TYPICAL DETAILS SEE SHEETS S-101, S-102, AND
- 2. PROVIDE GALVANIZED STRUCTURAL STEEL SHAPES AS NOTED: $- HSS8x = HSS8x8x\frac{3}{8}$
- 3. DEBRIS PROTECTION PILES AND MOORING PILES TO BE FILLED WITH CONCRETE. SLOPE CONCRETE AT TOP TO ALLOW FOR DRAINAGE.

							_
	EA	SEMENT REFE	RENCE		REVISIONS		
CITY NO	COUNTY	RECORDER	CDANITOD	NO.	DESCRIPTION	APPROVAL/DATE	1
CITY NO.	VOL.	PAGE	GRANTOR				1
							1
							4

PREPARED BY: Stantec Consulting Services Inc.

1500 Lake Shore Drive, Suite 100
Columbus, Ohio 43204
(614) 486-4383
(614) 486-4387 MKSK


MOORING AND PROTECTION PILE ELEVATIONS AND DETAIL


/ T/PILE / EL. 696.29


/ T/DREDGE LINE EL. VARIES

S-130

PROJECT TITLE: COLUMBUS DOWNTOWN DEVELOPMENT COR SCIOTO GREENWAYS PROJECT CITY OF COLUMBUS, OHIO	PORATION			DEPARTMENT OF DIVISION OF SEWER	COLUMBUS PUBLIC UTILITIES PAGE AND DRAINAGE USE ONLY
DIVISION USE ONLY		OWN	IER		
	COI	NTR/	ACTOR		
	IN:	SPE	CTOR	SCALE: AS NOTED	SHEET: S-130
	AGREEMENT		COMPLETED	SCALE. AS NOTED	3-130
	RPD CKI		CLD CON. DR.	CONTRACT DRAWING NO.	RECORD PLAN NO.
	INDEX DETAIL		RECORD FILE	CC-16423	

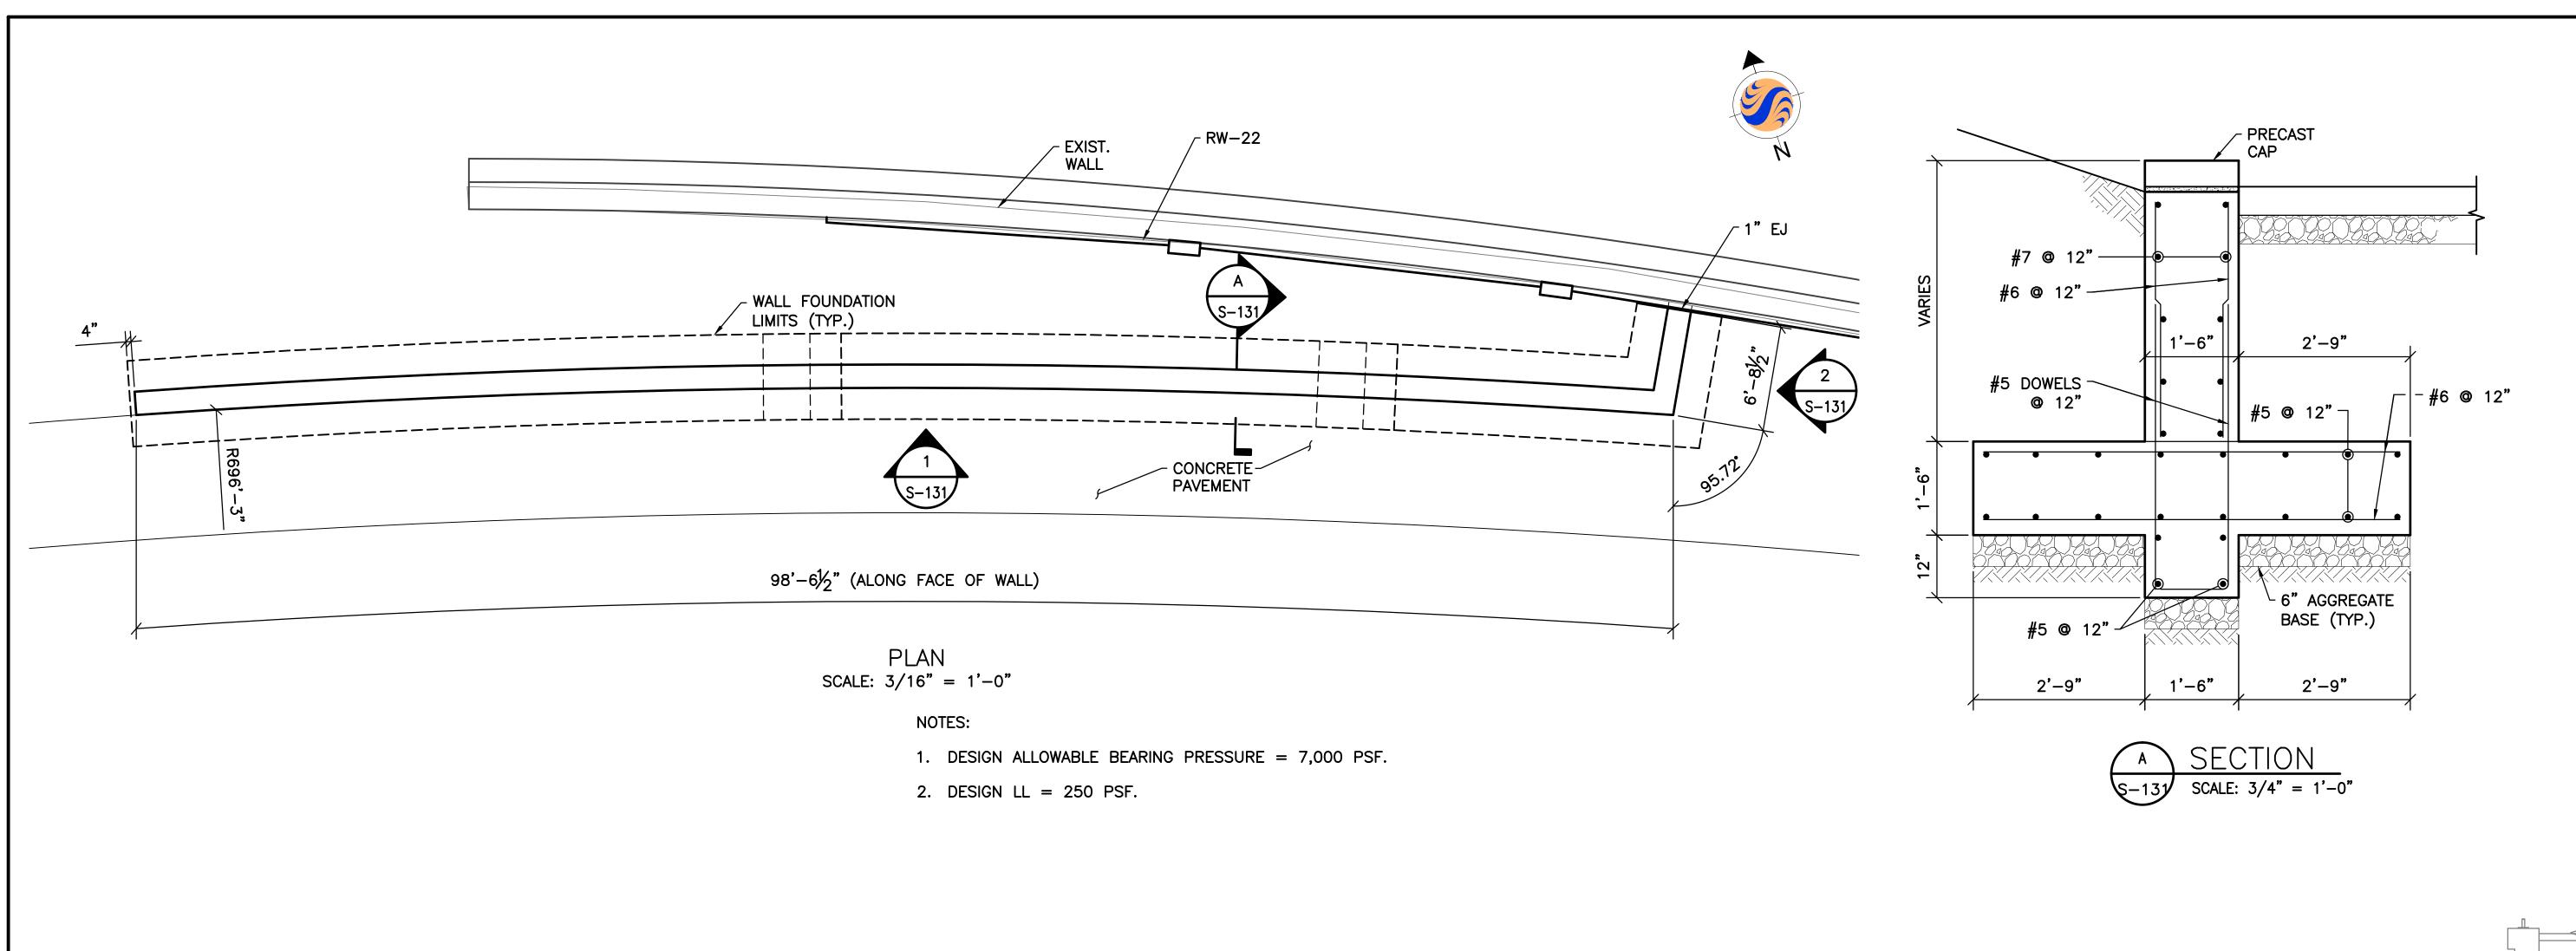

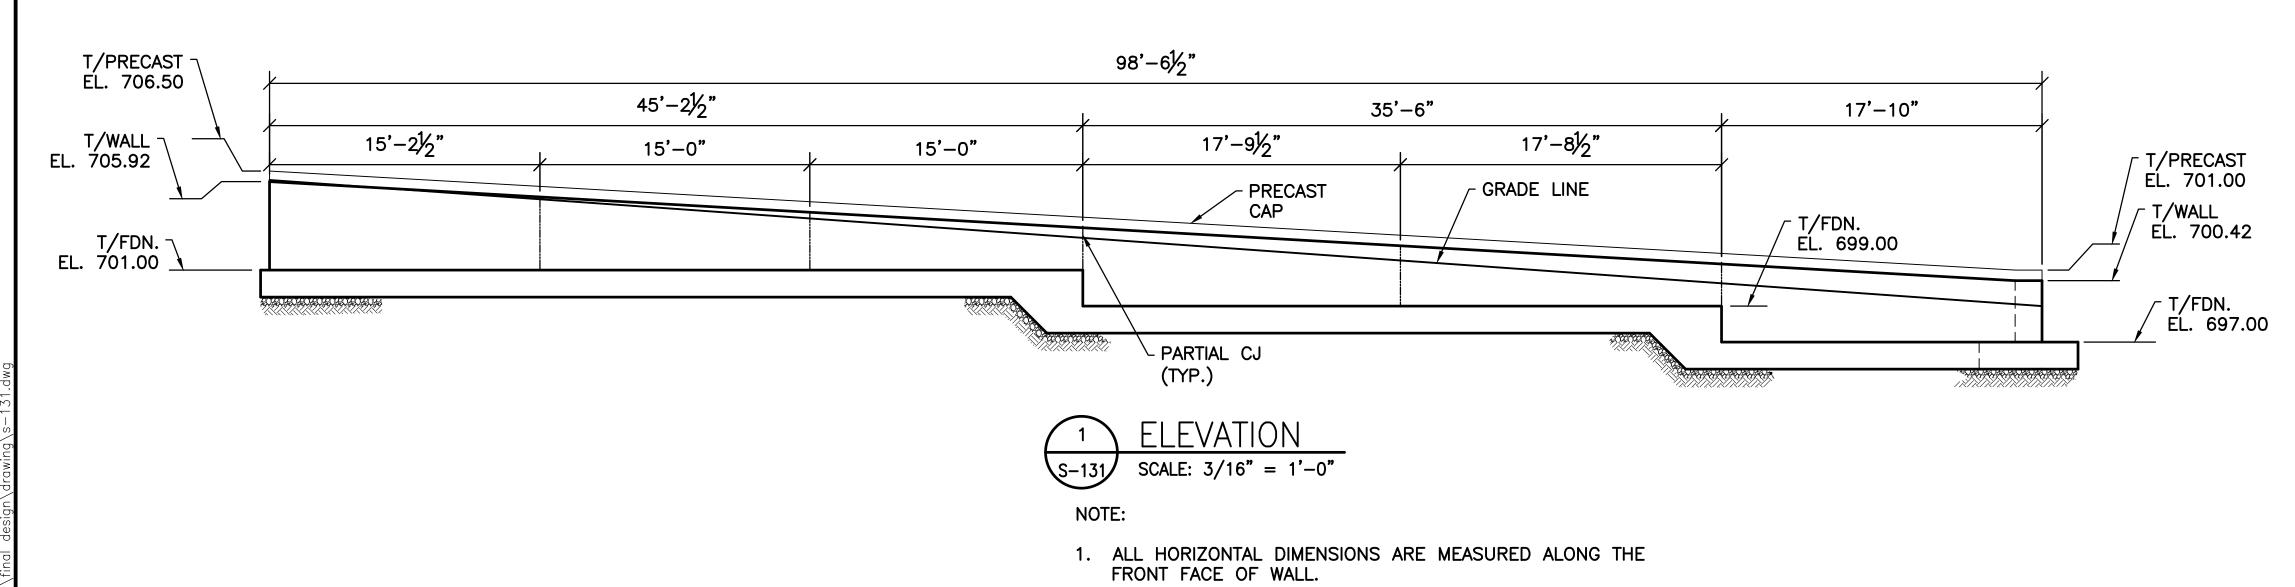


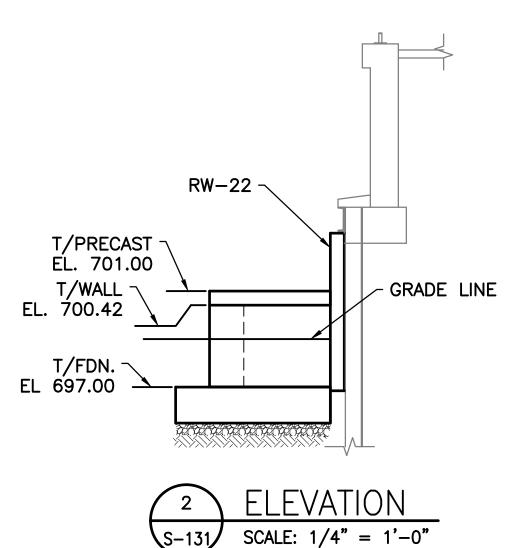

SHEET NOTES:

- 1. FOR GENERAL NOTES AND TYPICAL DETAILS SEE SHEETS S-101, S-102, AND S-103.
- 2. SEE LANDSCAPE ARCHITECTURE DRAWINGS FOR PRECAST CAP DETAILS.


									CAP DETAILS.		
	EAS	EMENT REFER	RENCE	REVISIONS		PREPARED BY:		PROJECT TITLE:		CITY OF C DEPARTMENT OF I	OLUMBUS
CITY NO.	COUNTY RI	ECORDER	GRANTOR	NO. DESCRIPTION	APPROVAL/DATE	Stantec Consulting Services Inc.		COLUMBUS DOWNTOWN DEVELOPM SCIOTO GREENWAYS PI		DEPARTMENT OF T DIVISION OF SEWERA	AGE AND DRAINAGE
CITT NO.	VOL.	PAGE	GIVANION			1500 Lake Shore Drive, Suite 100 Columbus, Ohio 43204 (614) 486-4383 (614) 486-4387		CITY OF COLUMBUS,	OHIO	DIVISION US	SE ONLY
]		(614) 486–4383					
						Stantec (614) 486–4387	RW-14 PLAN, ELEVATIONS, AND SECTION	DIVISION USE ONLY	OWNER		
						MKSK	· · · · · · · · · · · · · · · · · · ·		CONTRACTOR		
									INSPECTOR	SCALE: AS NOTED	SHEET: S-131
						LANDSCAPE ARCHITECTURE + URBAN PLANNING			AGREEMENT COMPLETED	SCALE. AS NOTED	3—131
									RPD CKD CLD CON. DR.	CONTRACT DRAWING NO.	RECORD PLAN NO.
									INDEX RECORD DETAIL FILE	CC-16423	

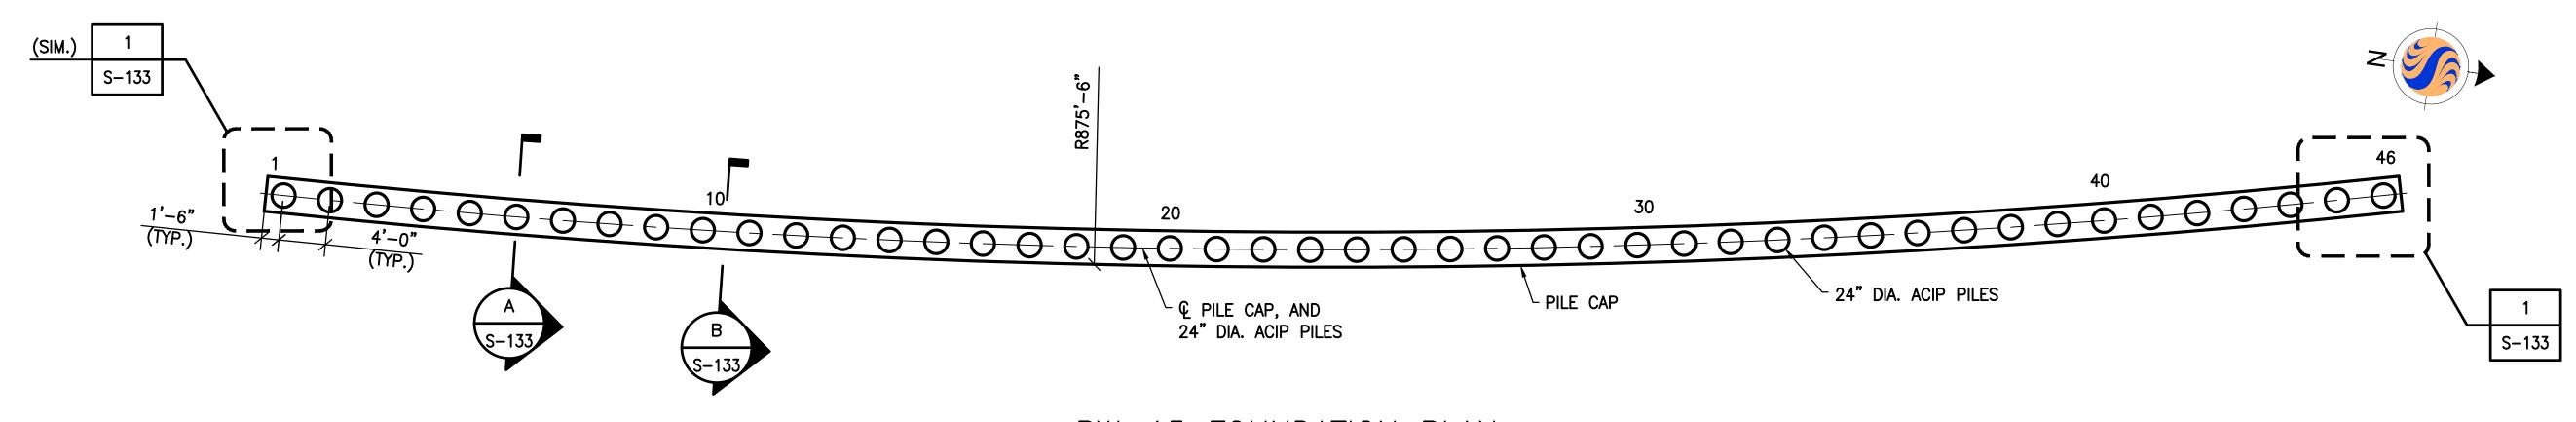

RW-15 FOUNDATION PLAN

NOTES:

- 1. ALL PILES TO BE 24" DIA. AUGER CAST-IN-PLACE (ACIP), 46 TOTAL.
- 2. MAX. ALLOWABLE VERTICAL CAPACITY OF 24" DIA. ACIP PILES = 4.1 TONS.
- 3. MAX. ALLOWABLE LATERAL CAPACITY OF 24" DIA. ACIP PILES = 2.5 TONS.

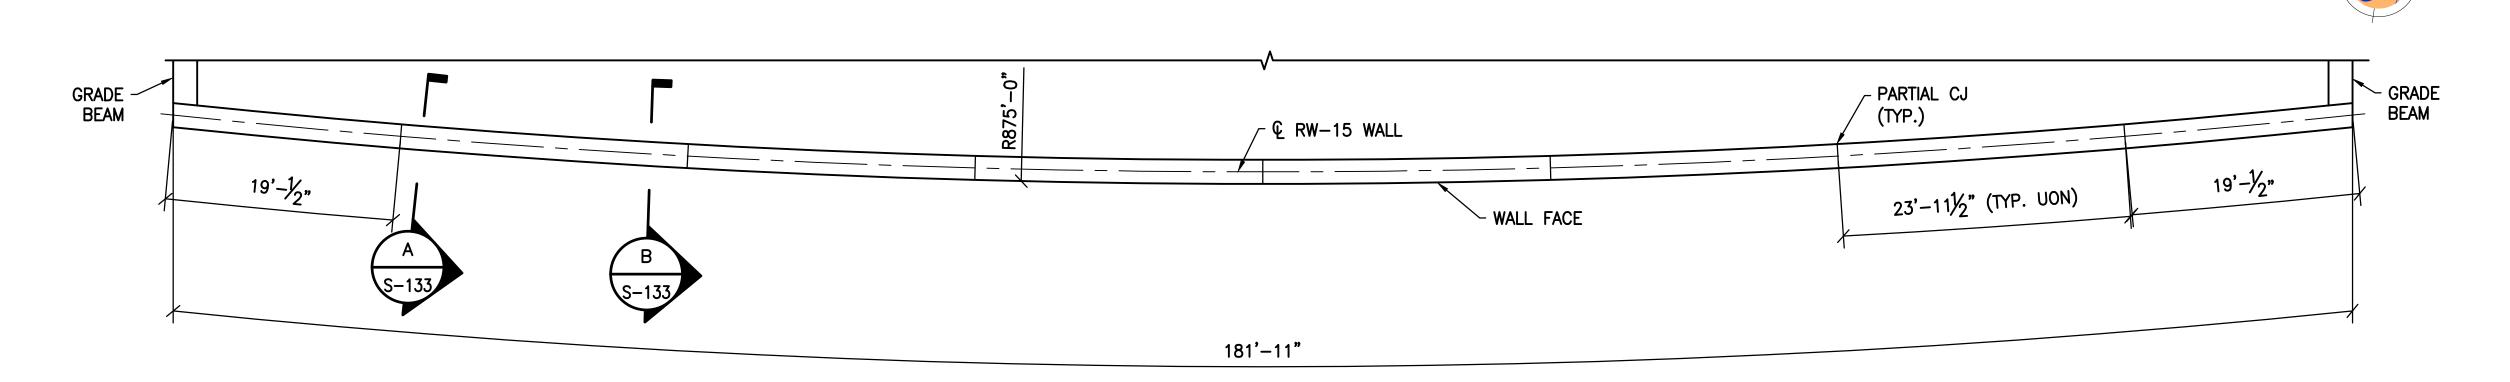

RW-15 TOP OF WALL PLAN


NOTE


1. DESIGN LL = 250 PSF.


SHEET NOTES:

- 1. FOR GENERAL NOTES AND TYPICAL DETAILS SEE SHEETS S-101, S-102, AND S-103.
- 2. ALL HORIZONTAL DIMENSIONS SHOWN MEASURED ALONG € RW-15.

	EASEMENT REFER	ENCE		REVISIONS		PREPARED BY:		PROJECT TITLE:			CITY OF C DEPARTMENT OF	COLUMBUS
CITY NO.	COUNTY RECORDER	GRANTOR	NO.	DESCRIPTION	APPROVAL/DATE	Stantec Consulting Services Inc.		COLUMBUS DOWNTOWN DEVELOPMEN' SCIOTO GREENWAYS PROJ	IECT		DEPARTMENT OF DIVISION OF SEWER	RAGE AND DRAINAGE
CITI NO.	VOL. PAGE	GRANTOR				1500 Lake Shore Drive, Suite 100 Columbus, Ohio 43204		CITY OF COLUMBUS, OF	liO		DIVISION (USE ONLY
						(614) 486–4383 Stantec (614) 486–4387	RW-15 FOUNDATION AND TOP OF WALL PLAN	DIVISION USE ONLY	OW	VNER		
						MKSK	TW 13 1 0011D/(11011 /(110 101 01 W/(LE 1 D/(1)		CONTR	RACTOR		
									INSP	ECTOR	SCALE: 1/8" = 1'-0"	SHEET: S-132
						LANDSCAPE ARCHITECTURE + URBAN PLANNING			AGREEMENT	COMPLETED	30ALL: 1/0 - 1 0	3-132
									RPD CKD	CLD CON. DR.	CONTRACT DRAWING NO.	RECORD PLAN NO.
									INDEX DETAIL	RECORD FILE	CC-16423	

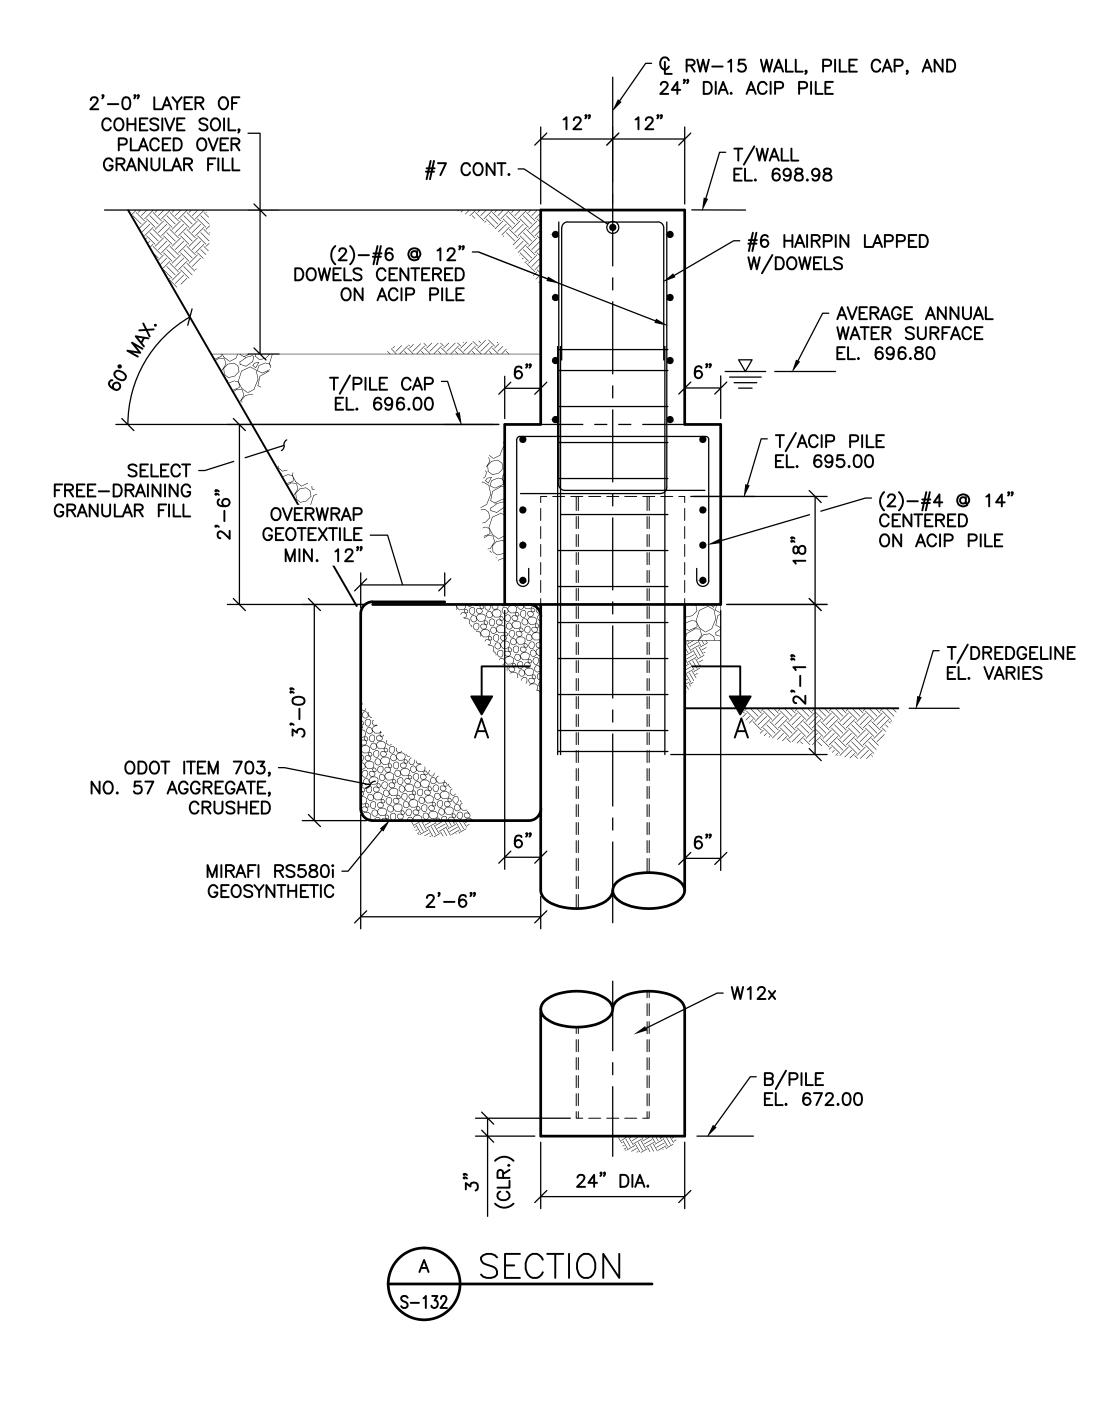


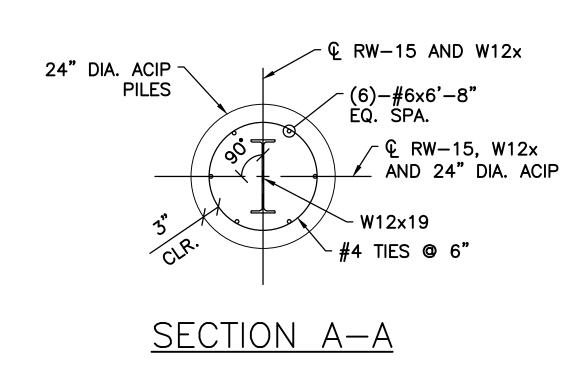

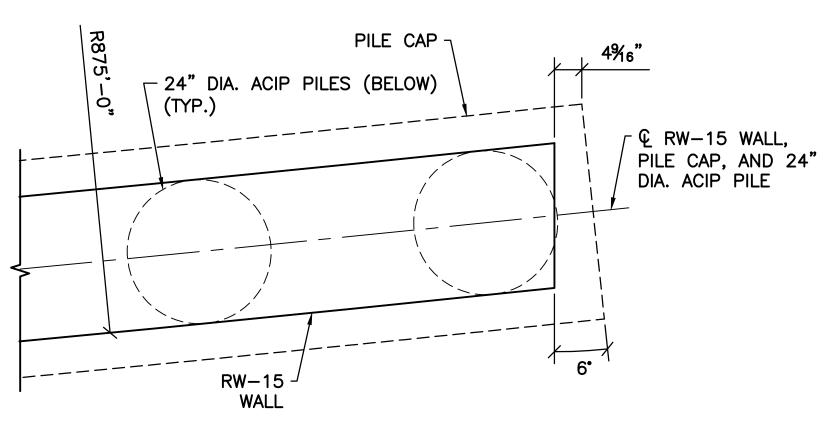

DETAIL


S-132

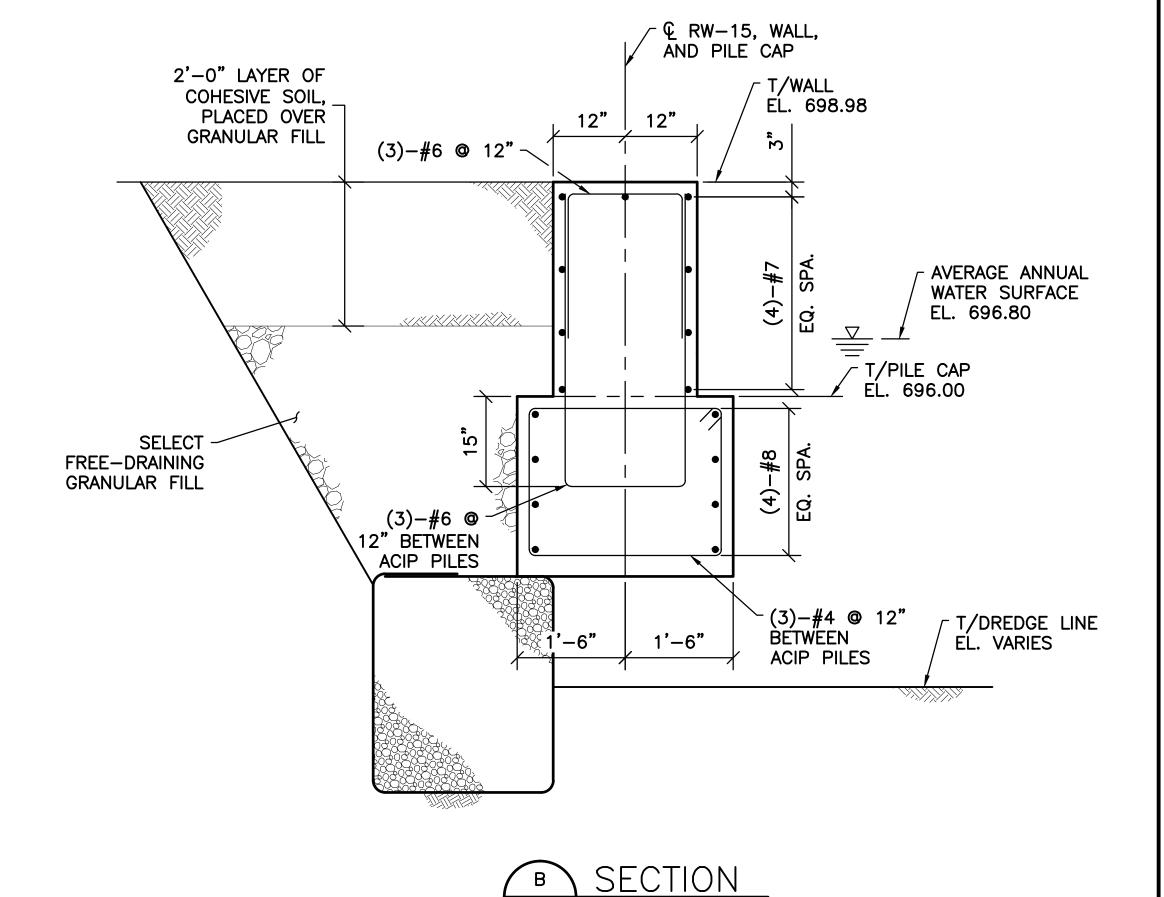

SHEET NOTE:

1. FOR GENERAL NOTES AND TYPICAL DETAILS SEE SHEETS S-101, S-102, AND S-103.

еелжо	EASEMENT REFERENCE		ENCE	REVISIONS		PREPARED BY:		PROJECT TITLE:		CITY OF COL	UMBUS		
GTY NO	CITY NO. COUNTY RECORDER VOL. PAGE GRANTOR		CRANTOR	NO.	DESCRIPTION	APPROVAL/DATE	Stantec Consulting Services Inc.		COLUMBUS DOWNTOWN DEVELOPM SCIOTO GREENWAYS PR	ROJECT	CITY OF COLUMBUS DEPARTMENT OF PUBLIC UTILITIES DIVISION OF SEWERAGE AND DRAINAGE		
SCION NO.			GRAINTOR			1500 Lake Shore Drive, Suite 100 Columbus, Ohio 43204		CITY OF COLUMBUS,	OHIO	DIVISION USE ONLY			
853							(614) 486–4383 Stantec (614) 486–4387						
108							Stantec (614) 486-4387	RW-15 WALL SECTIONS AND DETAIL	DIVISION USE ONLY	OWNER			
/34							MKSK	1111 13 11112 323113113 71113 3217112		CONTRACTOR			
()										INSPECTOR	SCALE: $3/4" = 1'-0"$	SHEET: S-133	
ctiv							LANDSCAPE ARCHITECTURE + URBAN PLANNING			AGREEMENT COMPLETED	SCALE: 3/4 = 1-0	2-122	
ρ\ 4 .										RPD CKD CLD CON. DR.	CONTRACT DRAWING NO.	RECORD PLAN NO.	
; / [/ :										INDEX RECORD DETAIL FILE	CC-16423		

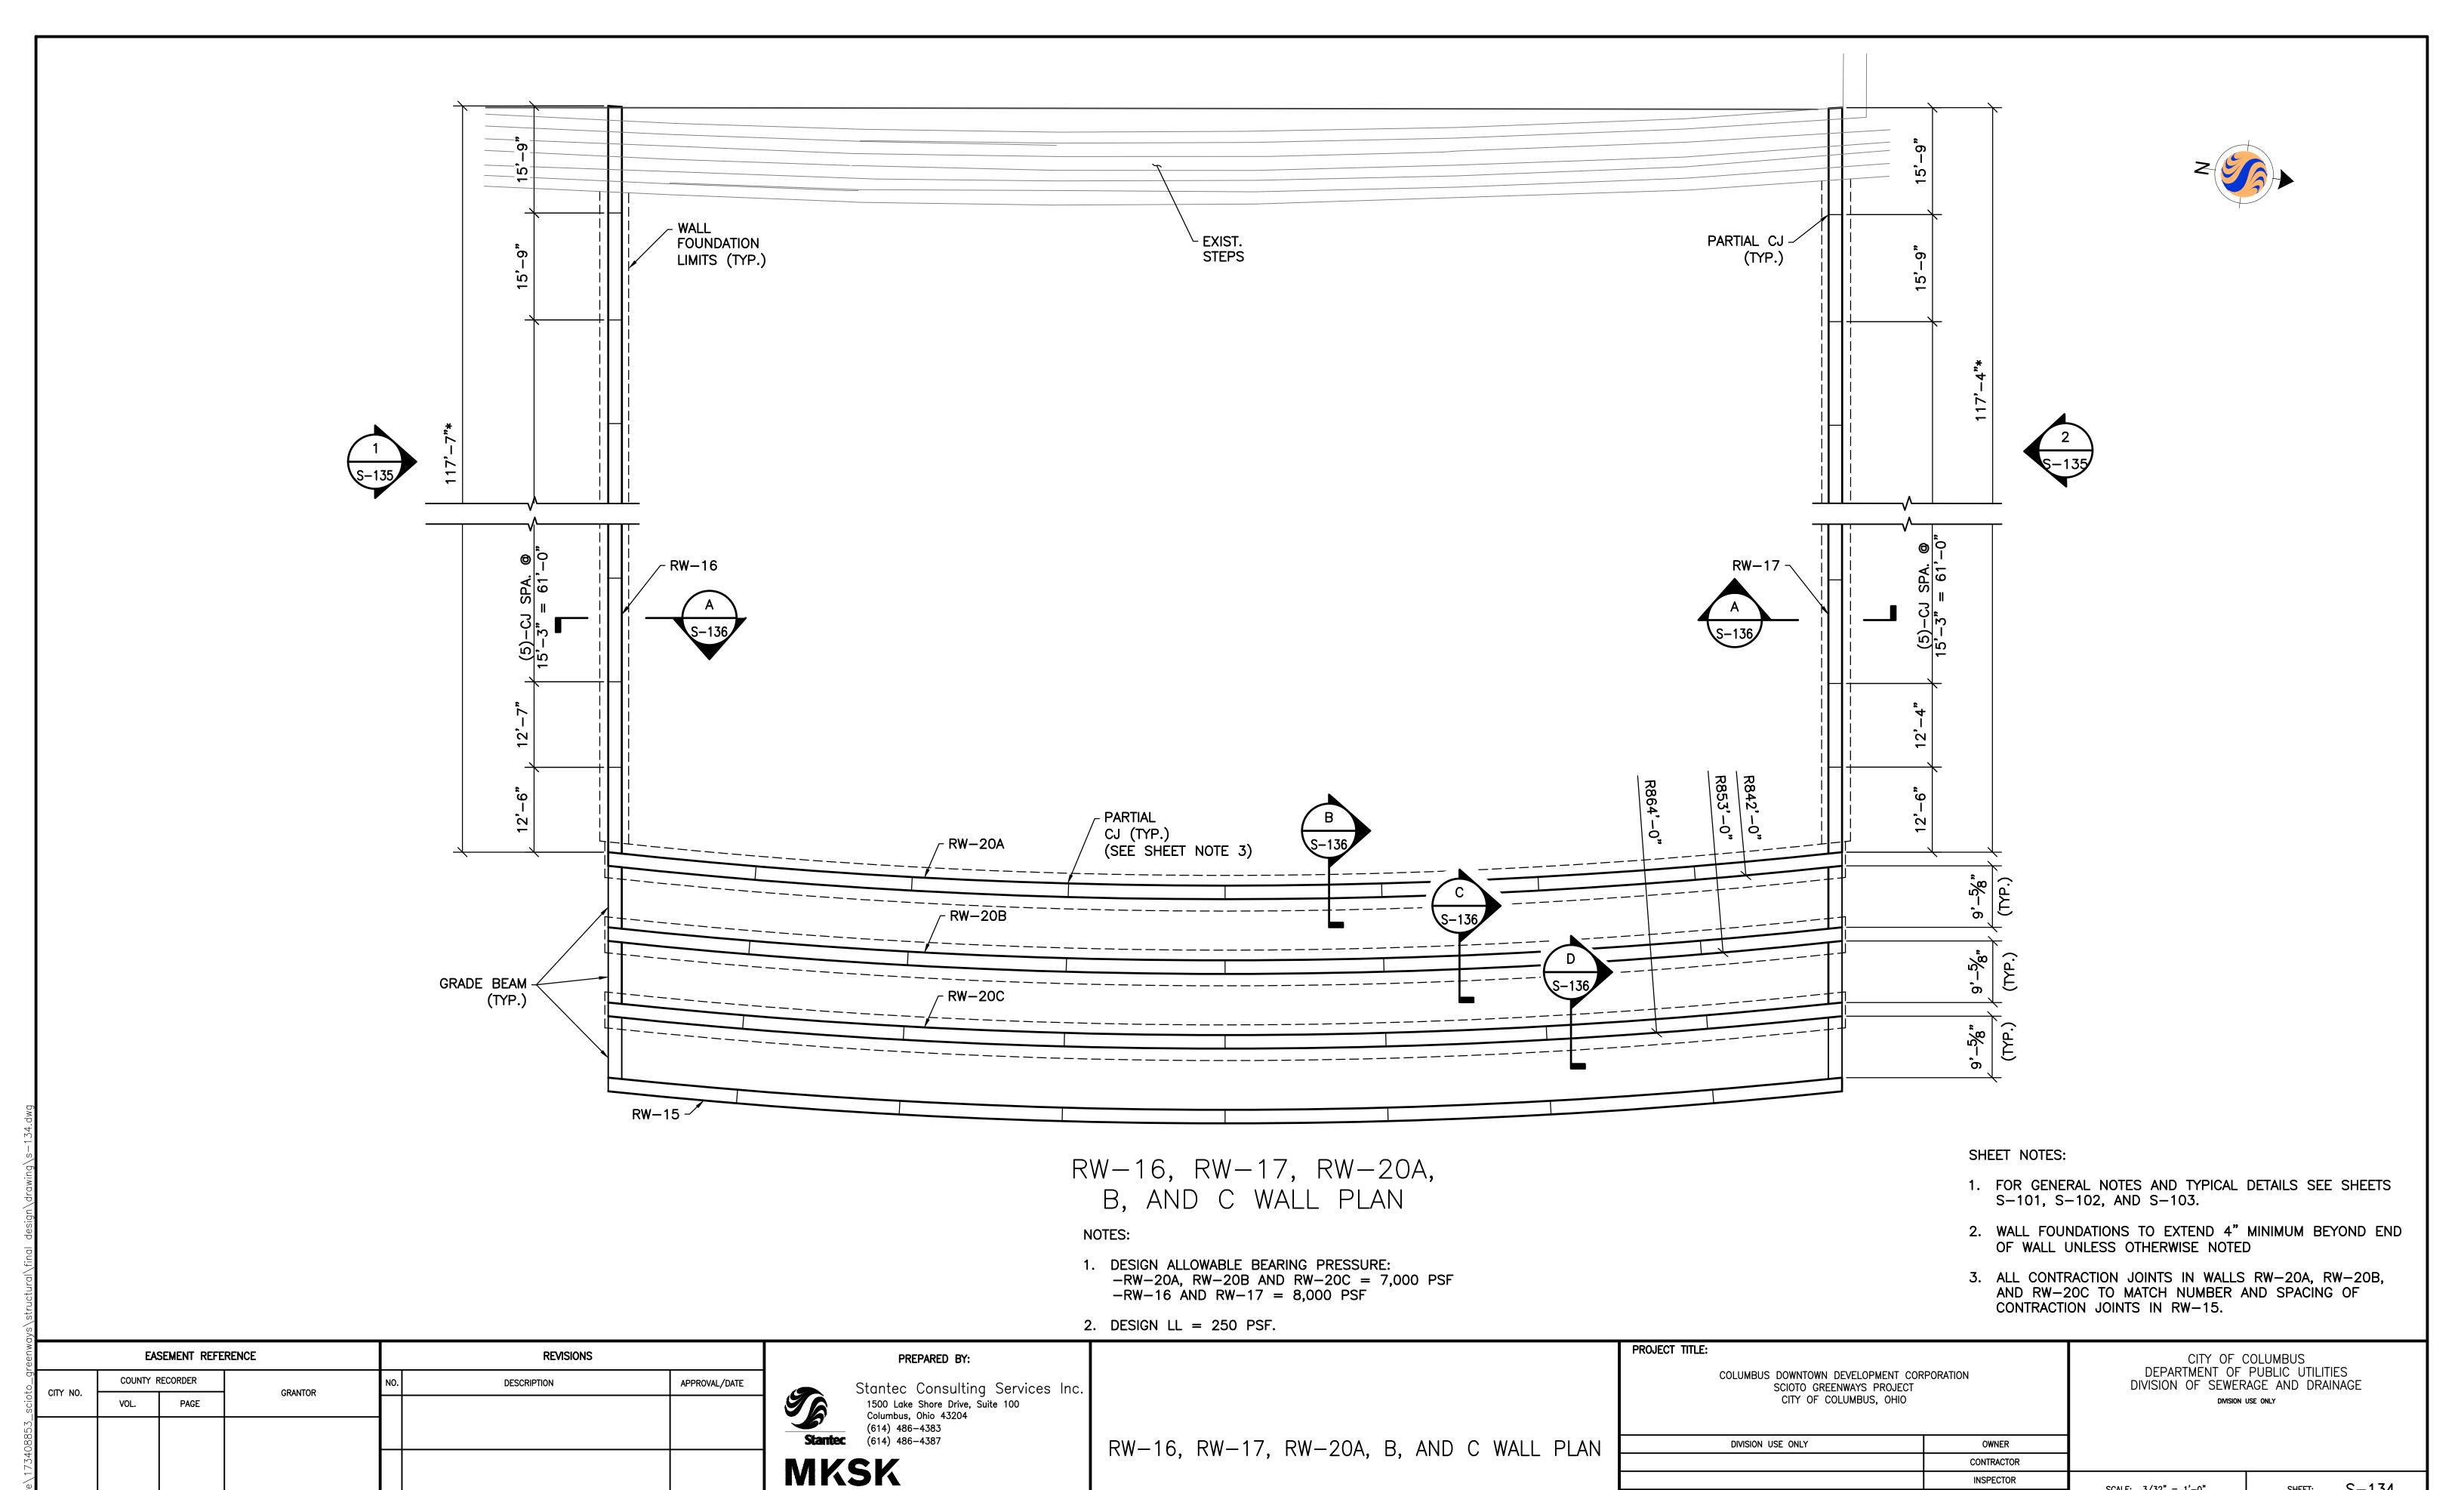

SHEET: S-134

RECORD PLAN NO.

SCALE: 3/32" = 1'-0"


CONTRACT DRAWING NO.


CC-16423

AGREEMENT COMPLETED RPD CKD CLD CON. DR.

INDEX DETAIL

RECORD FILE

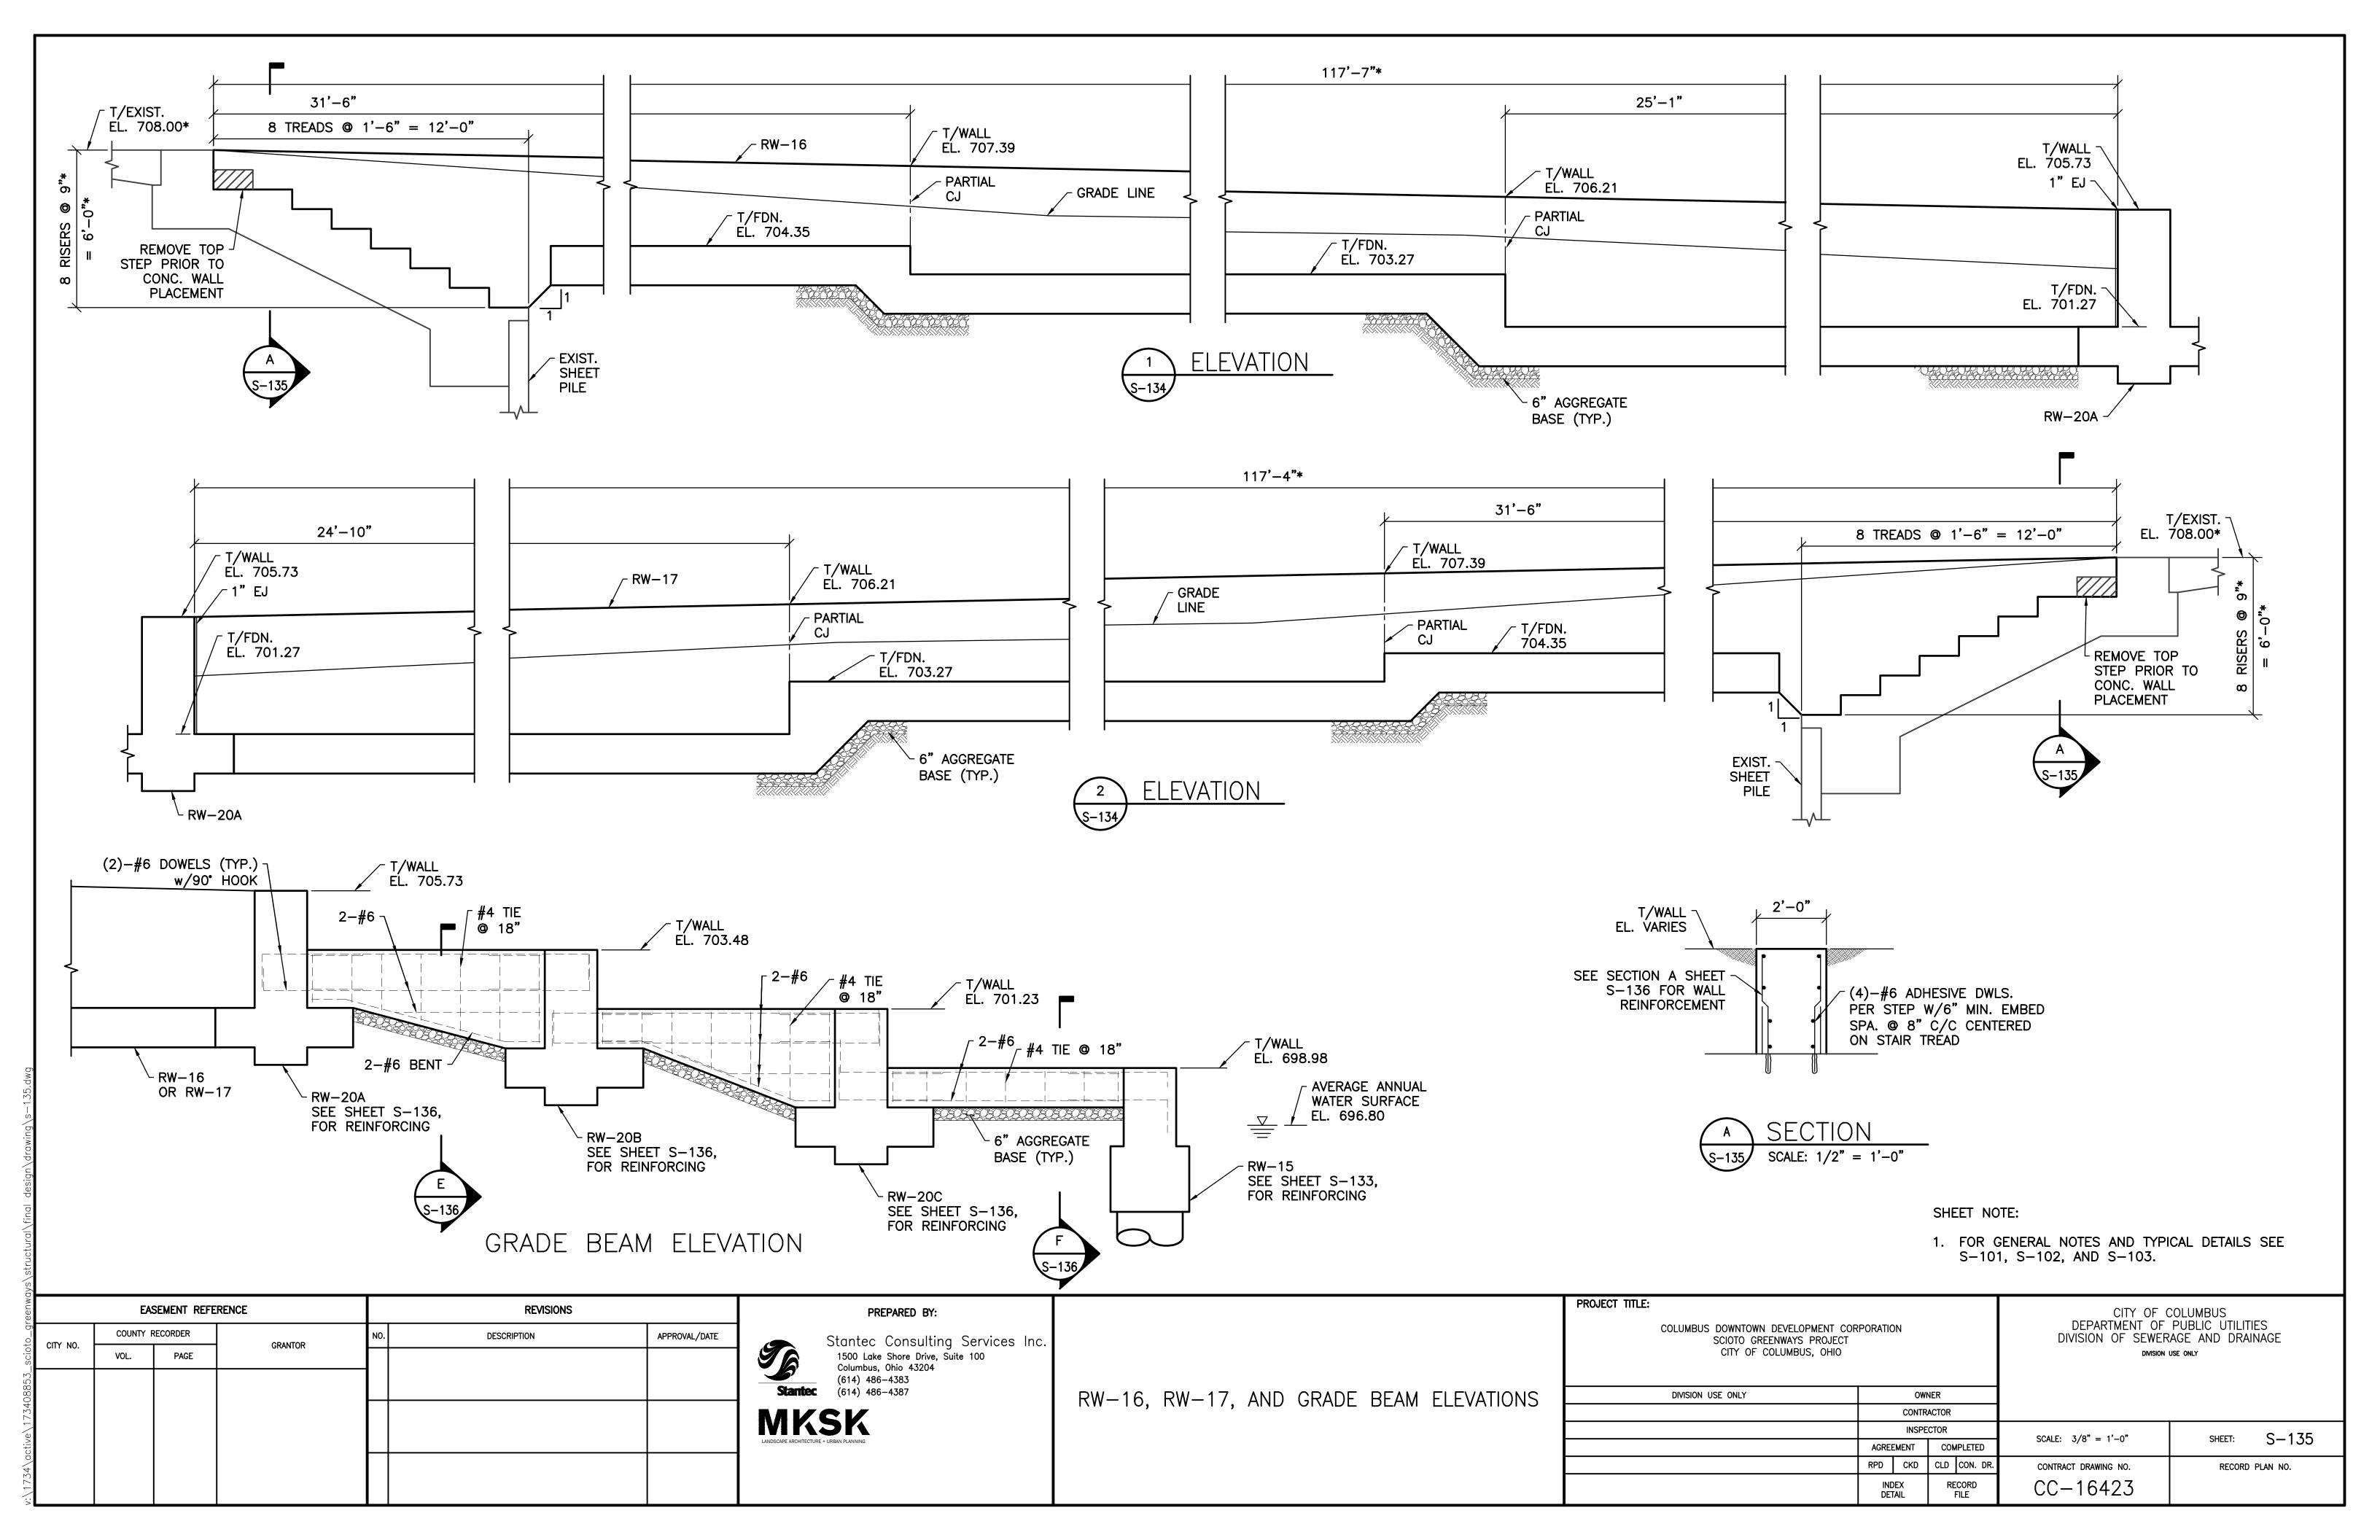

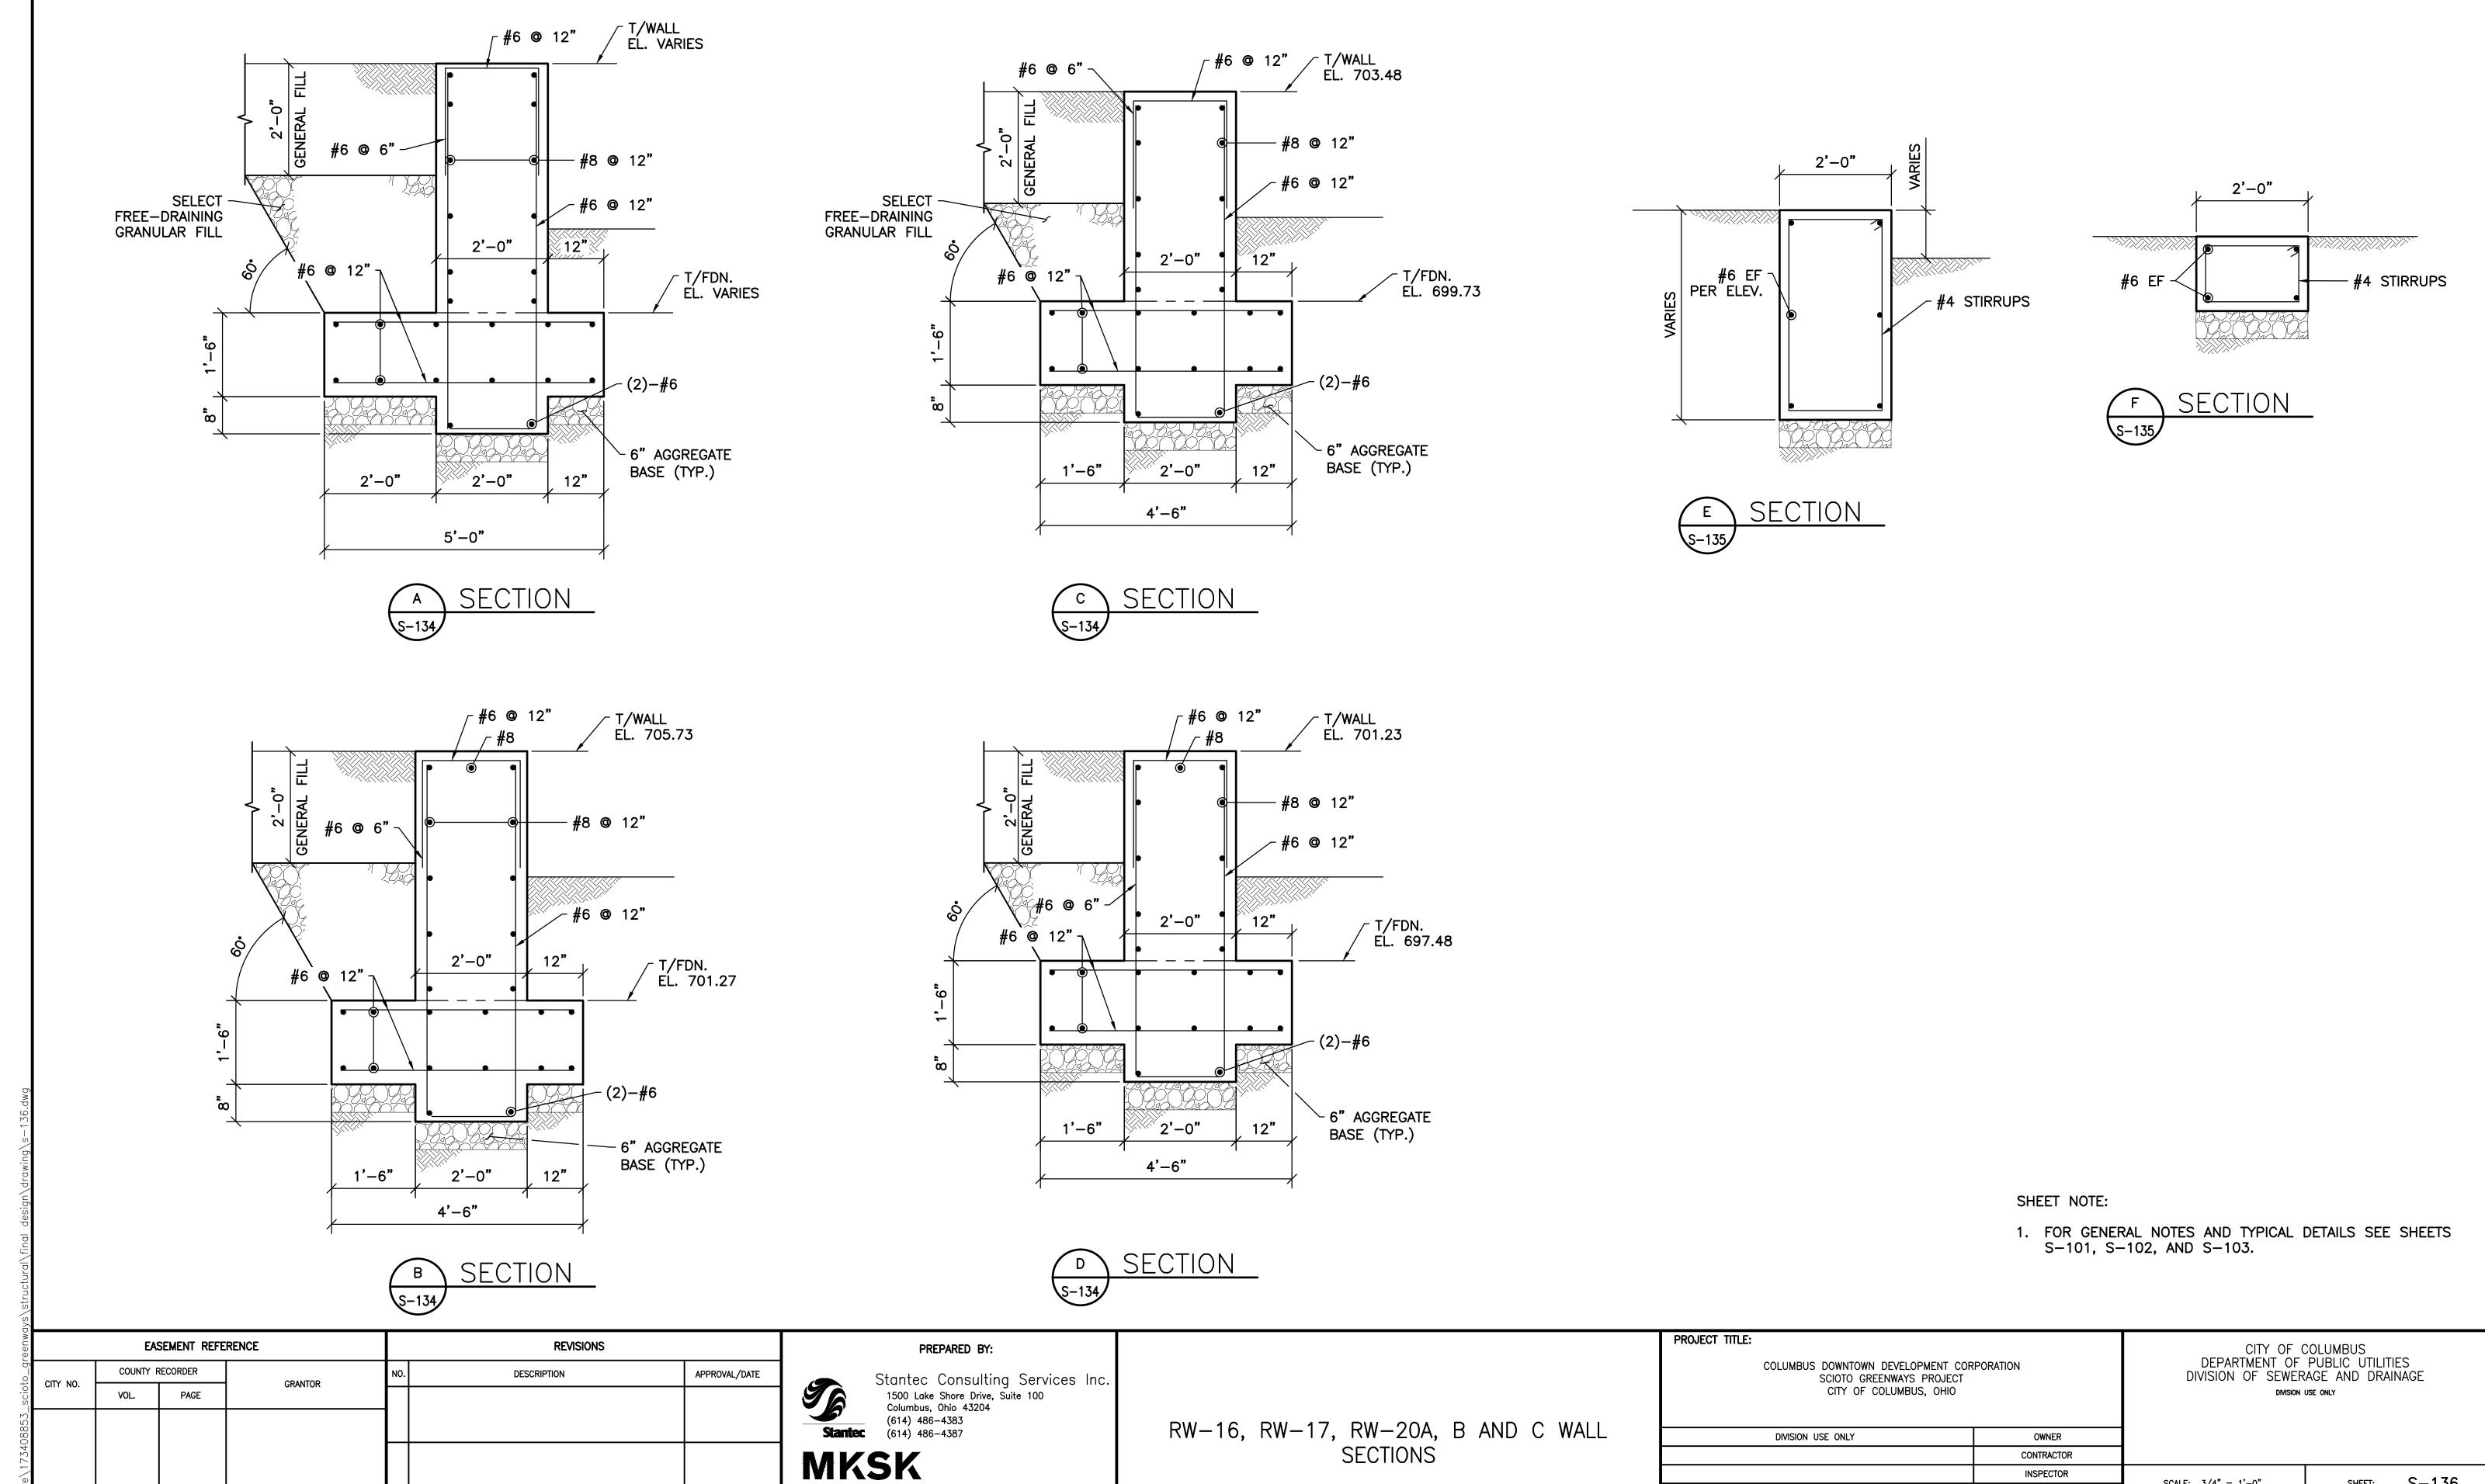

INSPECTOR

AGREEMENT COMPLETED RPD CKD CLD CON. DR.

INDEX DETAIL

RECORD FILE


SCALE: 3/4" = 1'-0"


CONTRACT DRAWING NO.

CC-16423

SHEET: S-136


RECORD PLAN NO.

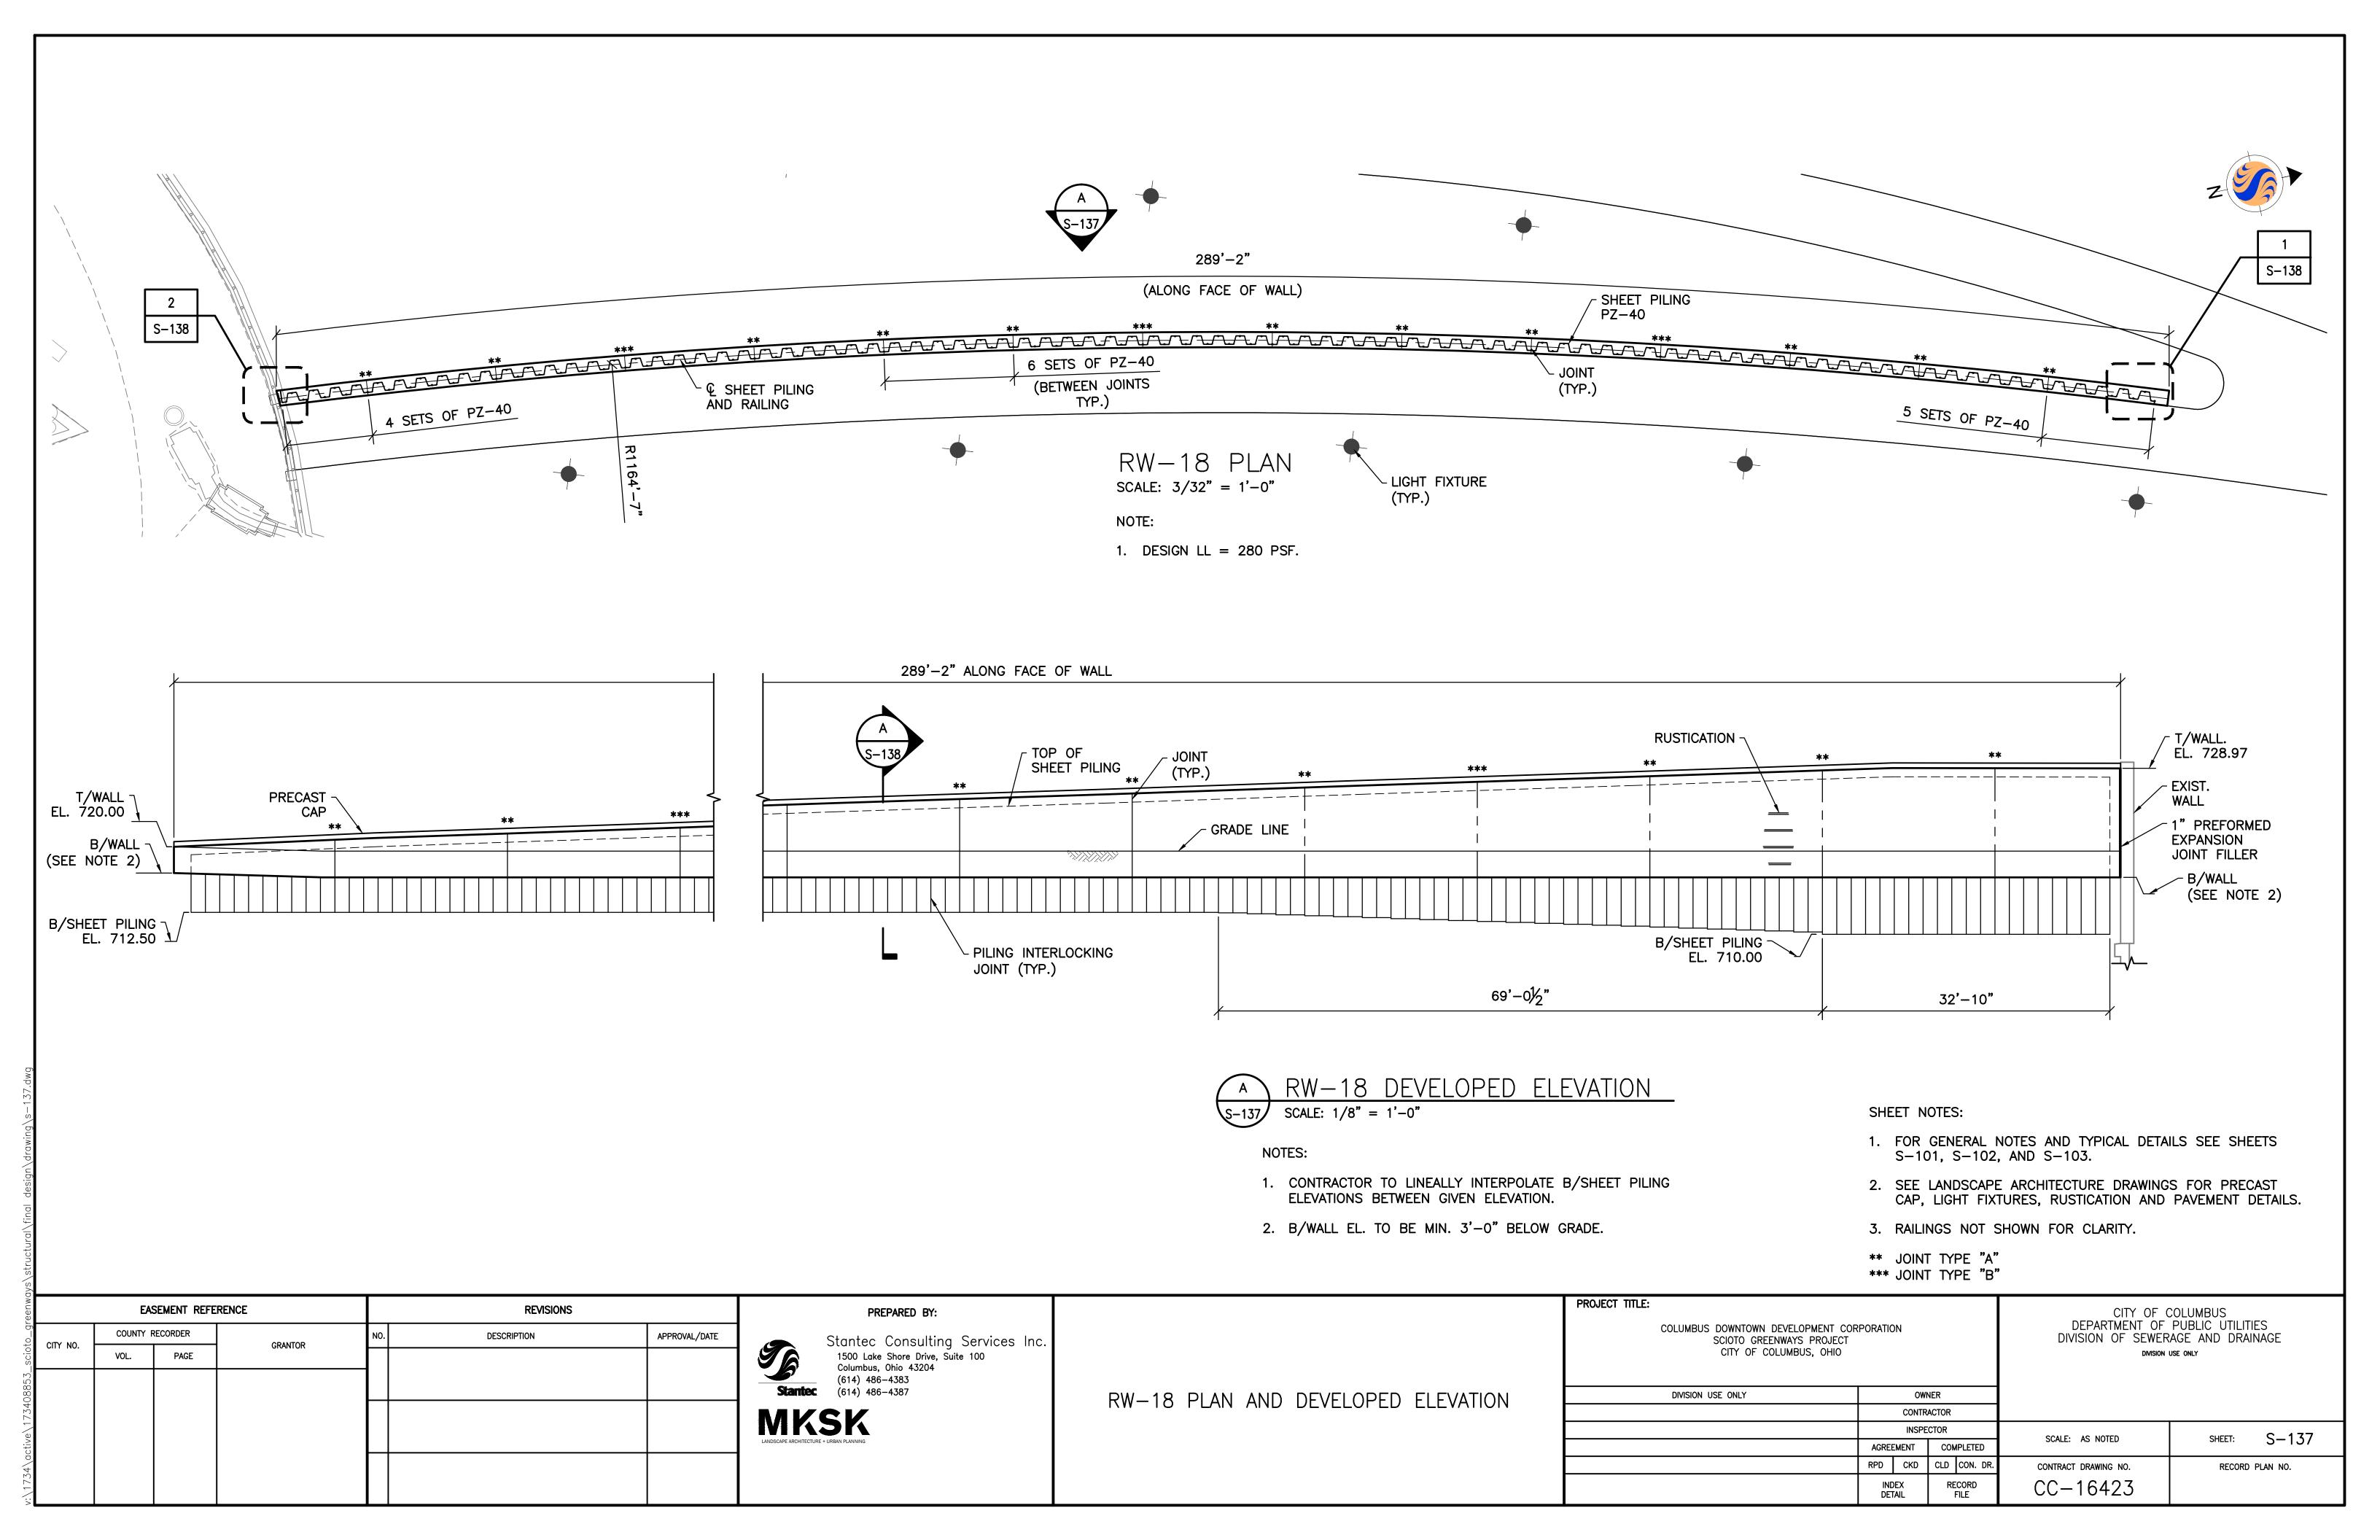


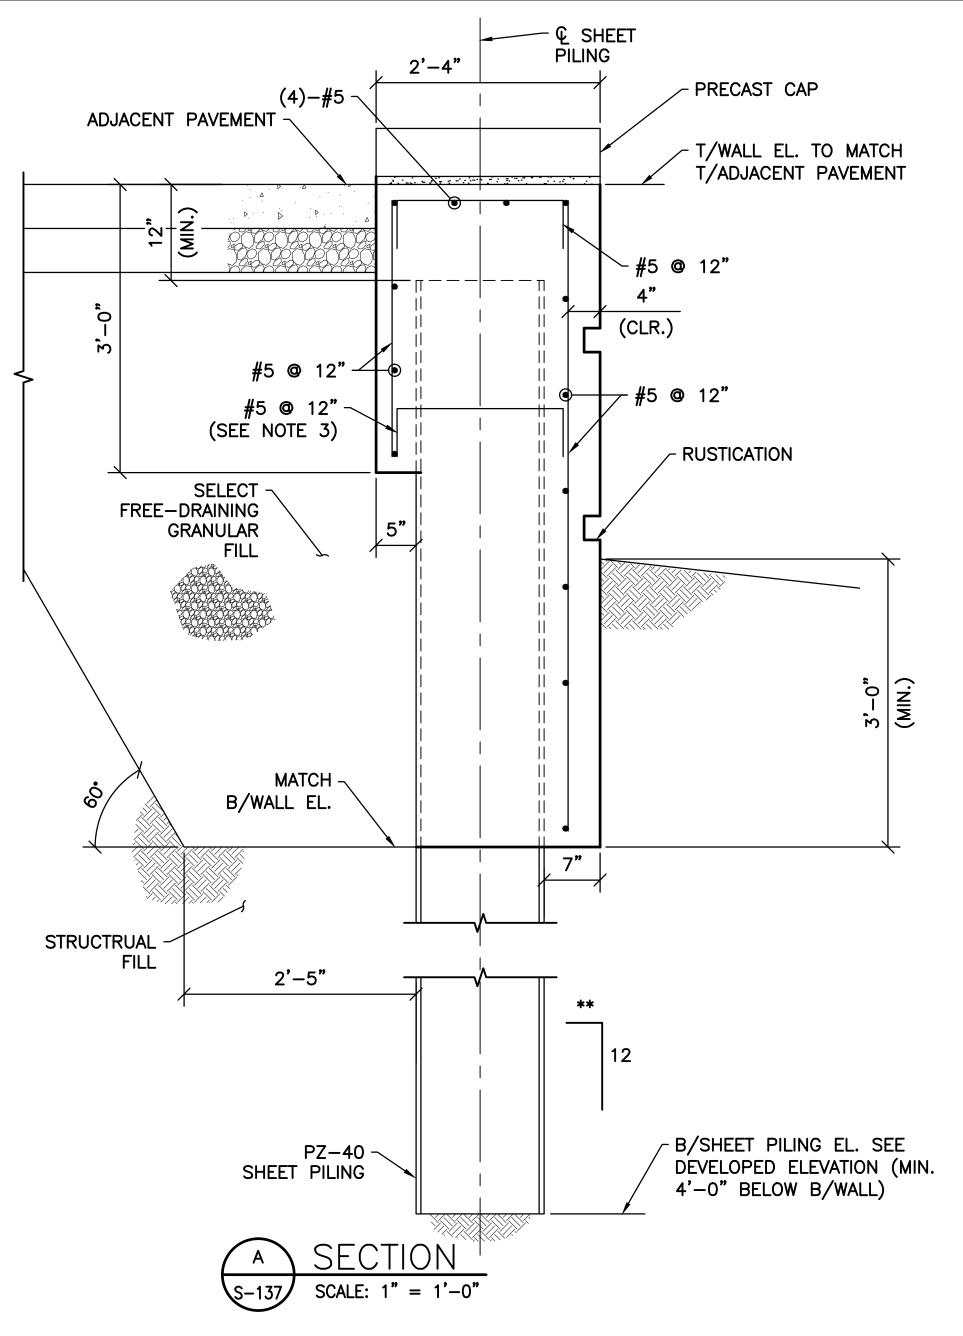



- 1. SEE SHEET S-137 FOR ELEVATION.
- 2. RAILING NOT SHOWN FOR CLARITY.
- 3. BURN HOLES IN SHEET PILING TO PASS REINFORCING.
- ** BATTER SHEET PILE AT 1/8" PER 12" TO ACCOMMODATE DEFLECTION IN WALL. PLACE FILL BEHIND WALL PRIOR TO PLACEMENT OF CONCRETE.

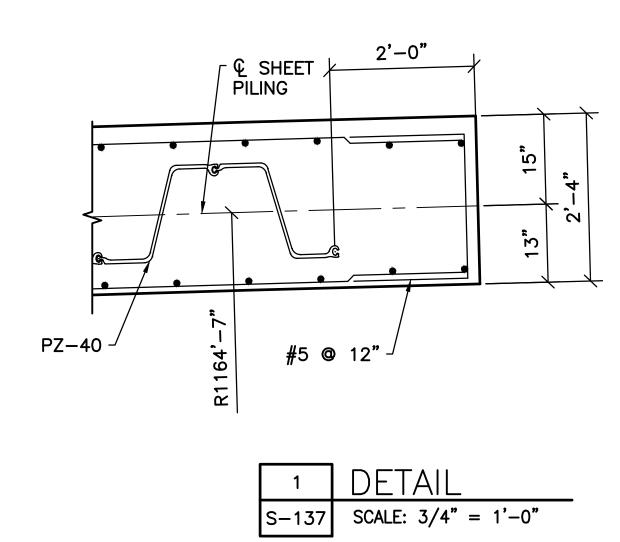

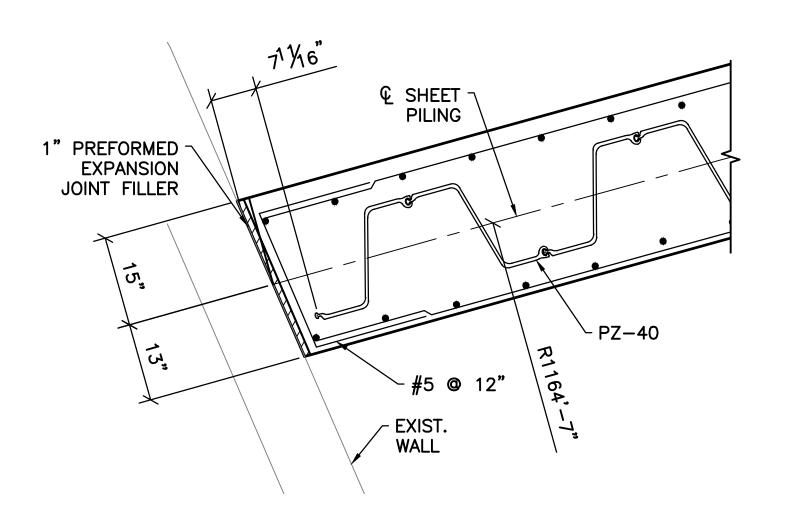


2 DETAIL S-137 SCALE: 3/4" = 1'-0"


SHEET NOTES:

- 1. FOR GENERAL NOTES AND TYPICAL DETAILS SEE SHEETS S-101, S-102, AND S-103.
- 2. SEE LANDSCAPE ARCHITECTURE DRAWINGS FOR ADJACENT PAVEMENT, PRECAST CAP, AND RUSTICATION DETAILS.

eenwe	EASEMENT REFERENCE		ENCE	REVISIONS		PREPARED BY:		PROJECT TITLE:		CITY OF COLUMBUS	
CITY NO	COUNTY RECORDER CITY NO. GRANTOR		CDANITOD	NO. DES	SCRIPTION	APPROVAL/DATE	Stantec Consulting Services Inc.		COLUMBUS DOWNTOWN DEVELOPM SCIOTO GREENWAYS F	MENT CORPORATION ROJECT	CITY OF COLUMBUS DEPARTMENT OF PUBLIC UTILITIES DIVISION OF SEWERAGE AND DRAINAGE
Sciot	VOL.	PAGE	GRANIOR				1500 Lake Shore Drive, Suite 100 Columbus, Ohio 43204		CITY OF COLUMBUS,	OHIO	DIVISION USE ONLY
.0885 							(614) 486–4383 Stantec (614) 486–4387	RW-18 SECTION AND DETAILS	DIVISION USE ONLY	OWNER	
1734							MKSK	TWO TO SECTION THE DETINES		CONTRACTOR	
(e) >							LANDSCAPE ARCHITECTURE + URBAN PLANNING			INSPECTOR	SCALE: AS NOTED SHEET: $S-138$
acti										AGREEMENT COMPLETED	
)/40										RPD CKD CLD CON. DR.	CONTRACT DRAWING NO. RECORD PLAN NO.
1/3										INDEX RECORD	CC-16423


ays\structural\final_design\drawinq\s-138.dwg

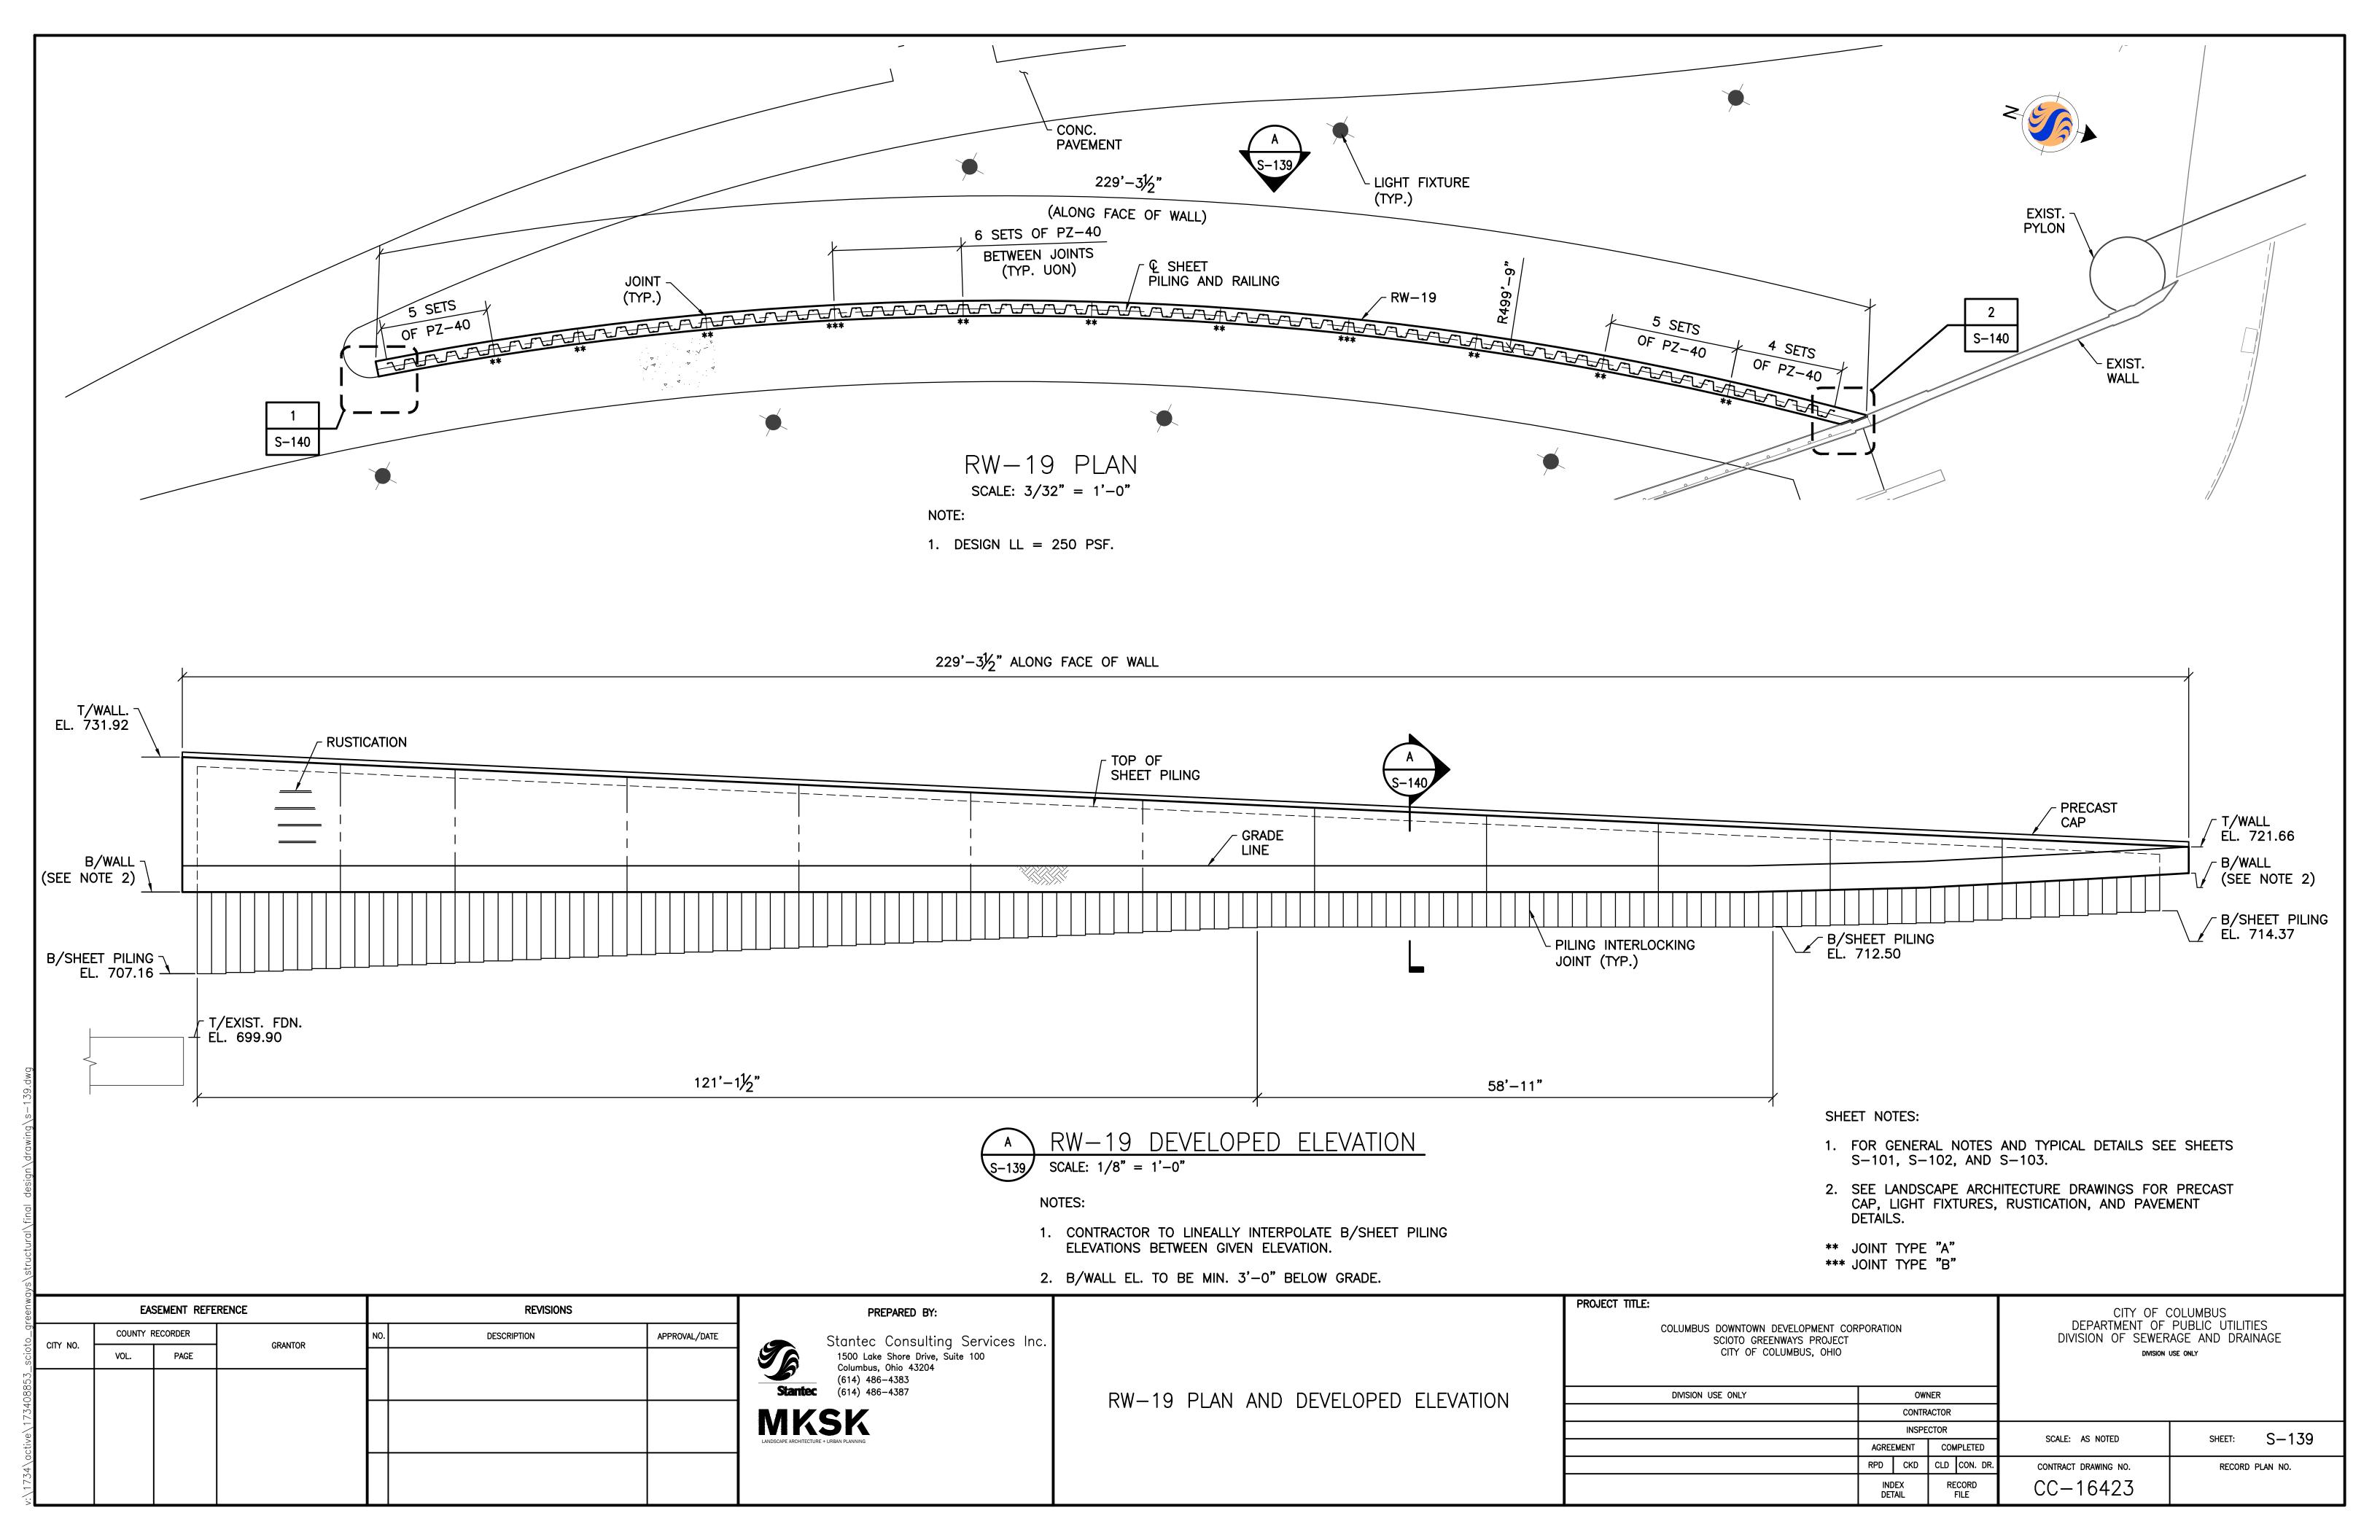

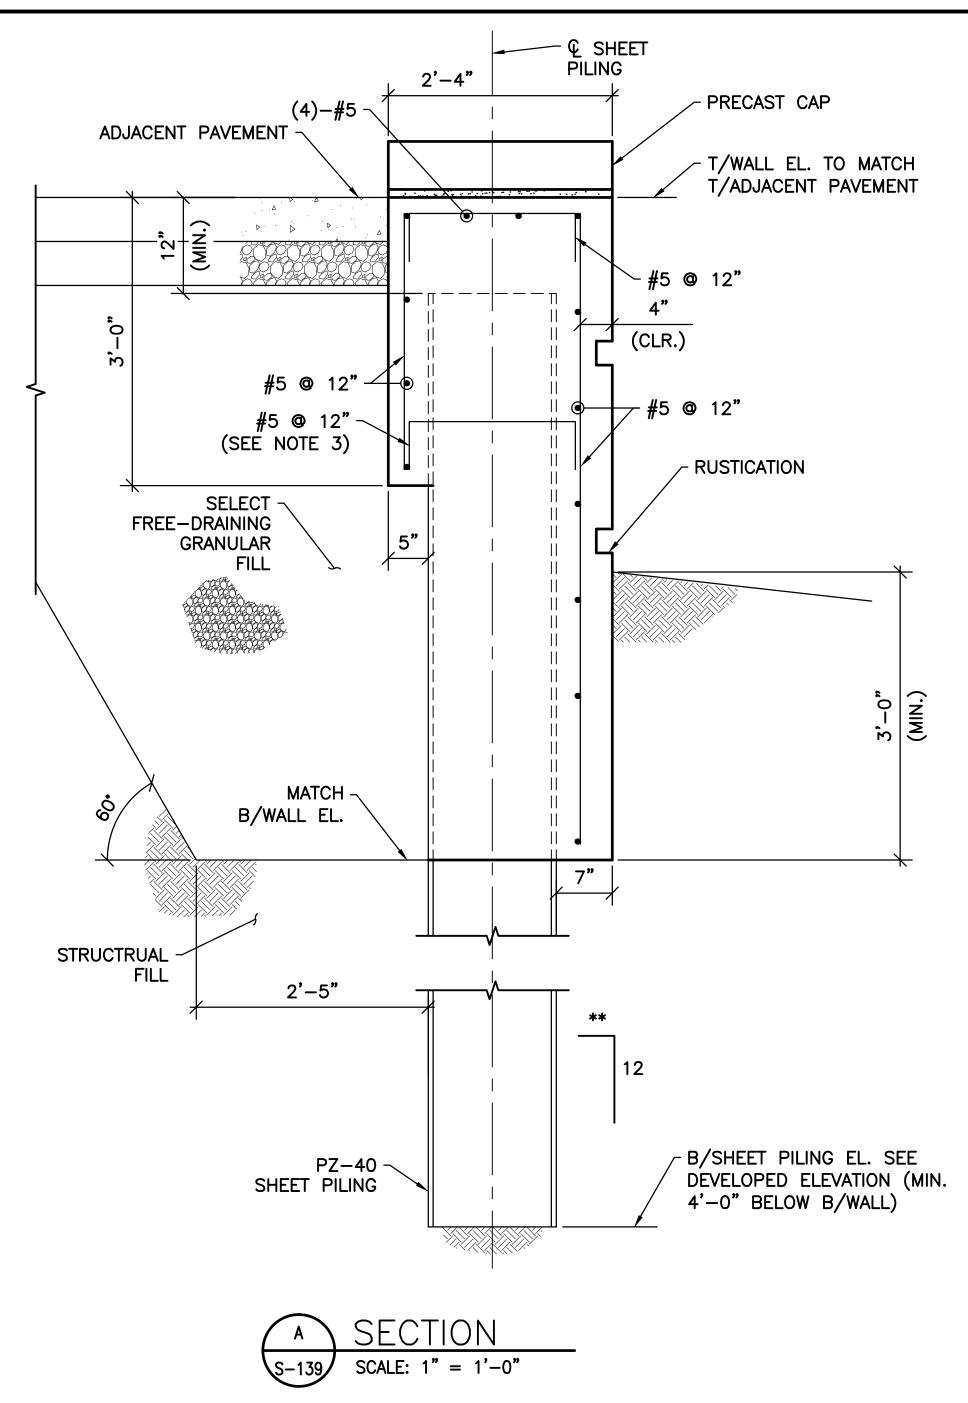


NOTES:

- 1. SEE SHEET S-139 FOR ELEVATION.
- 2. RAILING NOT SHOWN FOR CLARITY.
- 3. BURN HOLES IN SHEET PILING TO PASS REINFORCING.
- ** BATTER SHEET PILE AT 1/8" PER 12" TO ACCOMMODATE DEFLECTION IN WALL. PLACE FILL BEHIND WALL PRIOR TO PLACEMENT OF CONCRETE.

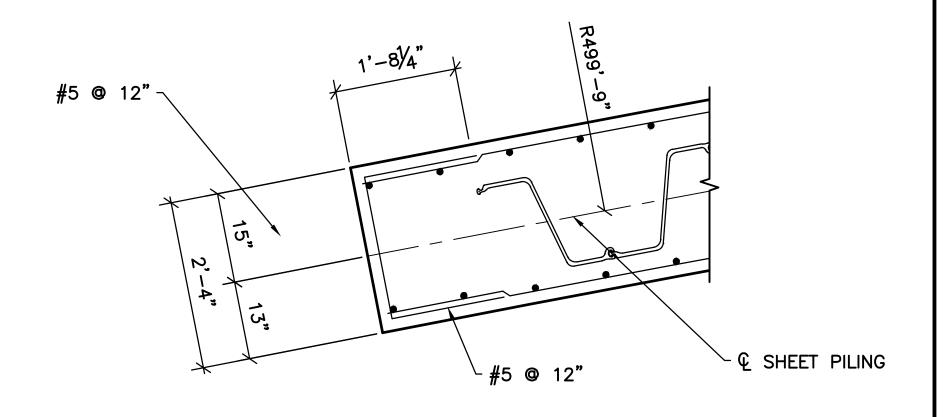



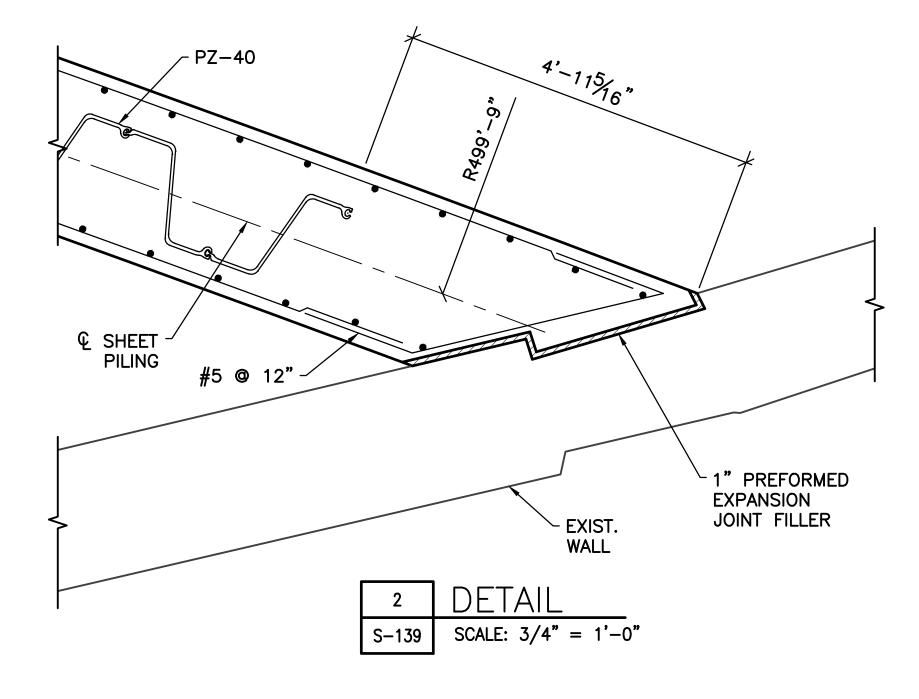

SHEET NOTES:

- 1. FOR GENERAL NOTES AND TYPICAL DETAILS SEE SHEETS S-101, S-102, AND S-103.
- 2. SEE LANDSCAPE ARCHITECTURE DRAWINGS FOR ADJACENT PAVEMENT, PRECAST CAP, AND RUSTICATION DETAILS.

		EA:	SEMENT REFE	ERENCE	REVISIONS				
9-6	CITY NO.	COUNTY F	RECORDER	GRANTOR		DESCRIPTION	APPROVAL/DATE		
	CITT NO.	VOL.	PAGE	GRANTOR					
;									

Stantec Consulting Services Inc.

1500 Lake Shore Drive, Suite 100
Columbus, Ohio 43204
(614) 486-4383
(614) 486-4387


MKSK


LANDSCAPE ARCHITECTURE + URBAN PLANNING

PREPARED BY:

RW-19 SECTIONS AND DETAILS

PROJECT TITLE: COLUMBUS DOWNTOWN DEVELOPMENT CO SCIOTO GREENWAYS PROJECT CITY OF COLUMBUS, OHIO	RPORATIO	ON			DEPARTMENT OF	AGE AND DRAINAGE
DIVISION USE ONLY		IWO	NER			
	CONTRACTOR					
		INSPE	CTOR		SCALE: AS NOTED	SHEET: S-140
	AGRE	EMENT	СОМ	IPLETED	SCALE: AS NOTED	3-140
	RPD	CKD	CLD	CON. DR.	CONTRACT DRAWING NO.	RECORD PLAN NO.
		INDEX RECORD DETAIL FILE			CC-16423	

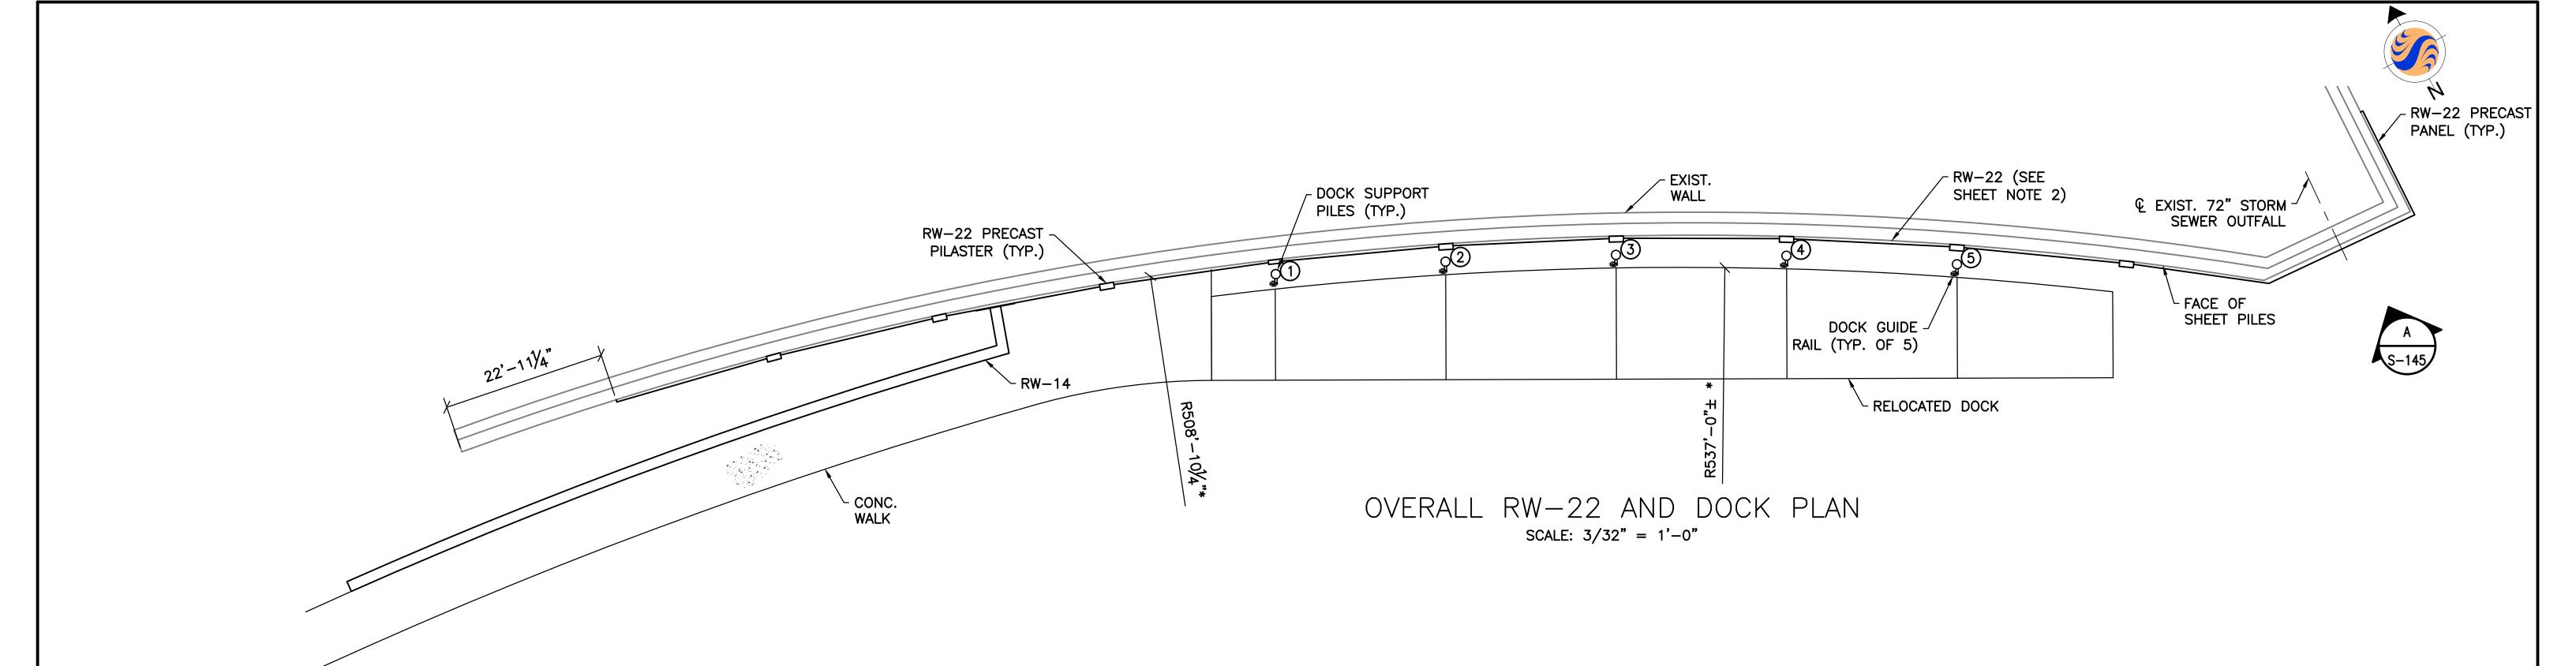

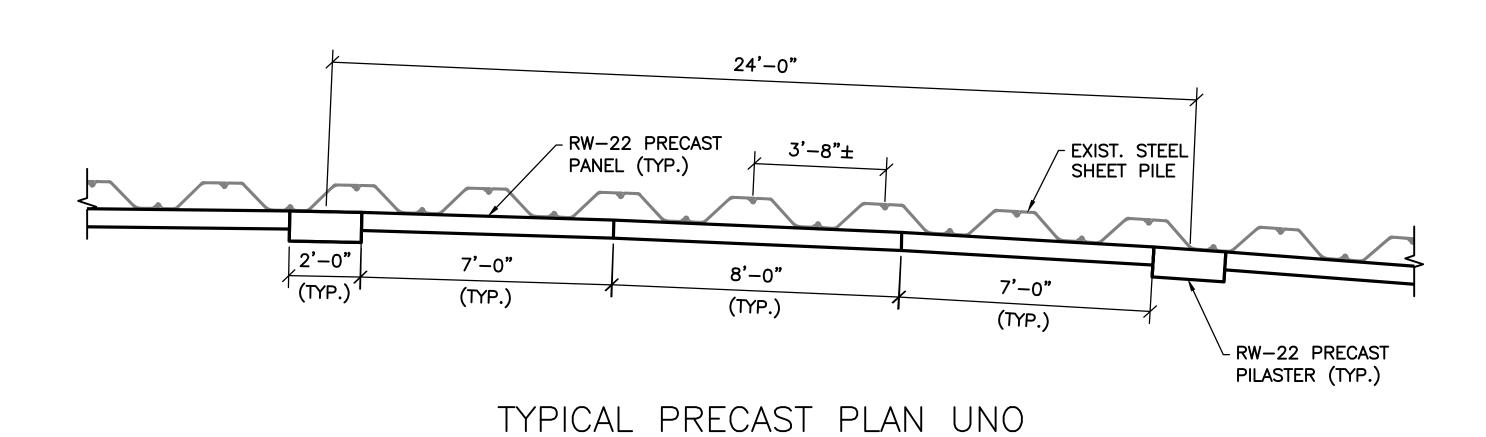

NOTE:

1. SEE ADDITIONAL PRECAST DETAILS AT 72" STORM SEWER OUTFALL.


SCALE: 3/8" = 1'-0"


SHEET NOTES:

- 1. FOR GENERAL NOTES AND TYPICAL DETAILS SEE S-101, S-102, AND S-103.
- 2. FOR LIMITS OF RW-22 SEE LANDSCAPE ARCHITECTURE DRAWINGS.
- 3. ALL DOCK SUPPORT PILES ARE 16" DIA. x 5/8" THICK CAST-IN-PLACE NON-REINFORCED CONCRETE PILES.
- 4. MAXIMUM ALLOWABLE LATERAL CAPACITY OF THE DOCK SUPPORT PILES = 12 KIPS.
- 5. MAXIMUM ALLOWABLE DOCK SUPPORT PILE DEFLECTION IS 4.67" AT TOP OF PILE.

сепис	EASEMENT REFERENCE		:	R	REVISIONS	PREPARED BY:		PROJECT TITLE:		CITY OF COLUMBUS DEPARTMENT OF PUBLIC UTILITIES		
CITY NO.	COUNTY RECORDER VOL. PAGE GRANTOR		CRANTOR	NO. DESCRIPTION APPROVAL/DATE		Stantec Consulting Services Inc.		COLUMBUS DOWNTOWN DEVELOF SCIOTO GREENWAYS CITY OF COLUMBUS	PMENT CORPORATION PROJECT	DEPARTMENT OF PUBLIC UTILITIES DIVISION OF SEWERAGE AND DRAINAGE DIVISION USE ONLY		
SCIT NO.			GNANION			1500 Lake Shore Drive, Suite 100 Columbus, Ohio 43204 (614) 486-4383		CITY OF COLUMBUS				
8853						(614) 486–4383 Stantec (614) 486–4387		DIVISION USE ONLY	OWNER			
7340						NAVCV	RW-22 AND DOCK PLAN	<u> </u>	CONTRACTOR			
(e \ 1						MKSK LANDSCAPE ARCHITECTURE + URBAN PLANNING			INSPECTOR	SCALE: AS NOTED	SHEET: S-141	
activ						LANDSCAPE ARCHITECTURE + ORBAN PLANNING			AGREEMENT COMPLETED		3 1 7 1	
34/0									RPD CKD CLD CON. DR.	CONTRACT DRAWING NO.	RECORD PLAN NO.	
/17.									INDEX RECORD DETAIL FILE	CC-16423		

ctive\173408853_scioto_greenways\structural\final_design\drawing\s-141.

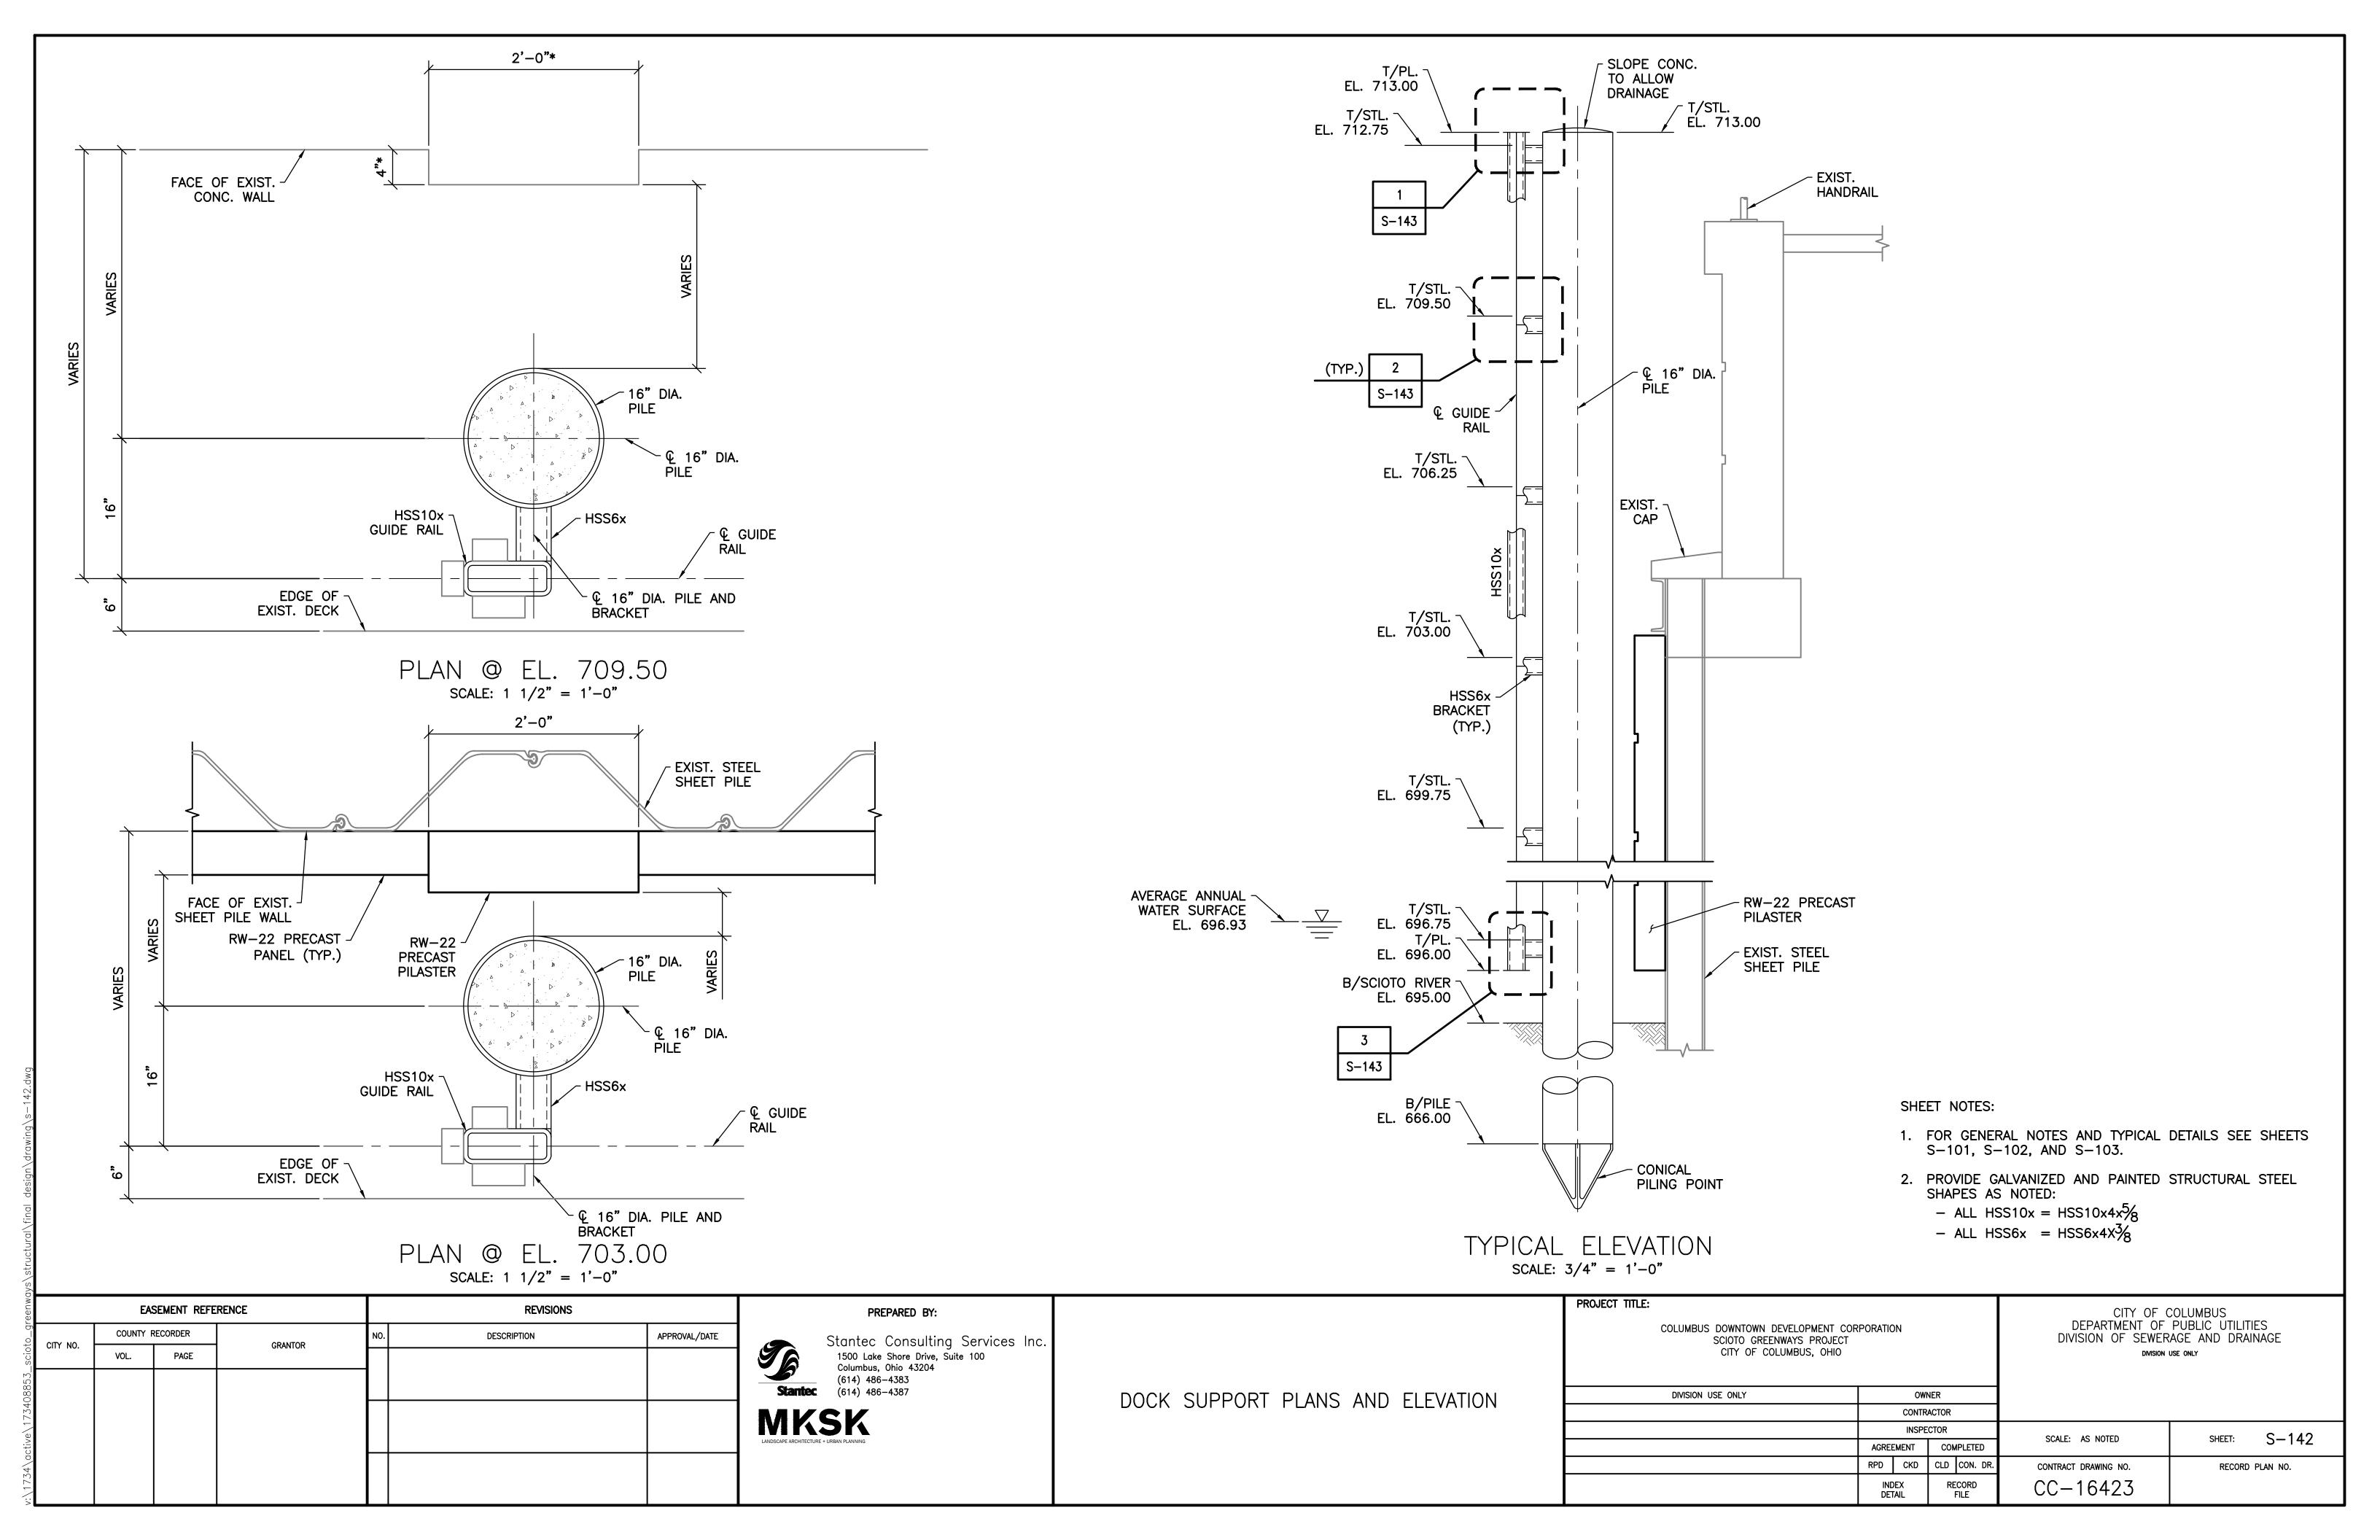

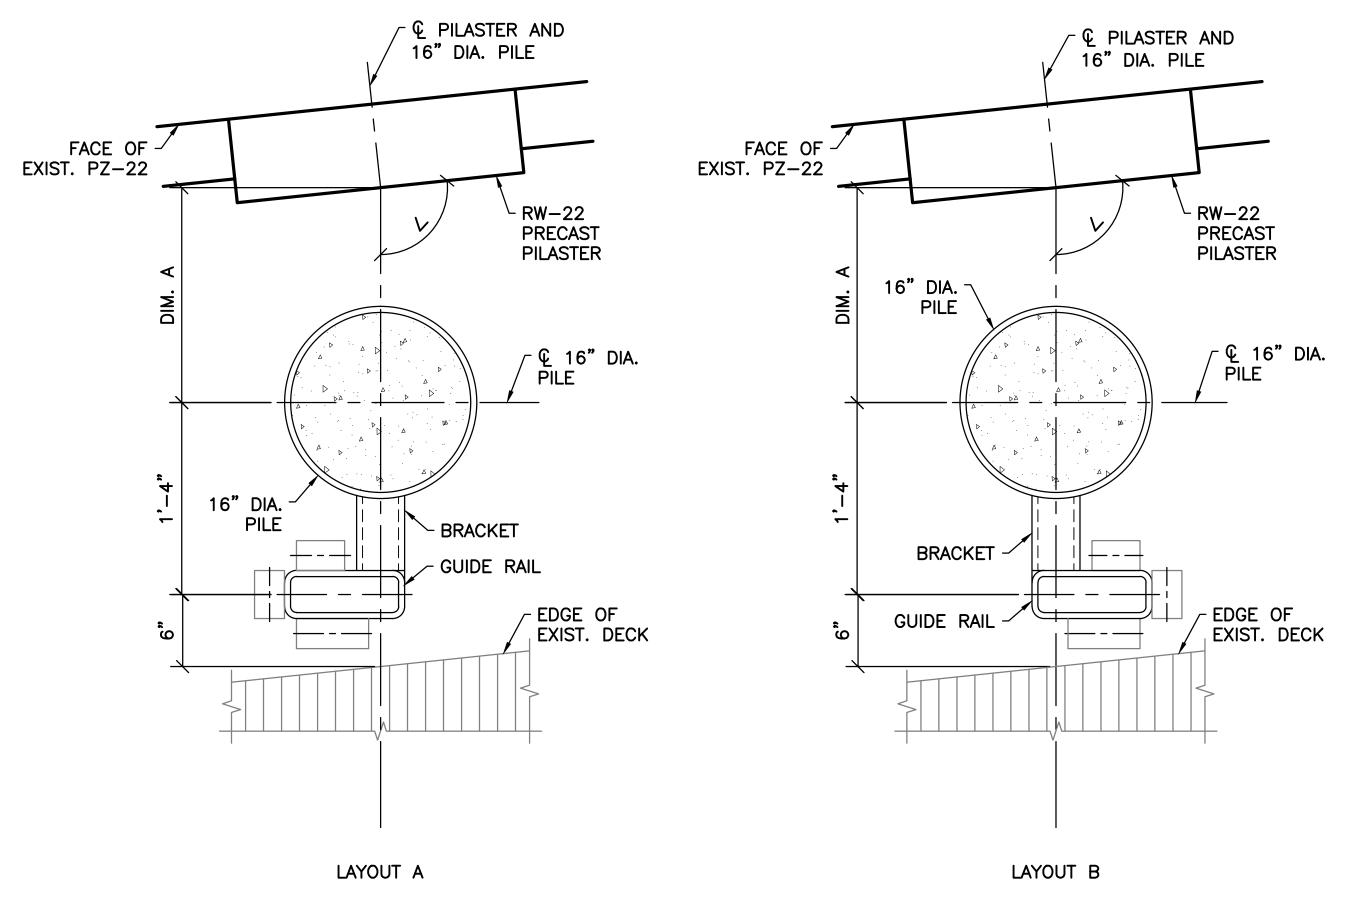


DOCK SUPPORT LAYOUT SCALE: 1 1/2" = 1'


NOTES:


- 1. LAYOUT A APPLIES TO PILE 1, PILE 3, AND PILE 5. LAYOUT B APPLIES TO PILE 2 AND PILE 4.
- 2. SEE DOCK SUPPORT TABLE FOR ADDITIONAL INFORMATION.

DOCK SUPPORT TABLE										
PILE NO.	DIM. A	ANGLE ∠								
1	13"	96.6 °								
2	15"	93.9°								
3	1'-6"	91.2°								
4	1'-8"	88.6°								
5	1'-11"	85.9°								

3. CONTRACTOR SHALL FIELD VERIFY ALL DOCK SUPPORT LAYOUT DIMENSIONS PRIOR TO INSTALLATION OF PILES.

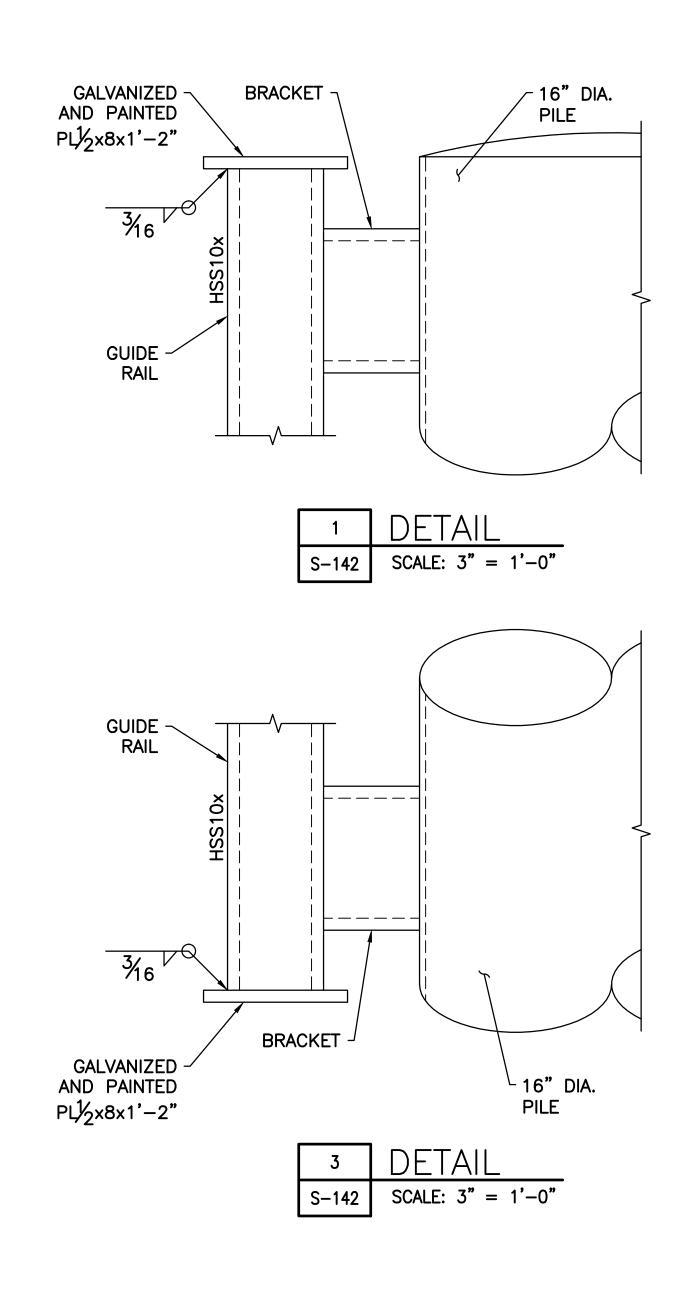

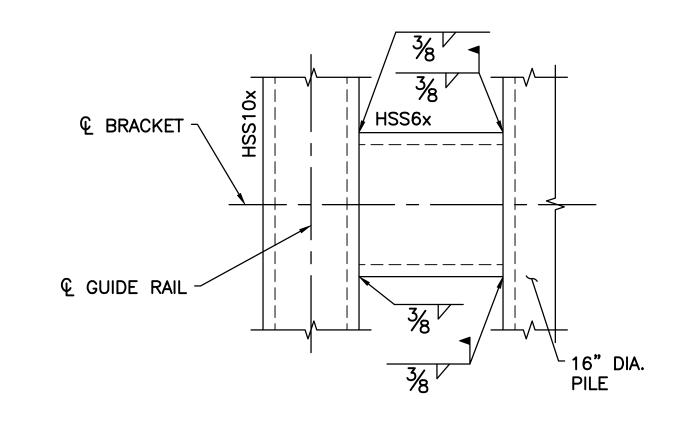

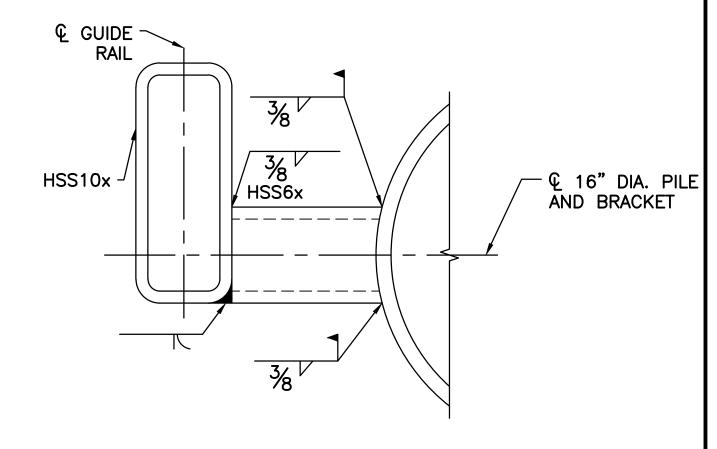


2	DETAIL
S-142	SCALE: $3'' = 1'-0''$


SHEET NOTE:


1. FOR GENERAL NOTES AND TYPICAL DETAILS SEE SHEETS S-101, S-102, AND S-103.

EASEMENT REFERENCE		ERENCE	REVISIONS		PREPARED BY:		PROJECT TITLE:		CITY OF C	COLUMBUS	
COUNTY RECORDER CITY NO. GRANTOR		CDANTOD	NO. DESCRIPTION	APPROVAL/DATE	Stantec Consulting Services Inc.		COLUMBUS DOWNTOWN DEVELOPI SCIOTO GREENWAYS F	CITY OF COLUMBUS DEPARTMENT OF PUBLIC UTILITIES DIVISION OF SEWERAGE AND DRAINAGE			
CIT NO.	CITY NO. GRANTOR VOL. PAGE		GRANTOR	-		1500 Lake Shore Drive, Suite 100 Columbus, Ohio 43204		CITY OF COLUMBUS,	OHIO	DIVISION (
						(614) 486–4383 Stantec (614) 486–4387	DOCK SUPPORT RAIL DETAILS	DIVISION USE ONLY	OWNER		
						MKSK	DOCK SOLLOKI IVAIL DETAILS		CONTRACTOR		
									INSPECTOR	SCALE: AS NOTED	SHEET: S-143
5						LANDSCAPE ARCHITECTURE + URBAN PLANNING			AGREEMENT COMPLETED	SOME. AS NOTES	3-149
-									RPD CKD CLD CON. DR.	CONTRACT DRAWING NO.	RECORD PLAN NO.
									INDEX RECORD DETAIL FILE	CC-16423	

53_scioto_greenways\structural\final_design\drawing\s-143.dwg

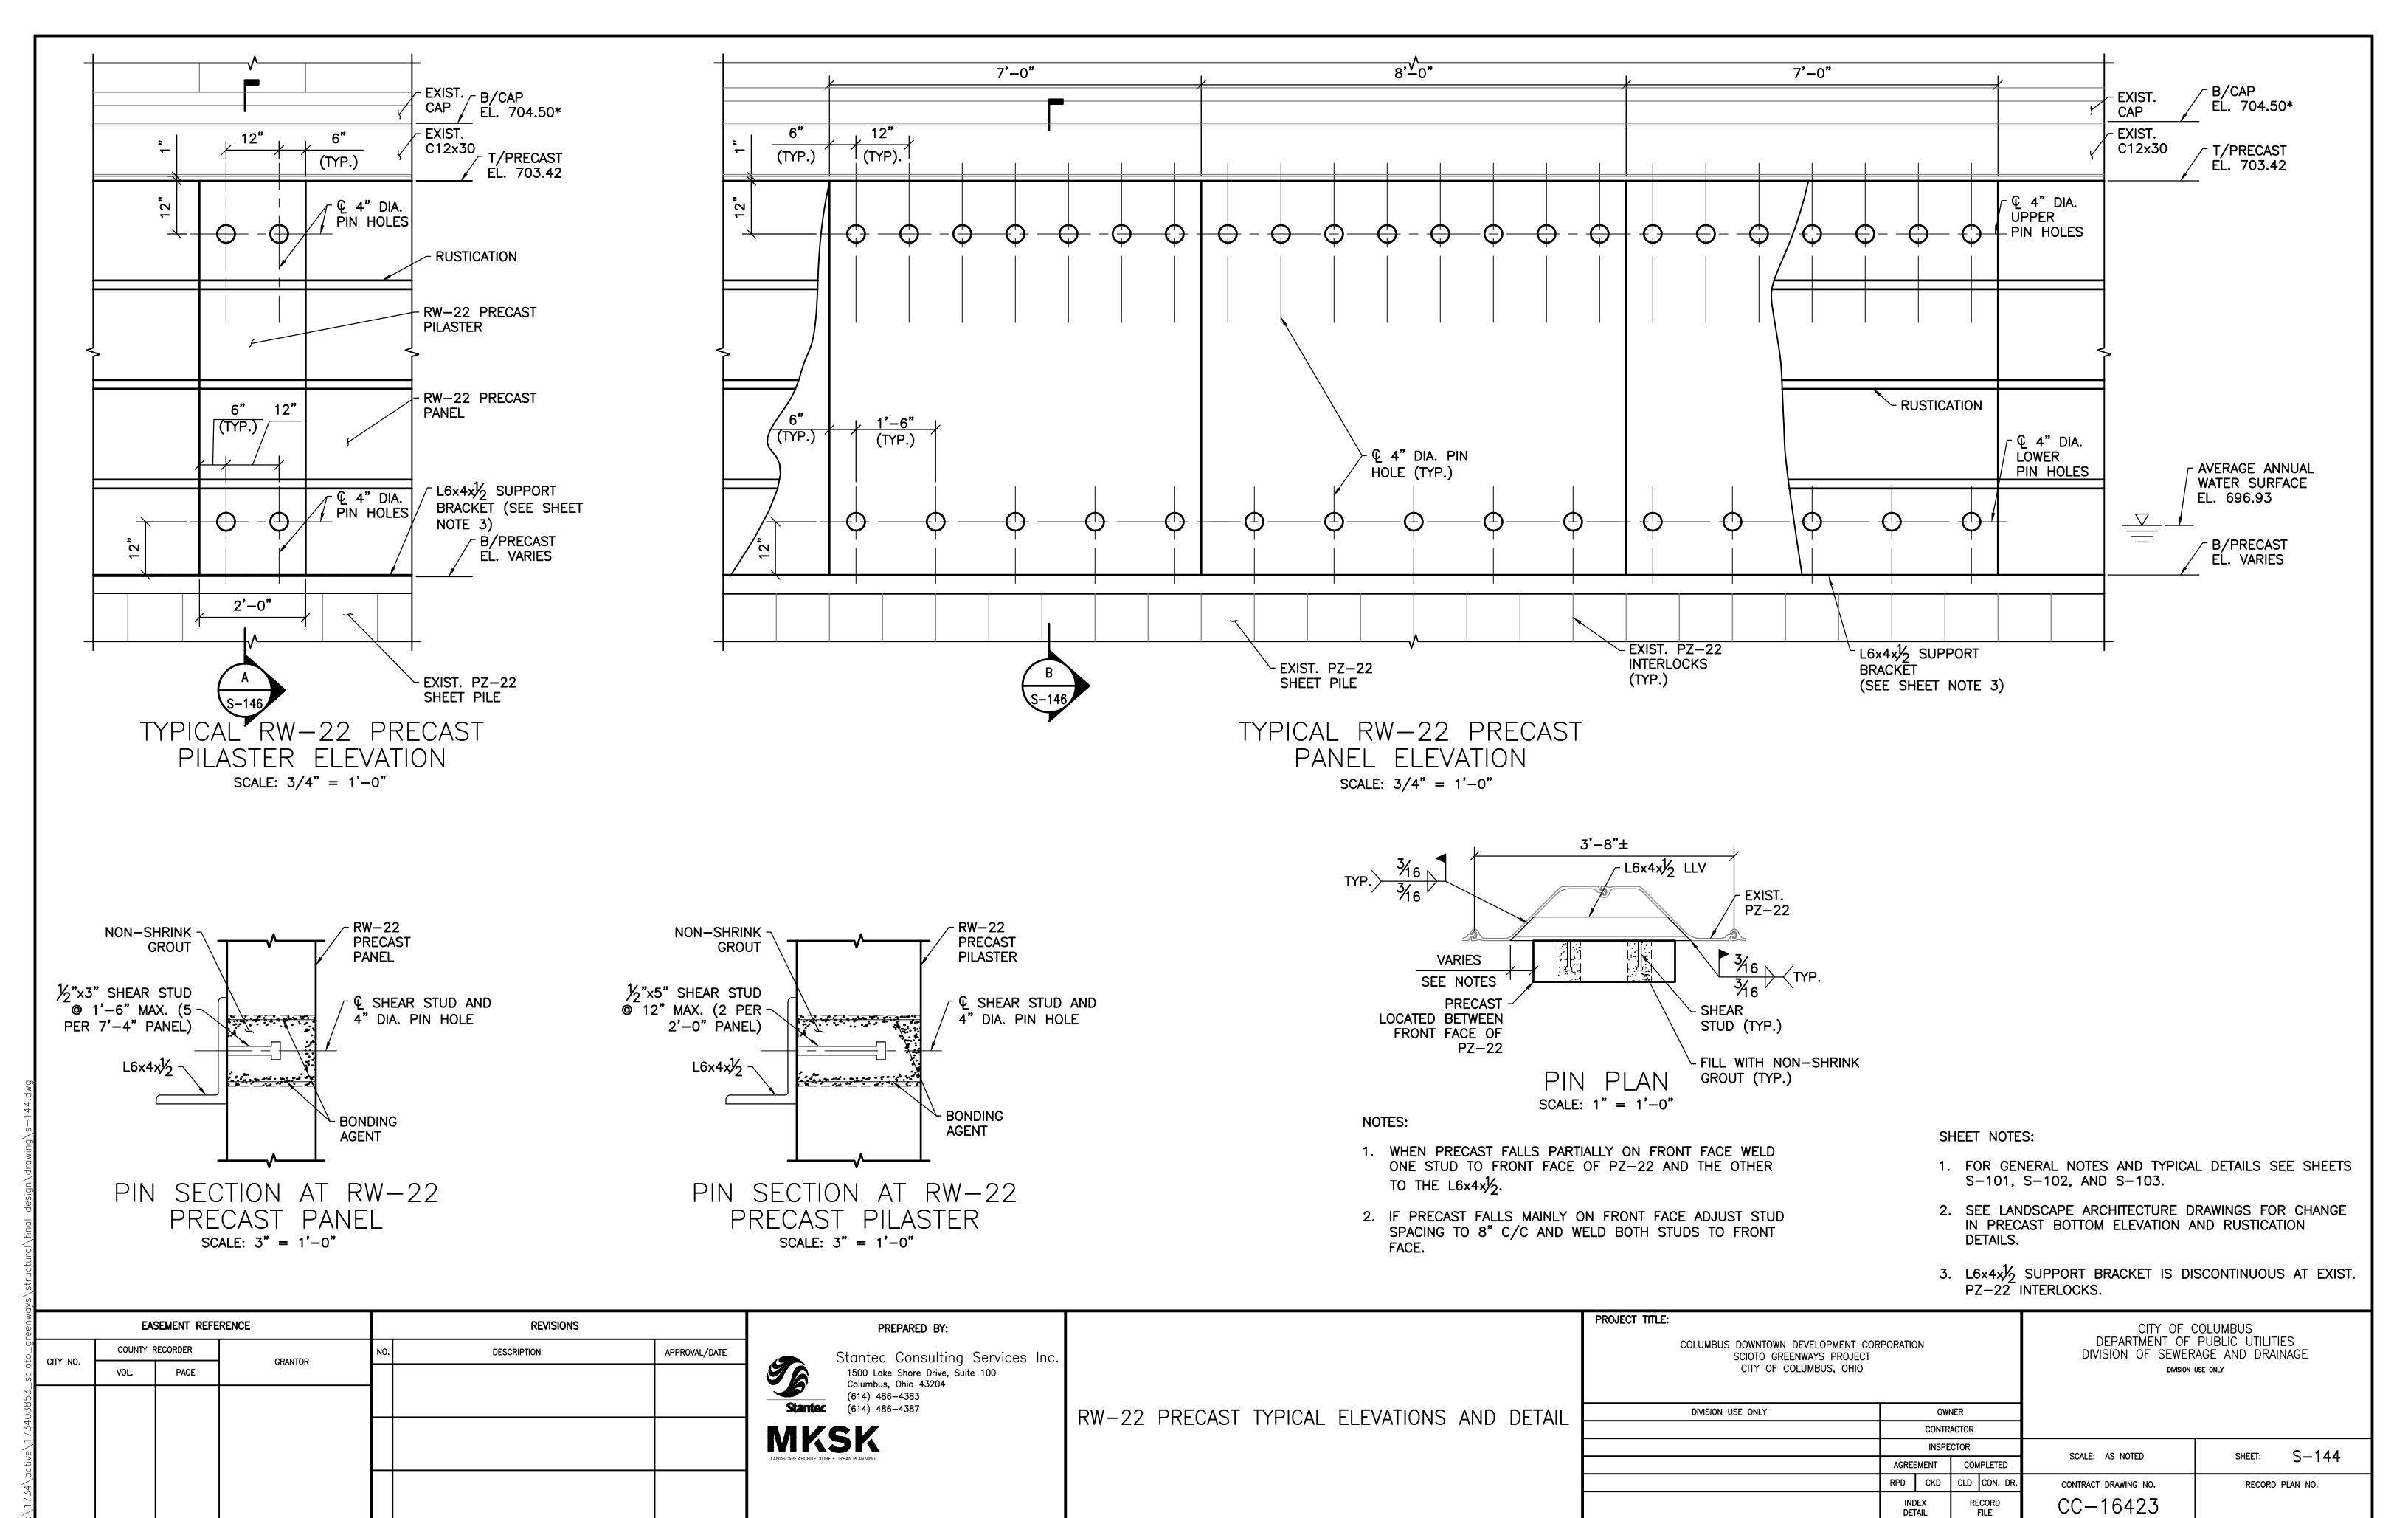

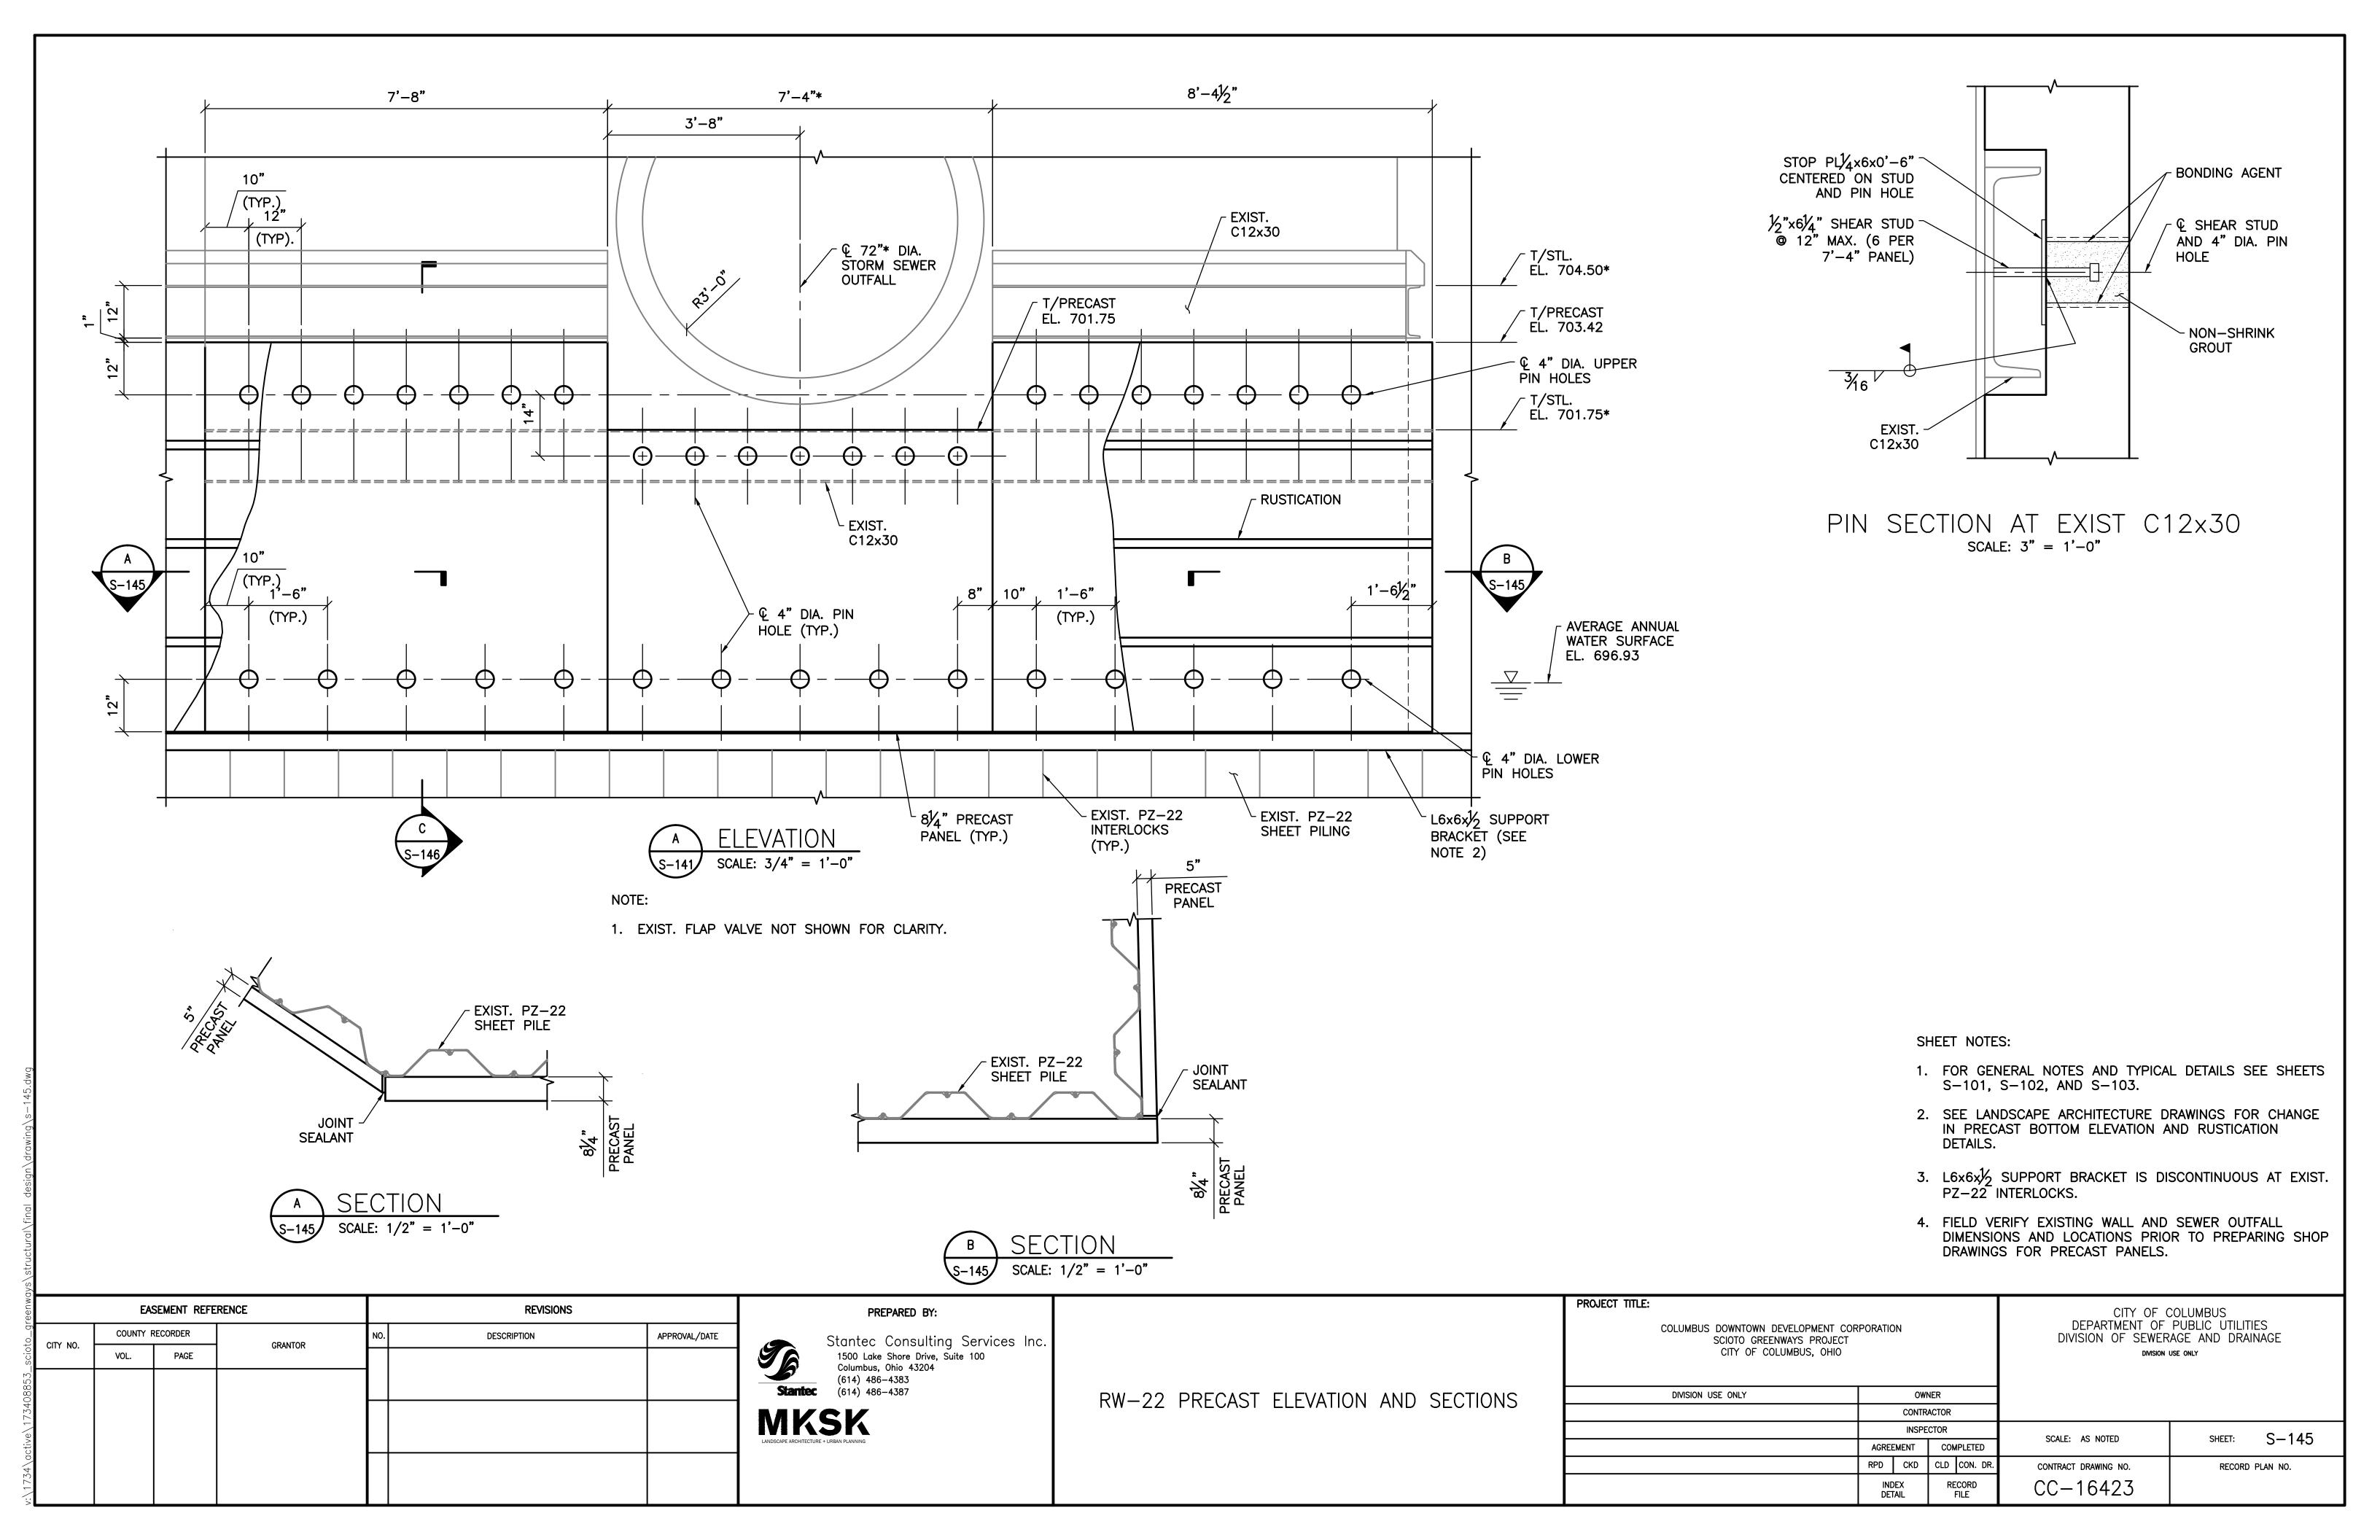


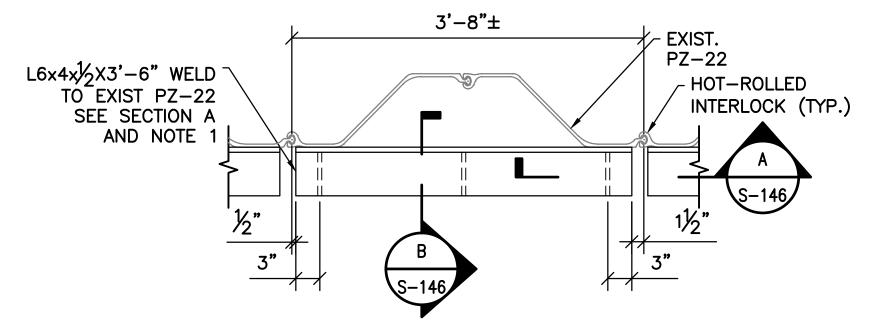

RW-22 PRECAST SUPPORT BRACKET PLAN scale: 1" = 1'-0"


NOTE:


1. AT $8\frac{1}{4}$ " PRECAST USE $16 \times 6 \times \frac{1}{2}$ IN PLACE OF $16 \times 4 \times \frac{1}{2}$.

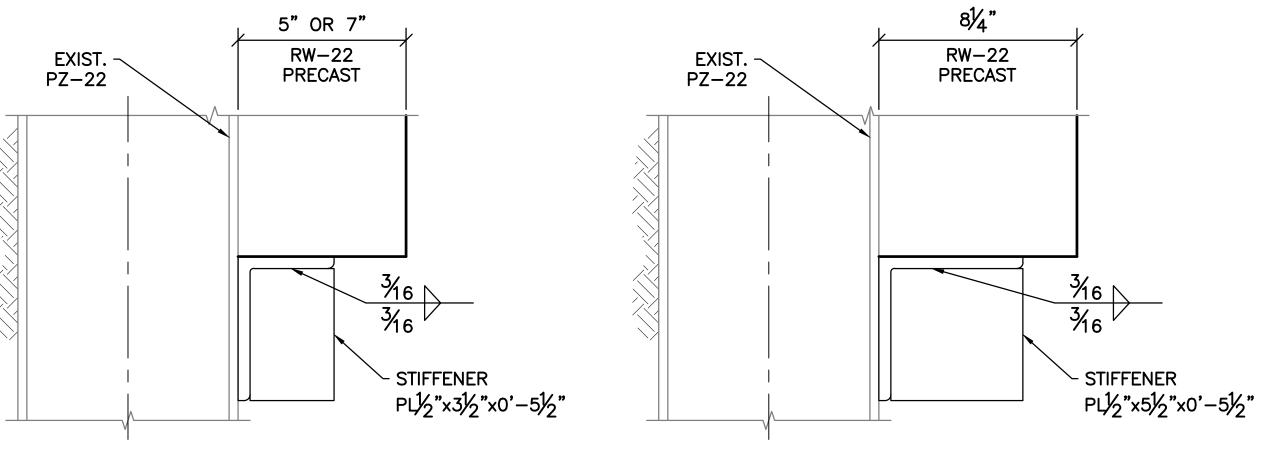

SECTION

81/4" PRECAST PANEL

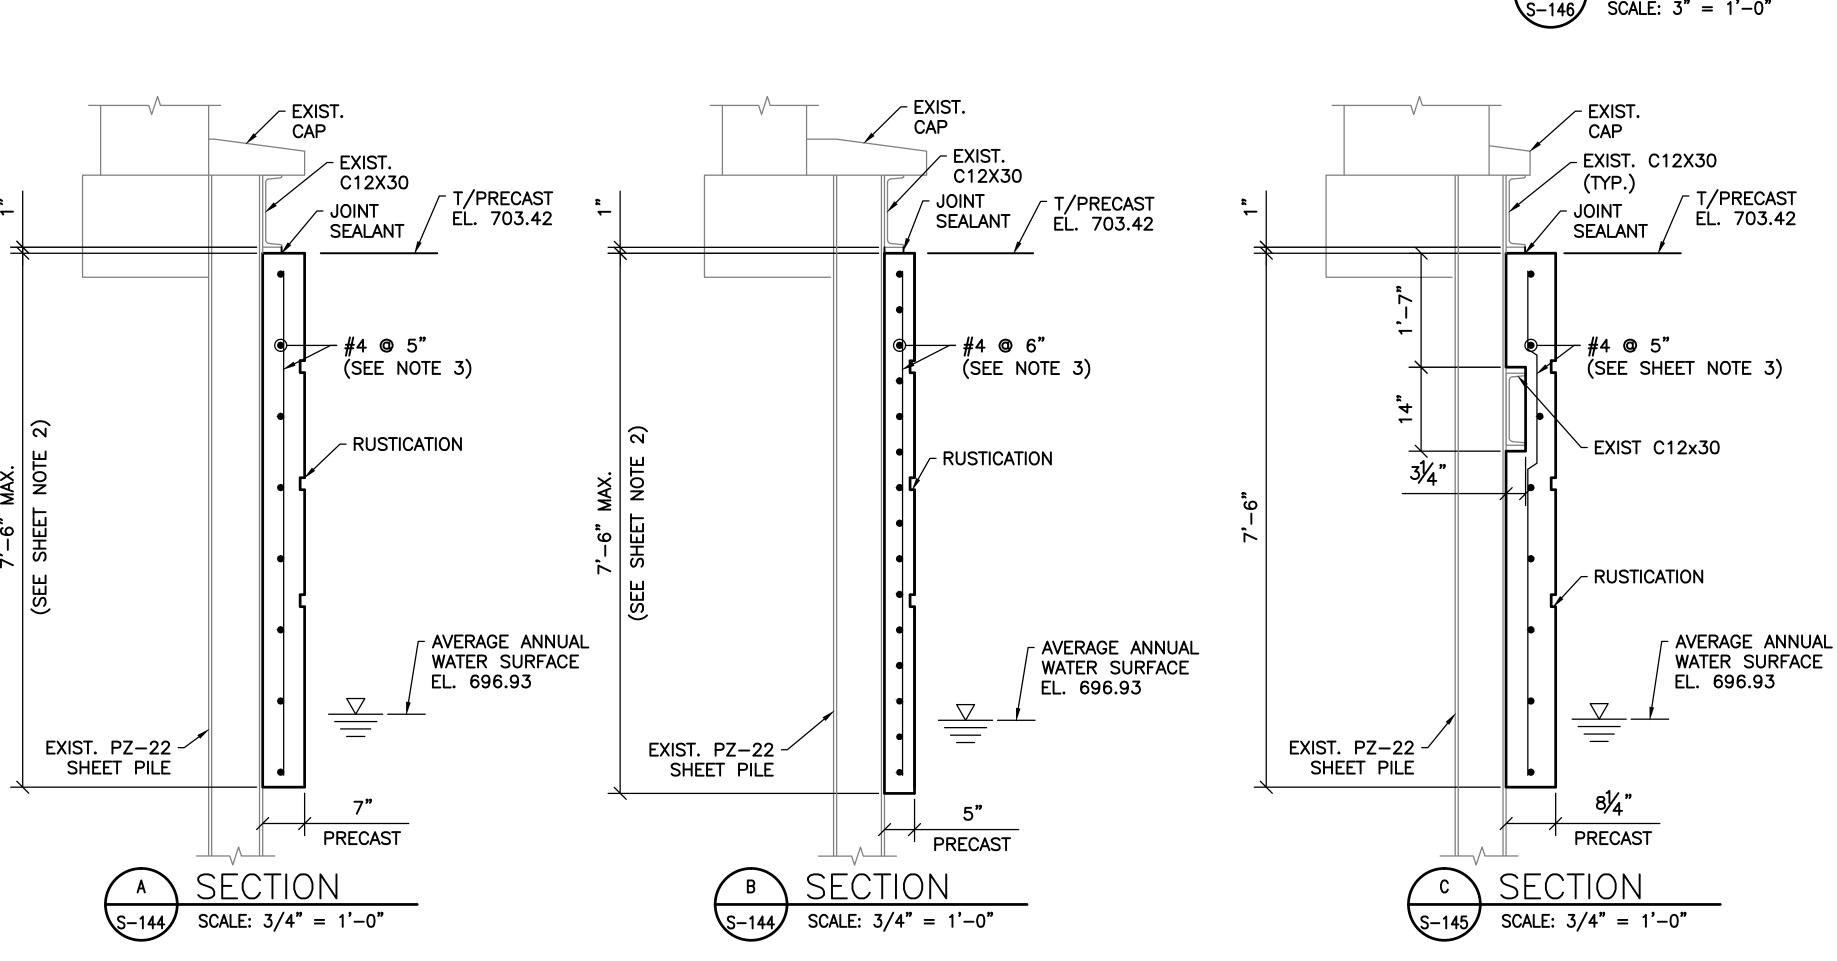

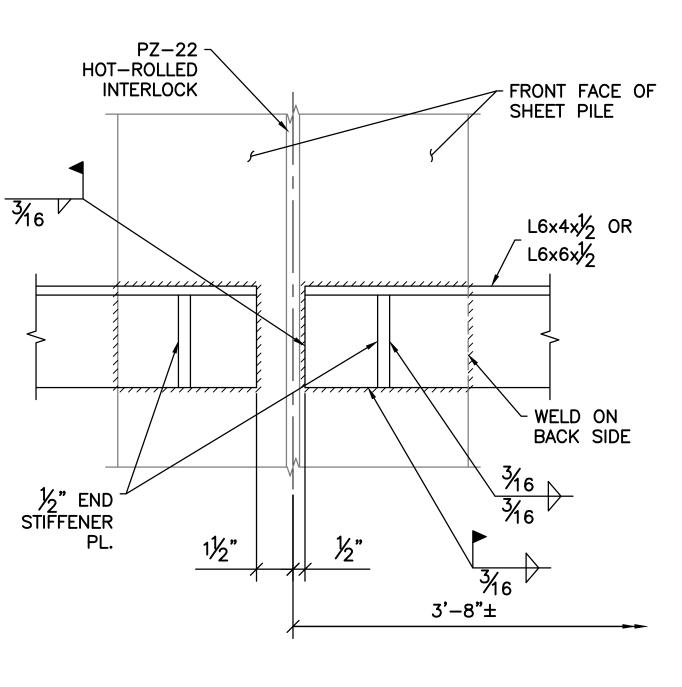




SHEET NOTES:


- 1. FOR GENERAL NOTES AND TYPICAL DETAILS SEE SHEETS S-101, S-102, AND S-103.
- 2. SEE LANDSCAPE ARCHITECTURE DRAWINGS FOR CHANGE IN PRECAST BOTTOM ELEVATION AND RUSTICATION DETAILS.
- 3. ADJUST PRECAST REINFORCING AS REQUIRED TO CLEAR PIN-HOLES BY 1" AND PROVIDE 1½" MINIMUM COVER.


									PIN-HOLES BY	1" AND PROVIDE 1/2" MII	NIMUM COVER.
EASEMENT REFERENCE		RENCE	REVISIONS		PREPARED BY:		PROJECT TITLE:		CITY OF C	COLUMBUS PUBLIC UTILITIES	
CITY NO.	COUNTY RECORDER GRANTOR		GRANTOR	NO. DESCRIPTION APPROVAL/DATE		Stantec Consulting Services Inc.		SCIOTO GREENWAYS PROJECT DIVISION OF SEWERAGE AND DE			
	VOL.	PAGE				1500 Lake Shore Drive, Suite 100 Columbus, Ohio 43204		CITY OF COLUMBUS, OHIO	10	DIMISION U	JSE ONLY
						(614) 486–4383 Stantec (614) 486–4387	RW-22 PRECAST DETAILS	DIVISION USE ONLY	OWNER		
						MKSK	IVW ZZ INLOASI DLIAILS		CONTRACTOR		
						LANDSCAPE ARCHITECTURE + URBAN PLANNING			INSPECTOR	SCALE: AS NOTED	SHEET: S-146
									AGREEMENT COMPLETED RPD CKD CLD CON. DR.		
									- 	CONTRACT DRAWING NO.	RECORD PLAN NO.
									INDEX RECORD DETAIL FILE	CC-16423	

5" OR 7" PRECAST PANEL


_scioto_greenways\structural\final design\drawing\s-146.dwg

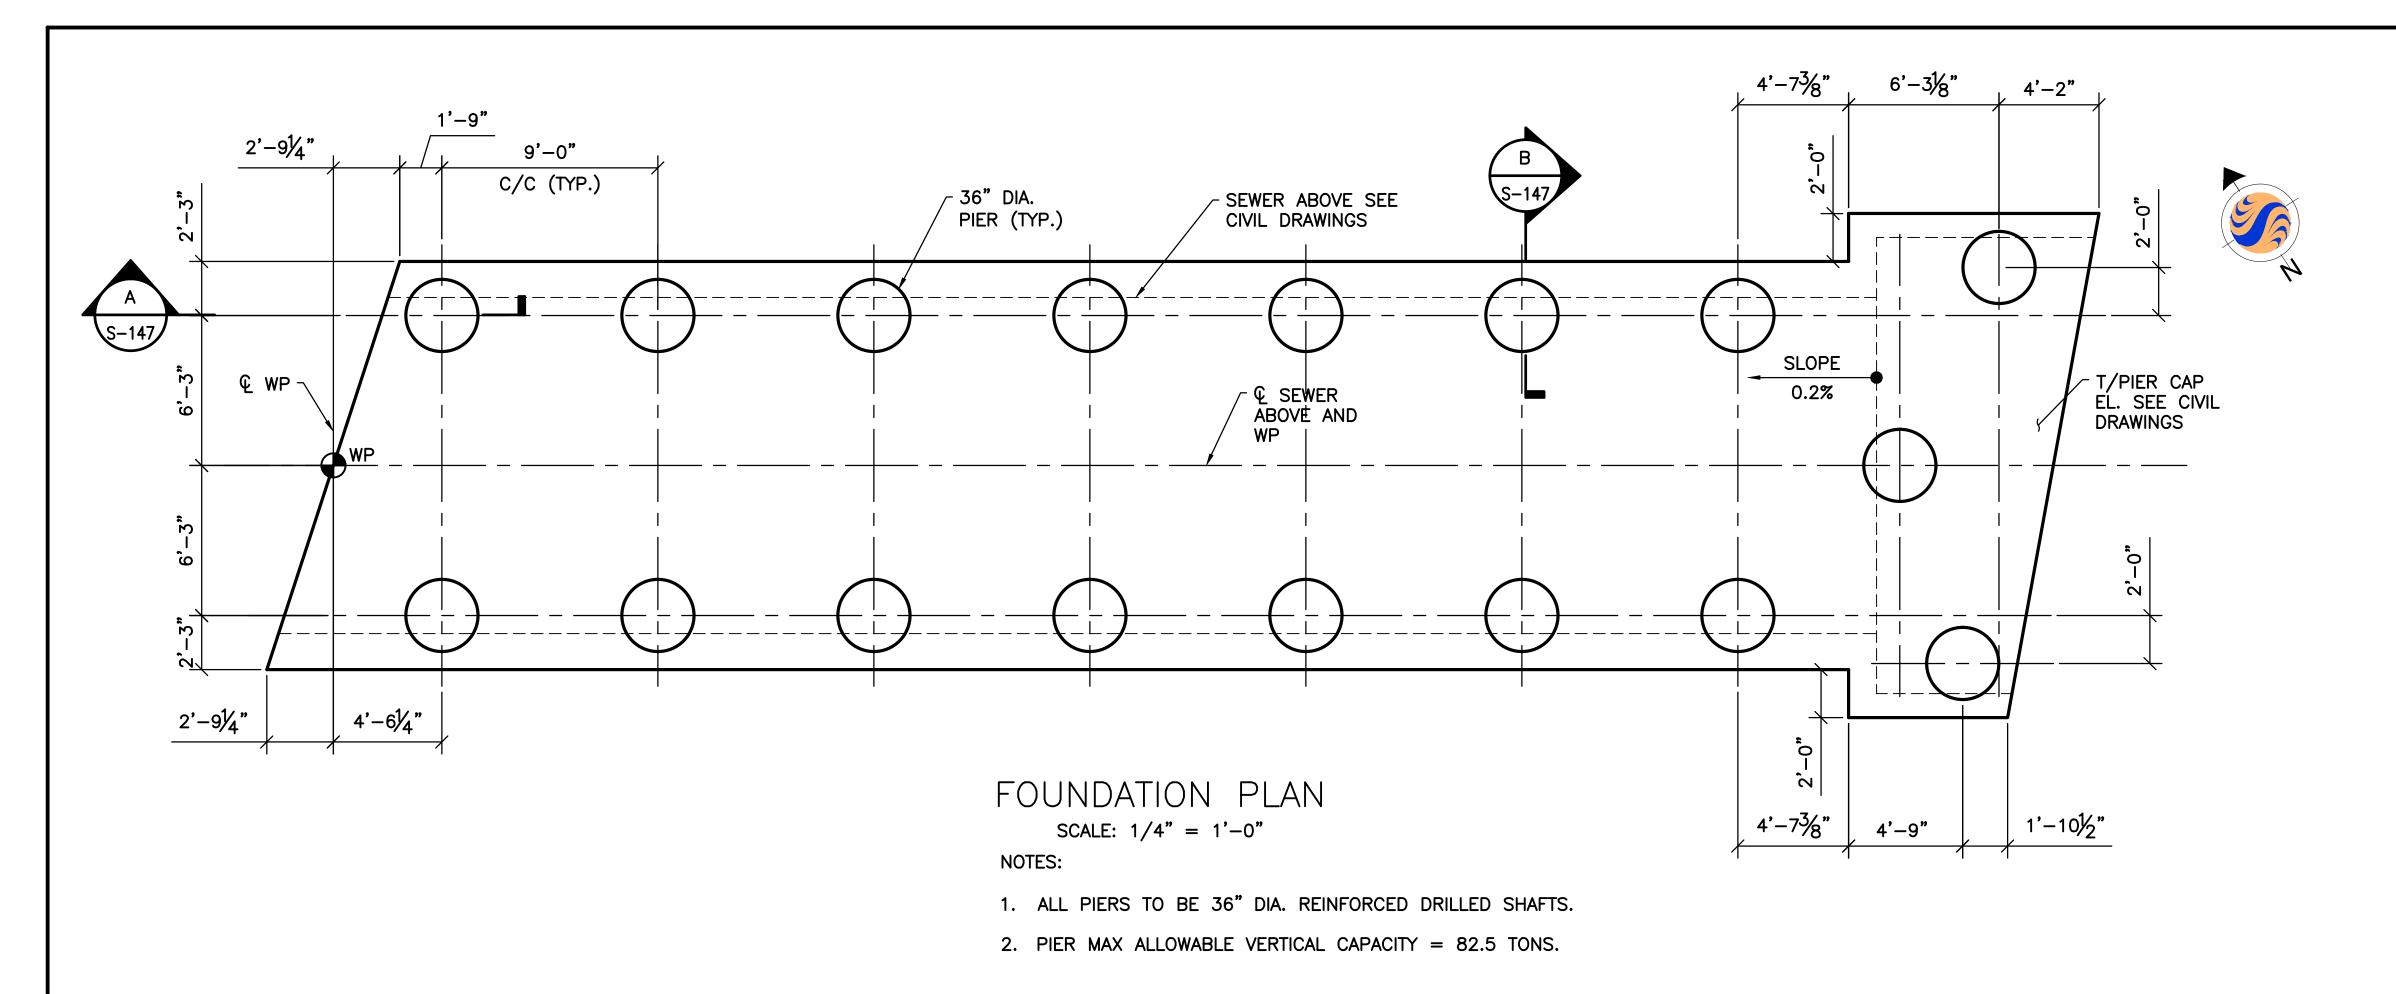

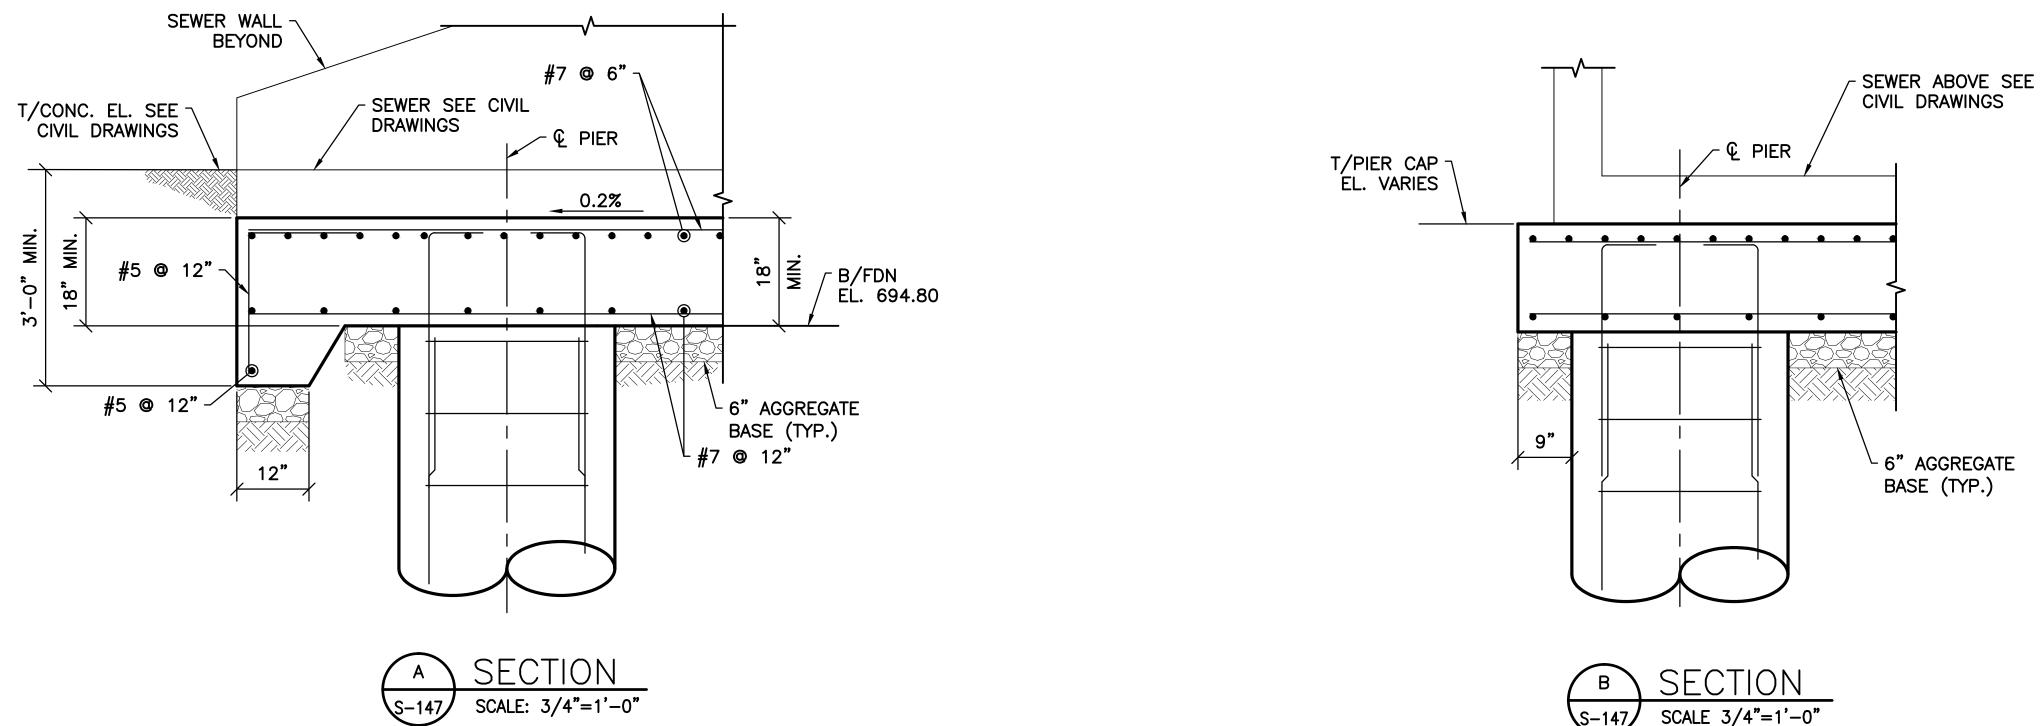

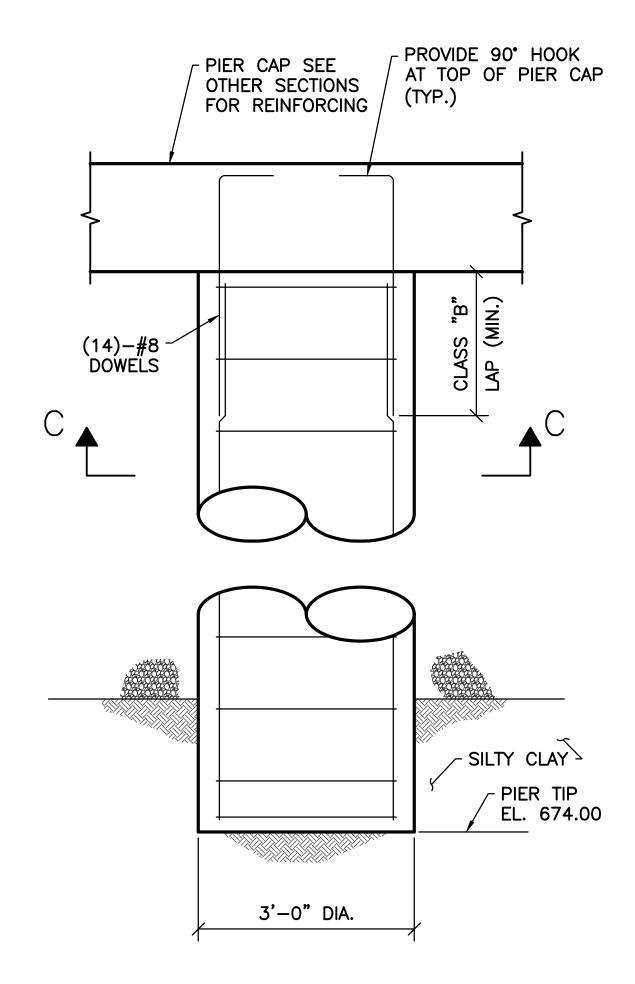

TYPICAL DRILLED PIER DETAIL SCALE: 3/4" = 1'-0"

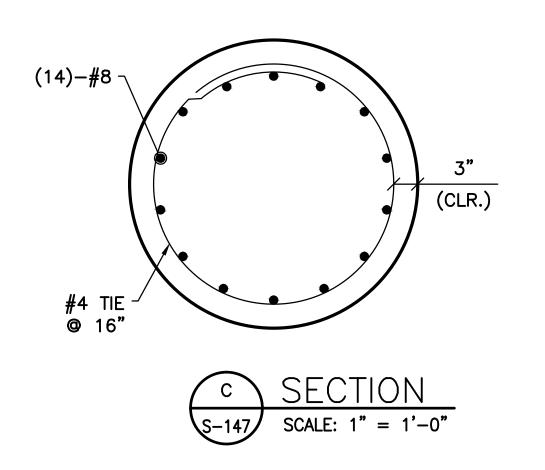

SHEET NOTE:

1. FOR GENERAL NOTES AND TYPICAL DETAILS SEE SHEETS S-101, S-102, AND S-103.

	EA:	SEMENT REFE	RENCE	REVISIONS				
OITY NO	COUNTY F	RECORDER	CRANTOR	NO.	DESCRIPTION	APPROVAL/DATE		
CITY NO.	VOL.	PAGE	GRANTOR _					


Stantec Consulting Services Inc.

1500 Lake Shore Drive, Suite 100
Columbus, Ohio 43204
(614) 486-4383
(614) 486-4387

MKSK

D-4 OUTFALL FOUNDATION PLAN AND SECTIONS

PROJECT TITLE: COLUMBUS DOWNTOWN DEVELOPMENT COI SCIOTO GREENWAYS PROJECT CITY OF COLUMBUS, OHIO	RPORATIO	ON			DEPARTMENT OF DIVISION OF SEWER	COLUMBUS PUBLIC UTILITIES AGE AND DRAINAGE USE ONLY			
DIVISION USE ONLY		IWO	NER						
	CONTRACTOR								
	INSPECTOR				SCALE: AS NOTED	SHEET: S-147			
	AGRE	EMENT	COI	MPLETED	SOALE. AS NOTED	3-17/			
	RPD	CKD	CLD	CON. DR.	CONTRACT DRAWING NO.	RECORD PLAN NO.			
		DEX TAIL		ECORD FILE	CC-16423				

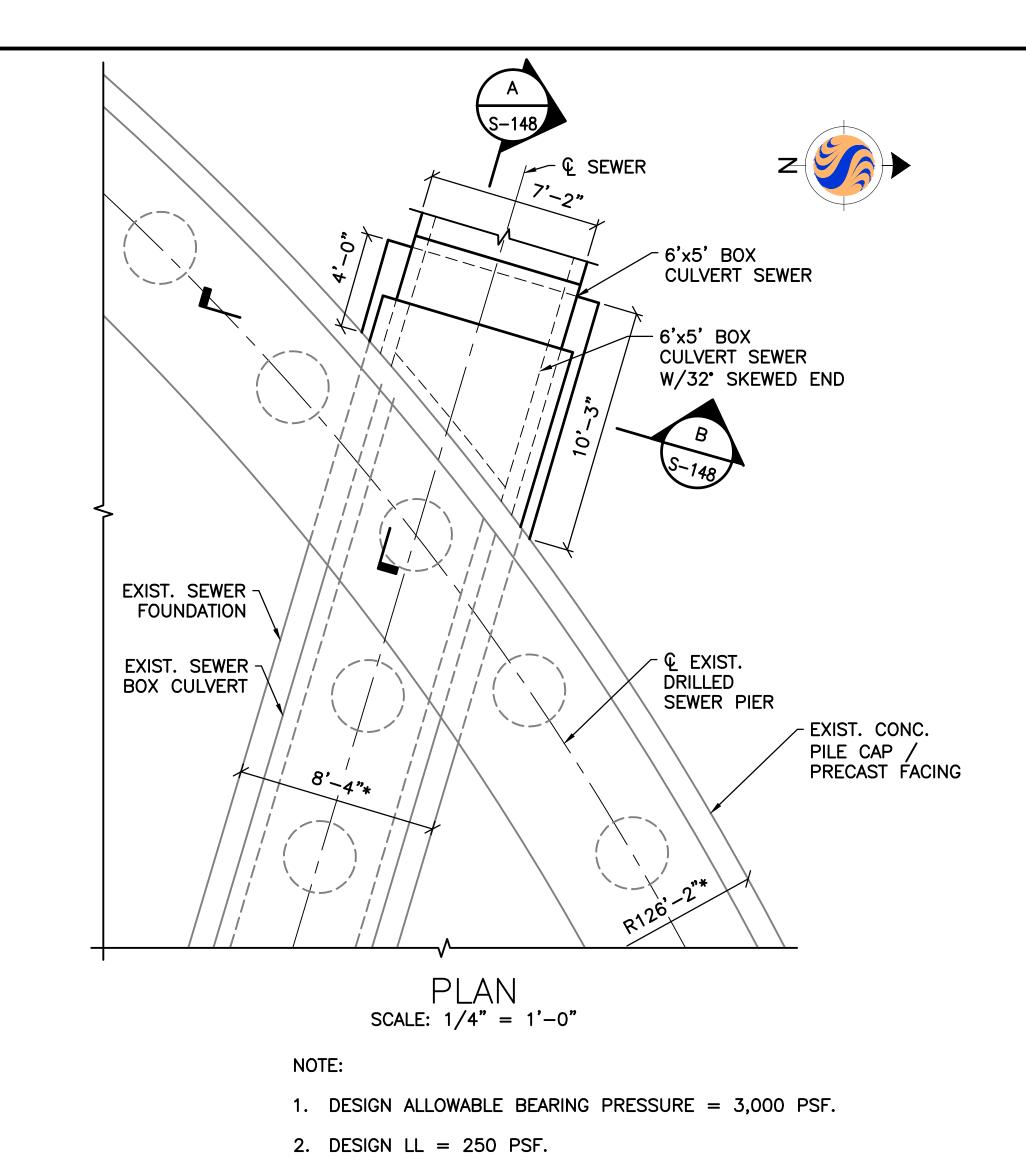


€ CULVERT -JOINT NON-SHRINK / GROUT (TYP.) CULVERT INV. \
EL. MATCH
EXIST. 6'x5' BOX —— CULVERT SEWER – EXIST. BOX CULVERT SEWER **┌**#6 **@** 6" #5 ADHESIVE DOWEL © 6" W/6" EMBED 0. 135° -HOOK 6" AGGREGATE -BASE (4)-#5 -#4 @ 12" ⁻ STIRRUP 12" EXIST. SEWER J **VARIES**

A SECTION S-148 SCALE: 3/4" = 1'-0"

2'-0" (MIN.)

#6 **@** 12"


EXIST.
PRECAST

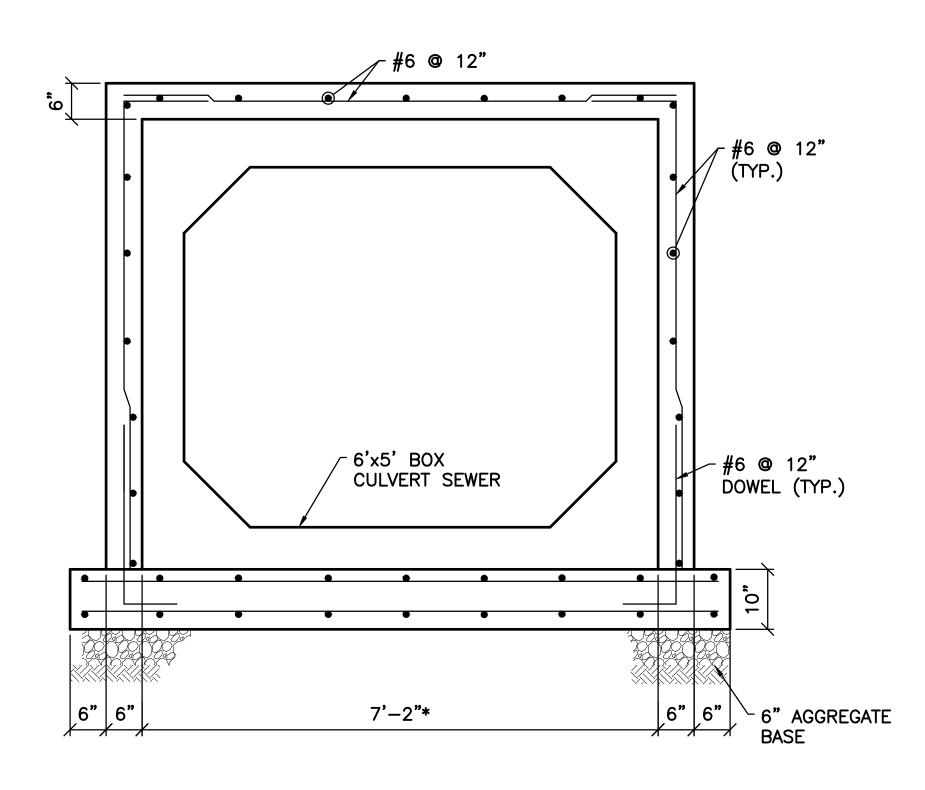



SHEET NOTE:

1. FOR GENERAL NOTES AND TYPICAL DETAILS SEE SHEETS S-101, S-102, AND S-103.

геепис	EASEMENT REFERENCE COUNTY RECORDER CITY NO. GRANTOR			REVISIONS		PREPARED BY:		PROJECT TITLE:			CITY OF COLUMBUS DEPARTMENT OF PUBLIC UTILITIES		
OT CITY NO			NO.	DESCRIPTION	APPROVAL/DATE	Stantec Consulting Services Inc.		COLUMBUS DOWNTOWN DEVELOPMENT CORPORATION SCIOTO GREENWAYS PROJECT			DIVISION OF SEWERAGE AND DRAINAGE		
CITY NO. VOL. PAGE GRANTOR				1500 Lake Shore Drive, Suite 100 Columbus, Ohio 43204 (614) 486-4383		CITY OF COLUMBUS, OHIO			DIVISION USE ONLY				
0886							Stantec (614) 486–4387	L-8 OUTFALL PLAN AND SECTIONS	DIVISION USE ONLY	OV	/NER		
734							MKSK	L O OOTITICE I ENTENTIALE SECTIONS		CONT	RACTOR		
e/1										INSP	ECTOR	SCALE: AS SHOWN	SHEET: S-148
ctiv							LANDSCAPE ARCHITECTURE + URBAN PLANNING			AGREEMENT	COMPLETED	SCALE. AS SHOWN	3-140
0 4										RPD CKD	CLD CON. DR.	CONTRACT DRAWING NO.	RECORD PLAN NO.
173										INDEX DETAIL	RECORD FILE	CC-16423	

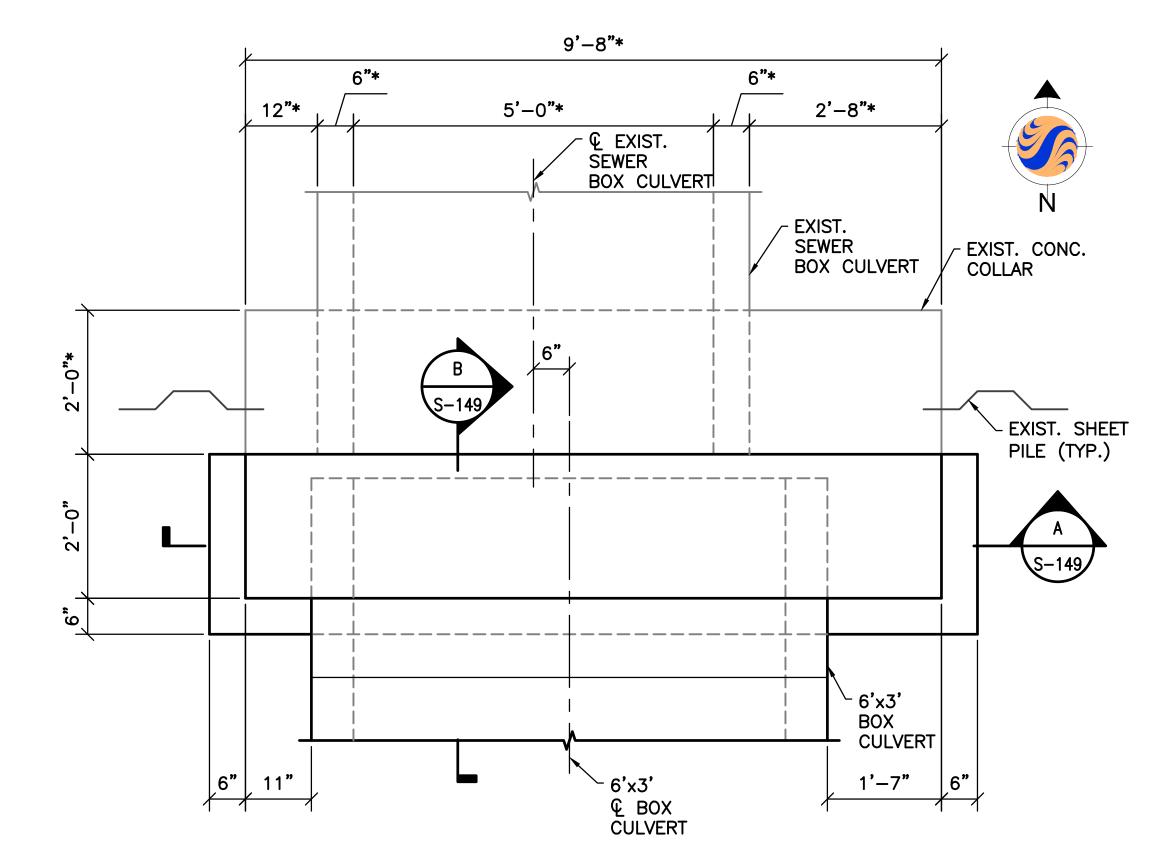

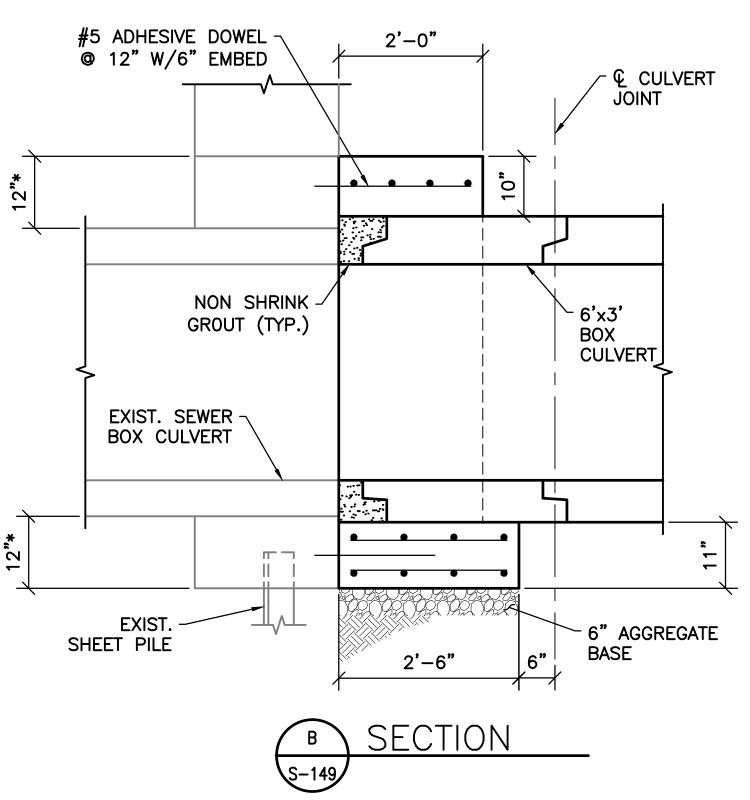

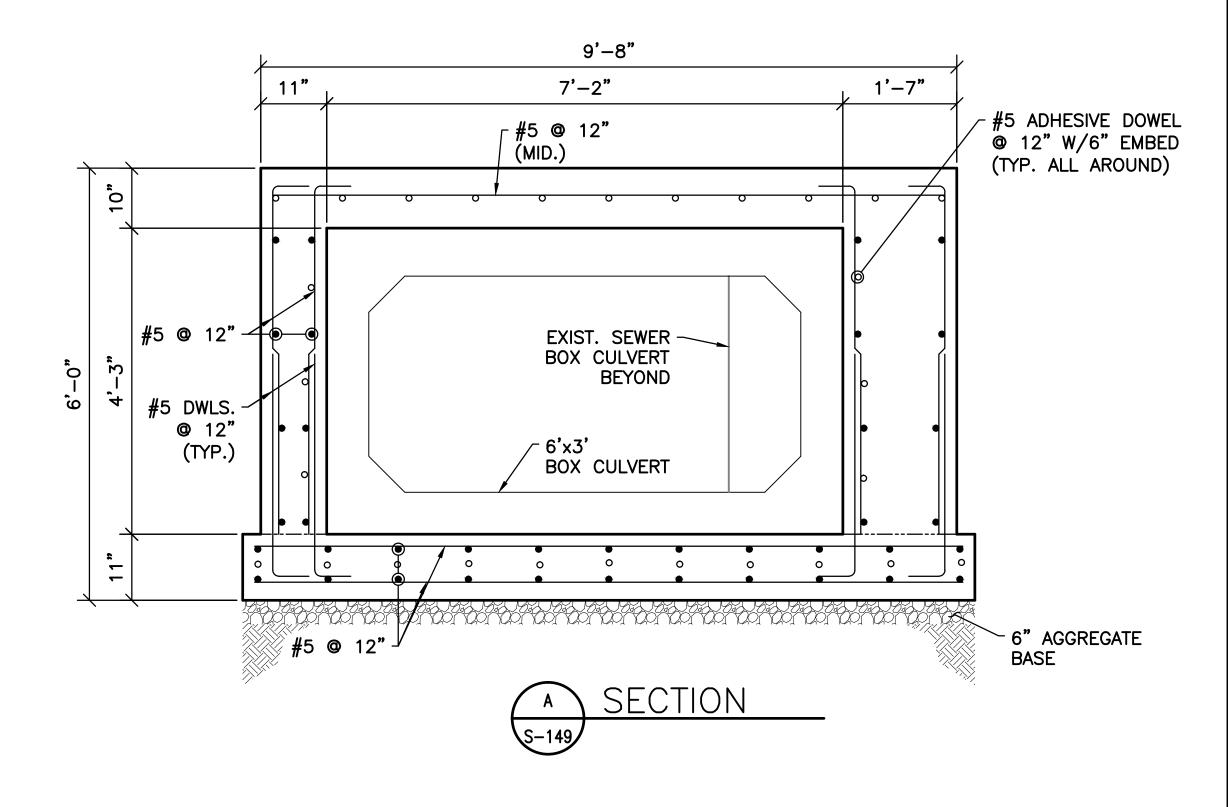

PLAN

NOTES:


- 1. DESIGN ALLOWABLE BEARING PRESSURE = 3,000 PSF.
- 2. DESIGN LL = 250 PSF.

SHEET NOTE:

1. FOR GENERAL NOTES AND TYPICAL DETAILS SEE SHEETS S-101, S-102, AND S-103.

EASEMENT REFERENCE			,	REVISIONS		PREPARED BY:		PROJECT TITLE:		CITY OF COLUMBUS	
city No.	COUNTY RECORDER		GRANTOR	NO. DESCRIPTION	APPROVAL/DATE	Stantec Consulting Services Inc. 1500 Lake Shore Drive, Suite 100 Columbus, Ohio 43204 (614) 486-4383 (614) 486-4387	0-0281 OUTFALL PLAN AND SECTIONS	COLUMBUS DOWNTOWN DEVELOPMENT CORPORATION SCIOTO GREENWAYS PROJECT CITY OF COLUMBUS, OHIO		CITY OF COLUMBUS DEPARTMENT OF PUBLIC UTILITIES DIVISION OF SEWERAGE AND DRAINAGE DIVISION USE ONLY	
sciois and the sciois		PAGE	GIVANION								
08853					DIVISION USE ONLY			OWNER			
734(LANDSCAPE ARCHITECTURE + URBAN PLANNING	0-0201 OUTFALL PLAN AND SECTIONS		CONTRACTOR		
(e) 1									INSPECTOR	SCALE: 3/4" = 1'-0"	SHEET: S-149
activ				-					AGREEMENT COMPLETED	30,122. 3,1	
45									RPD CKD CLD CON. DR.	CONTRACT DRAWING NO.	RECORD PLAN NO.
717									INDEX RECORD DETAIL FILE	CC-16423	

reenways\structural\final_desian\drawina\s-149.dwa

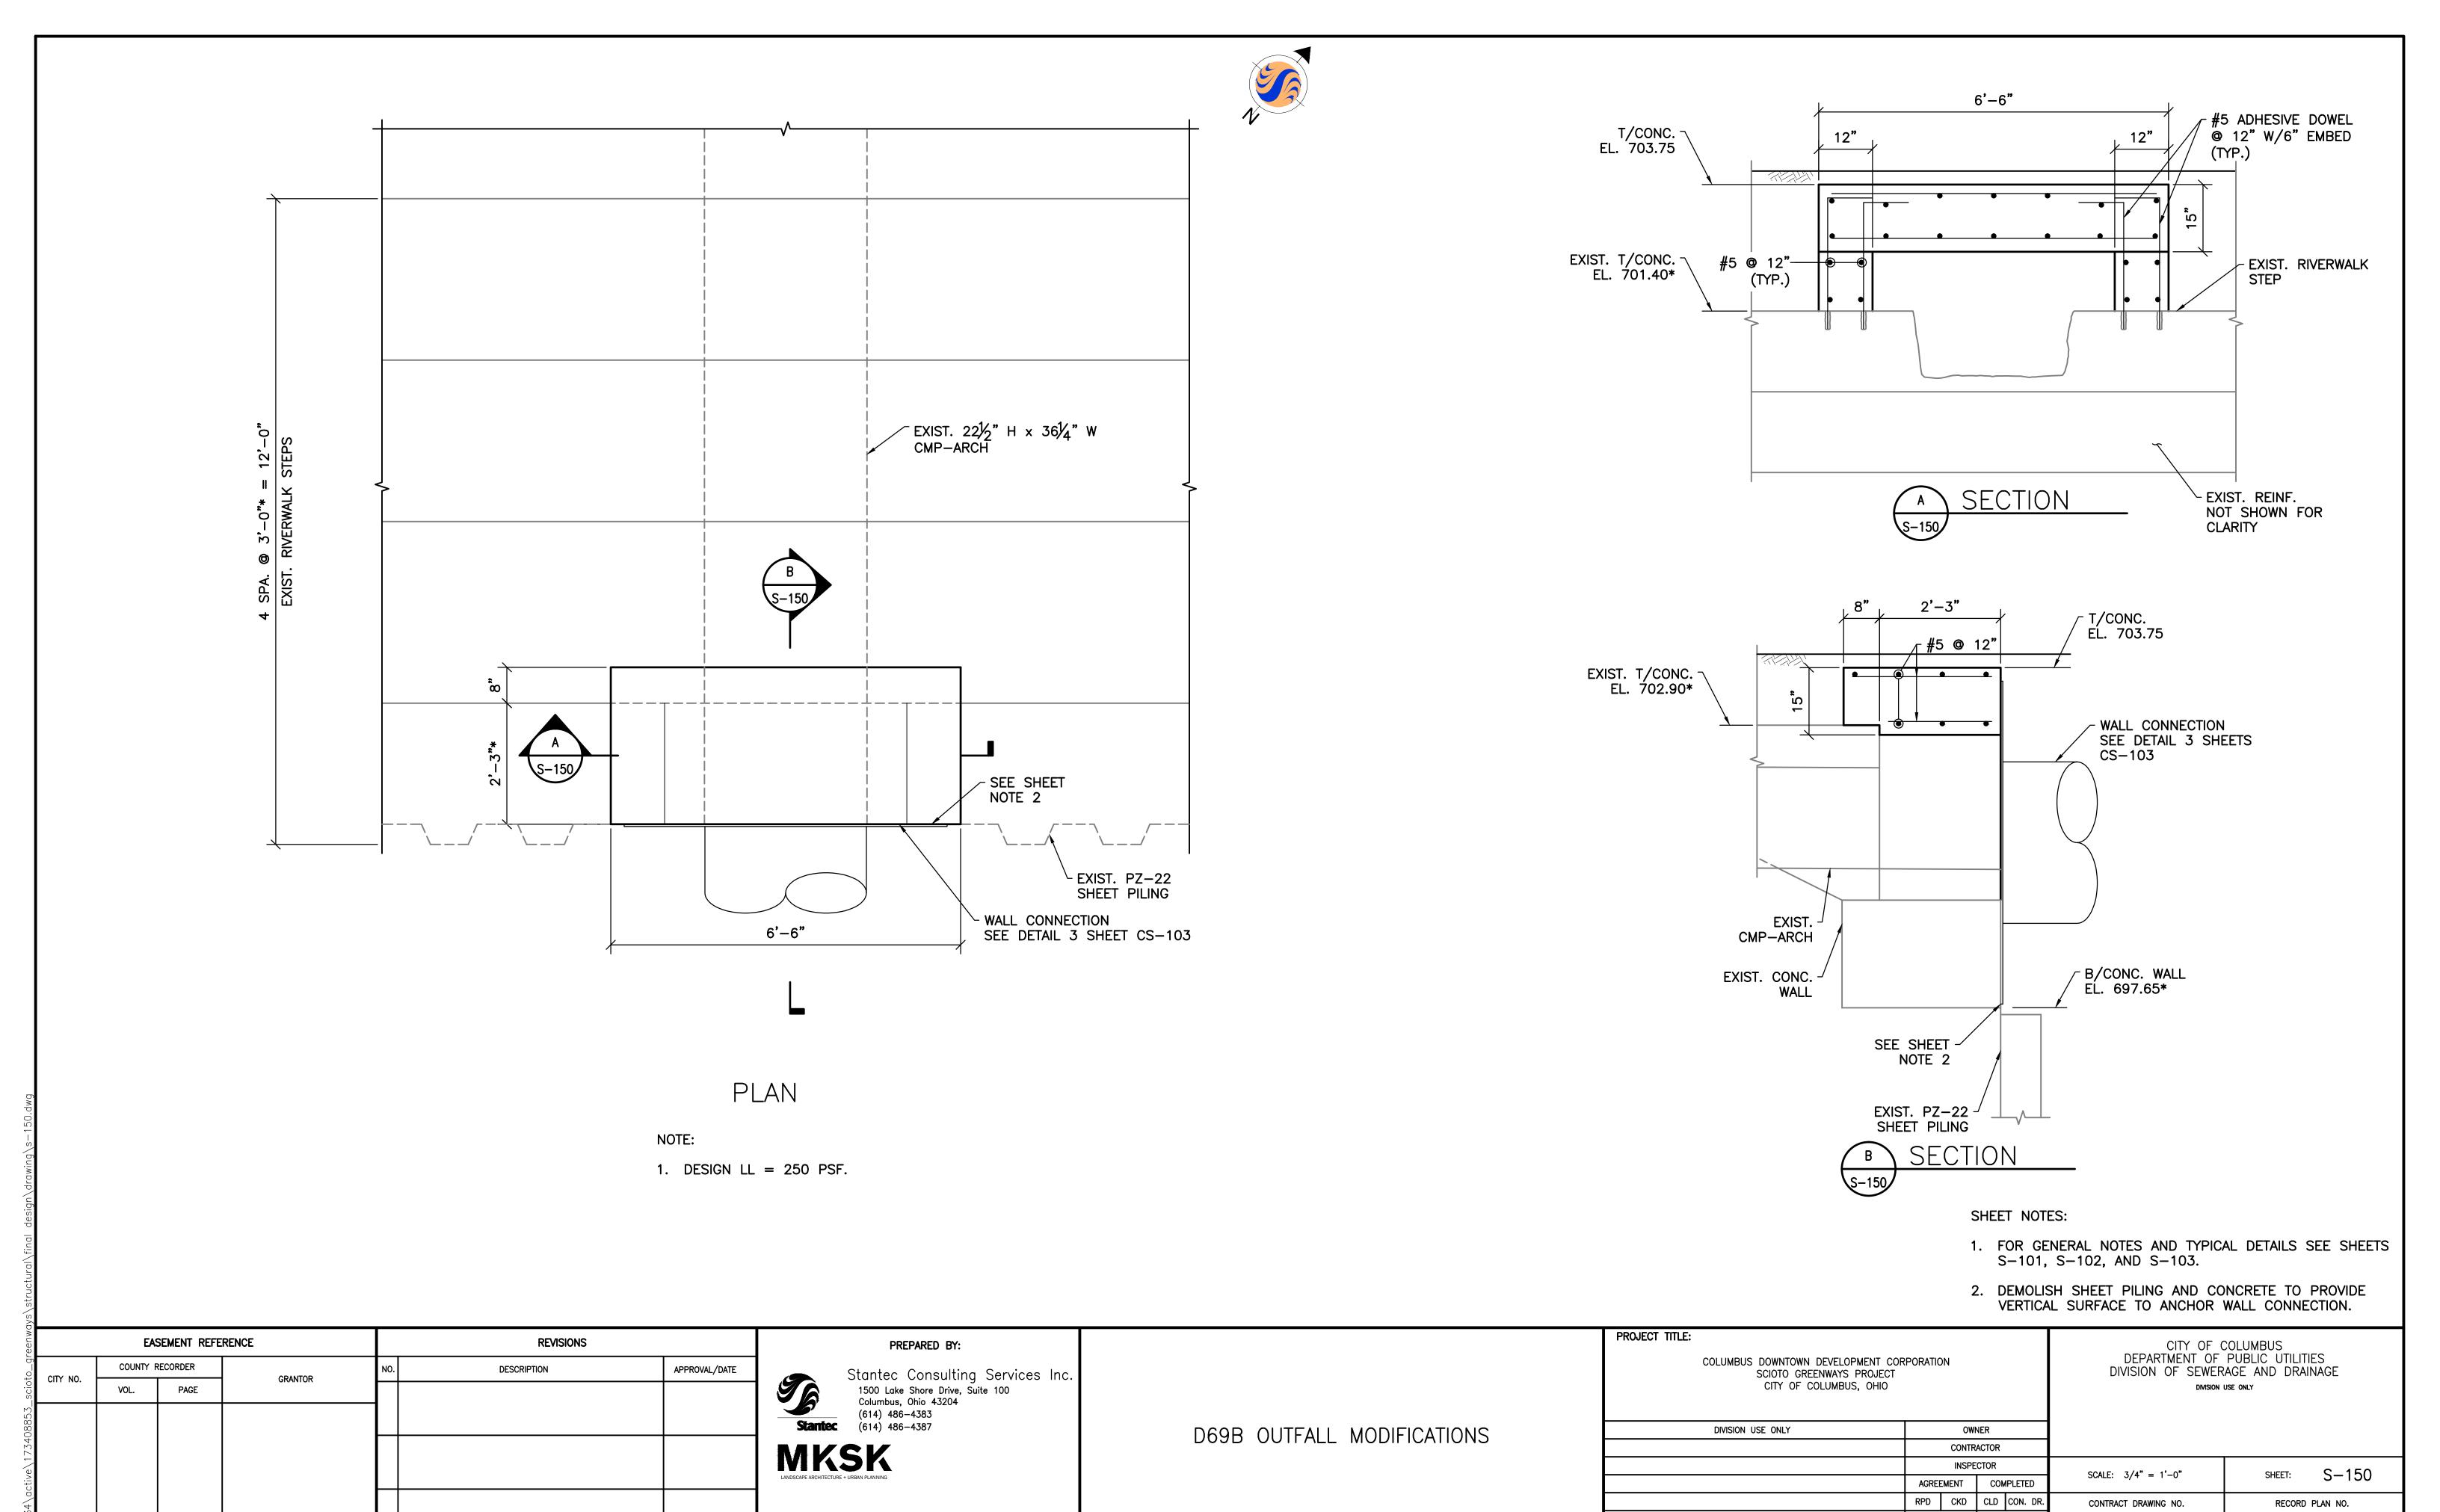

RECORD FILE

INDEX DETAIL CC-16423