

UNDERGROUND ELECTRIC LINE

CUT AND PLUG EXISTING UTILITY

ABANDON EXISTING UTILITY

REMOVE EXISTING UTILITY GATE VALVE & CURB BOX FIRE DEPARTMENT CONNECTION

REMOVE EX. STRUCTURE

PROPOSED POWER POLE

PAVEMENT REPLACEMENT PER DETAIL A/C3.2

\$950.00

PROPOSED TELEPHONE/LIGHT POLE

STRUCTURE NUMBER


CLEAN OUT

UTILITY LEGEND EXISTING REFER TO SHEET TS1 PROPOSED

(1)(101)

-2" WATER METER CHARGE:

-WATER CONNECTION INSPECTION FEE:

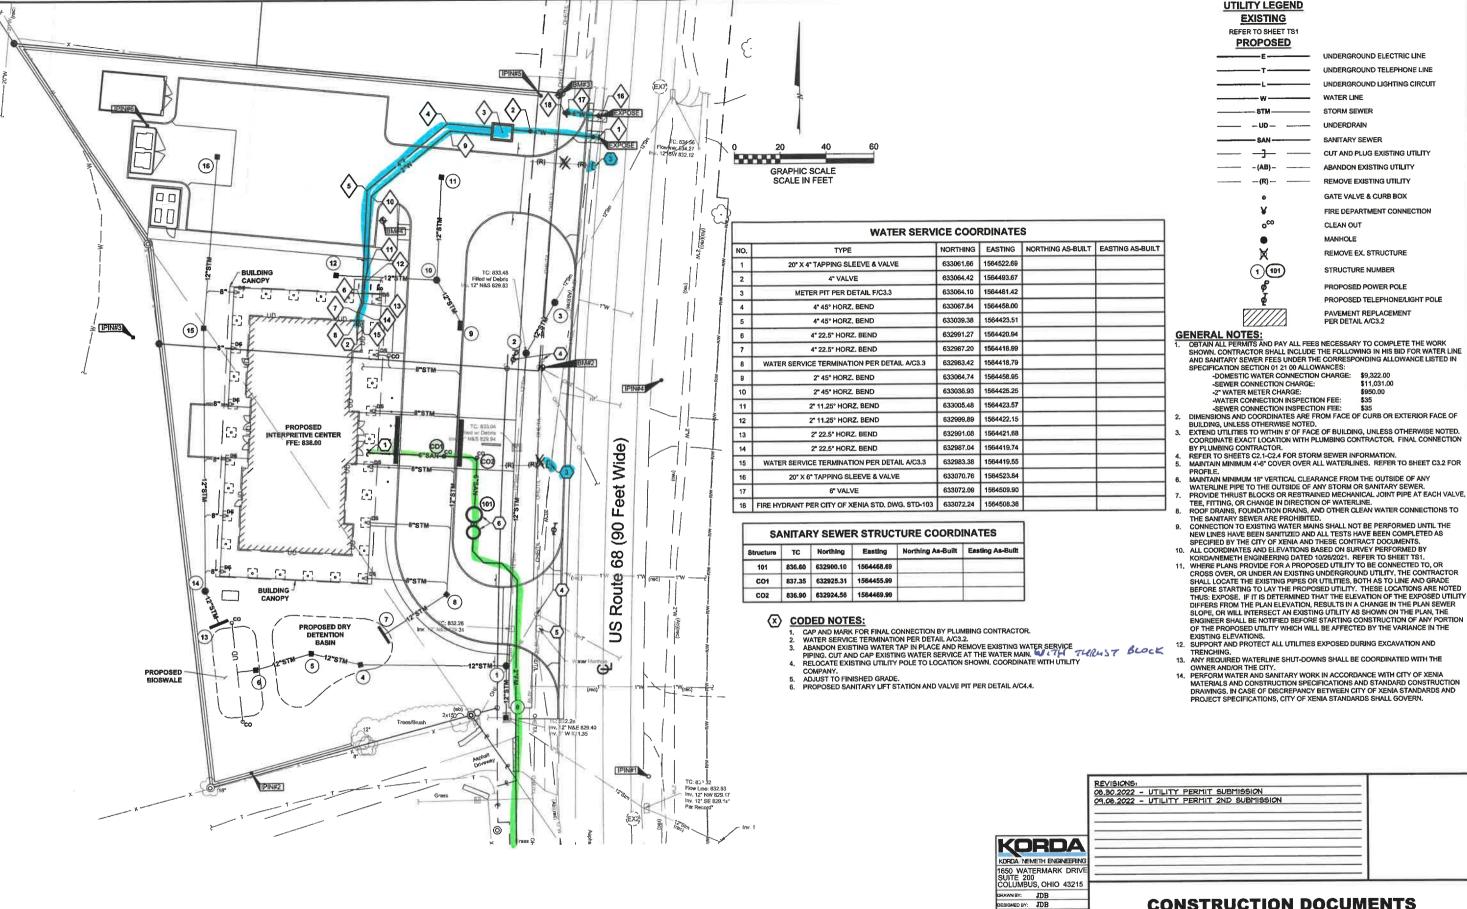

CONSTRUCTION DOCUMENTS

UTILITY PLAN


C3.1

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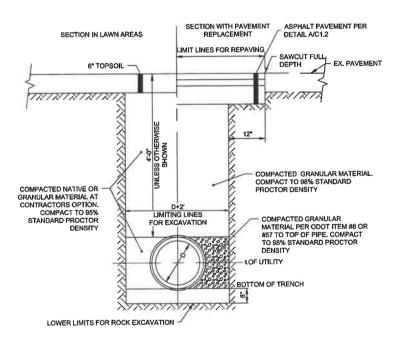


HISTORIC OLDTOWN **NEW INTERPRETIVE CENTER** 1575 US-68, XENIA, OHIO 45385

JDB JOB NUMBER: DESIGNED BY: DNR-210003 SCALE: DRAWN BY: JDB 02.25.2022 CMF PERMIT DATE: CHECKED BY: XX DRAWING DATE: 08.30.2022 APPROVED BY:

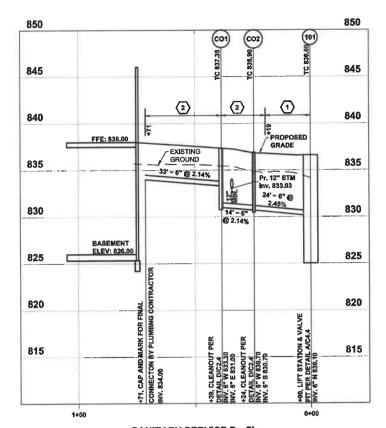


SANITARY SERVICE Profile Scale: 1"=20' Horiz. 1"=5' Vert.





TYPICAL WATER LINE & SANITARY FORCE MAIN TRENCH

N.T.S.

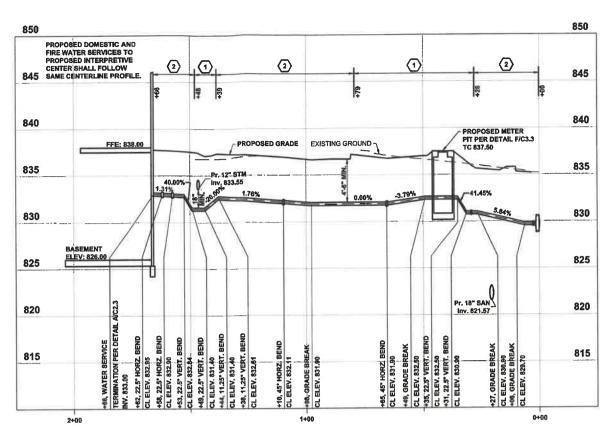

FIRE & DOMESTIC WATER SERVICE Profile Scale: 1"=20' Horiz. 1"=5' Vert.

X CODED NOTES:

- BACKELL WITH COMPACTED BACKELL TYPE DIPER SPECIFICATION SECTION 31 00 00 AND 31 23 33.
- BACKFILL WITH COMPACTED GRANULAR BACKFILL TYPE A OR J PER SPECIFICATION SECTION 31 00 00 AND 31 23 33.

KORDA KORDA NEMETH ENGINEERIN 1650 WATERMARK DRIVE SUITE 200 COLUMBUS, OHIO 43215 DRAWN BY: JDB
DESIGNED BY: JDB CHECKED BY: CMF

PROJECT NUMBER: 2021-000

CONSTRUCTION DOCUMENTS

UTILITY PROFILES & DETAILS

C3.2


20


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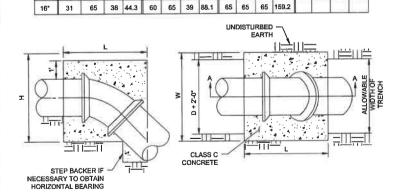
HISTORIC OLDTOWN **NEW INTERPRETIVE CENTER** 1575 US-68, XENIA, OHIO 45385

JDB JOB NUMBER: DNR-210003 DESIGNED BY: DRAWN BY: SCALE: JDB CMF PERMIT DATE: CHECKED BY: xx DRAWING DATE: 08.30.2022 APPROVED BY:



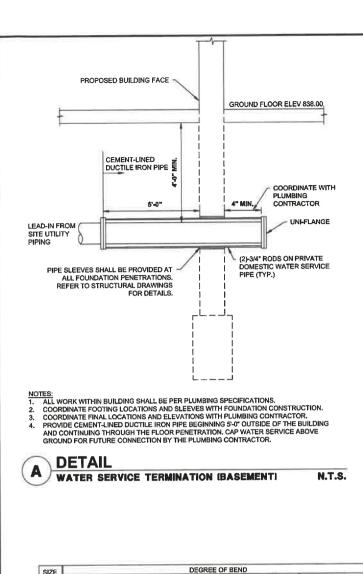

12" 20 54 36 22.6 37 62 37 49.0 48 62 51 87.9 66 66 66 166.4

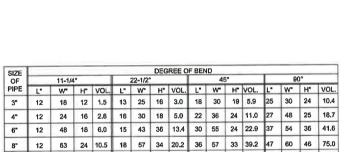

NOTES: 1. VOLUMES GIVEN IN CUBIC FEET. 2. BACKER TO BE CENTERED HORIZONTALLY ON BEND. 3. STEEL WILL BE USED AS REQUIRED BY THE ENGINEER.

DETAIL

SECTION A-A

BACKING FOR VERTICAL BENDS [LOWER BENDS ONLY]

PLAN VIEW

N.T.S.

HISTORIC OLDTOWN **NEW INTERPRETIVE CENTER** 1575 US-68, XENIA, OHIO 45385

4" 10 6 0.5 11 8 0.8

6" 9 7 0.5 11 8 0.8 18 12 1.9

8" 8 8 0.5 10 9 0.7 18 12 1.9 23 16 3.5

PLAN VIEW

PIPE DIA. +2'

12" 6 12 0.6 8 12 0.8 18 12 1.9 23 16 3.5 38 22 8.7

18" 6 16 0.8 6 16 0.8 14 16 2.0 20 18 3.3 36 23 8.7 49 30 13.6
20" 1 9 24 1.9 15 24 3.3 30 28 8.7 42 36 14.0 5 4 2 26.3 68 48 45.4

CLASS C

CONCRETE

METER PIT

TYPE H FILL (ODOT #8)

G

8'L X 3'W X 3'H MIN

DETAIL

METER PIT FRENCH DRAIN

SECTION A-A

BACKER DESIGNED FOR 3000 PSF SOIL BEARING.
 CONCRETE TO BE PLACED AGAINST UNDISTURBED EARTH.

N.T.S.

NON-WOVEN GEOTEXTILE FABRIC, TYPE A, PER ODOT ITEM 712.09 (TYP. ALL SIDES))

N.T.S.


4" PERFORATED UNDERDRAIN WITH FILTER SOCK PER SPECIFICATION SECTION 33 40 00

3. PROVIDE CLEARANCE FOR REMOVAL OF BOLTS.

GRATE


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22-1/2° L" D" VC.F. L" D" VC.F. 6 4 0.2 10 4 0.3 10 4 0.3 4 0.2 9 5 0.4 14 5 0.6 14 5 0.6 6 0.5 12 7 0.7 20 8 1.4 18 9 1.7 8 0.7 16 9 1.4 24 12 2.7 25 11 4.0 12° 12 1.8 24 14 3.6 36 18 6.8 32 18 10.7 16 3.4 32 18 6.7 36 32 13.4 41 26 25.6

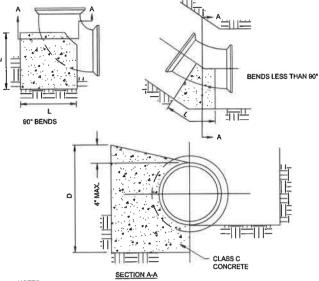



ES!
BACKER DESIGNED FOR 3000 PSF SOIL BEARING.
CONCRETE TO BE PLACED AGAINST UNDISTURBED EARTH.
PROVIDE CLEARANCE FOR REMOVAL OF BOLTS.

DETAIL BACKING FOR BENDS [HORIZONTAL & VERTICAL SAG] N.T.S.



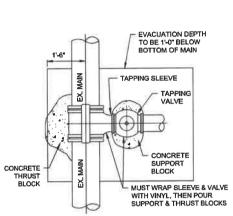

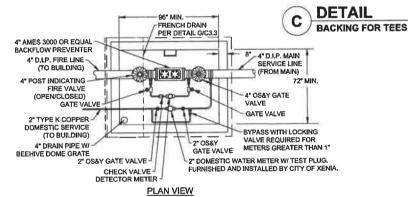

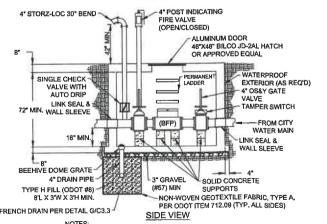

METER PIT PER CITY OF XENIA STD-109 (MODIFIED)

NOTES:

1. METER PIT PER CITY OF XENIA STANDARD DRAWING STD-109 MODIFIED AS SHOWN.
2. DOMESTIC WATER METER SHALL BE PROVIDED AND INSTALLED BY THE CITY OF XENIA. CONTRACTOR SHALL PROVIDE AND INSTALL ALL OTHER MATERIALS.

(ORDA KORDA NEMETH ENGINEERIN 650 WATERMARK DRIV SUITE 200 COLUMBUS, OHIO 43215 AWN BY: JDB ESIGNED BY: JDB

- 4" END CAP

06.30,2022 - UTILITY PERMIT SUBMISSION
09.06.2022 - UTILITY PERMIT 2ND SUBMISSION

CONSTRUCTION DOCUMENTS

UTILITY DETAILS


C3.3




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WATER SERVICE COORDINATES			
NO.	TYPE	NORTHING	EASTING
1	SANITARY LIFT STATION PER DETAIL A/C4.4	632900.10	1564468.6
2	2° 45° HORZ. BEND	632884.62	1564467.86
3	2" 45° HORZ. BEND	632879.48	1564472.59
4	2° 45° HORZ. BEND	632879.25	1564480.30
5	2° 45° HORZ, BEND	632872.06	1564487.08
6	2" 45° HORZ. BEND	632635.99	1564490.20
7	2" 45" HORZ. BEND	632631.89	1564494.80
8	2" 45° HORZ. BEND	632627.75	1564495.0
9	2° 45° HORZ. BEND	632623.15	1564490.93
10	2° 45° HORZ. BEND	632482.98	1564502.5
11	2" 45° HORZ. BEND	632481.04	1564504.9
12	2° 45° HORZ, BEND	632476.92	1564505.3
13	2" 45° HORZ. BEND	632474.50	1564503.4
14	2* 45* HORZ. BEND	632015.82	1564576.1
15	2" 45" HORZ. BEND	632010.62	1564583.4
16	2" 45" HORZ, BEND	632006.54	1564584.1
17	2" 45" HORZ. BEND	631999.22	1564578.9
18	2" 45" HORZ. BEND	631719.75	1564626.3
19	2" 45° HORZ. BEND	631715.27	1564632.6
20	2" 45" HORZ. BEND	631711.18	1564633.2
21	2" 45" HORZ, BEND	631704.89	1564628.8
22	2" 45° HORZ, BEND	631536.28	1564655.7
23	2" 45° HORZ. BEND	631531.86	1564661.7
24	2° 45° HORZ. BEND	631527.77	1564662.3
25	2" 45° HORZ. BEND	631521.76	1564657.9
26	2" 11,25° HORZ. BEND	631453.97	1564668.2
27	CONNECT TO EXISTING MANHOLE	631448.83	1564687.9



UTILITY LEGEND EXISTING

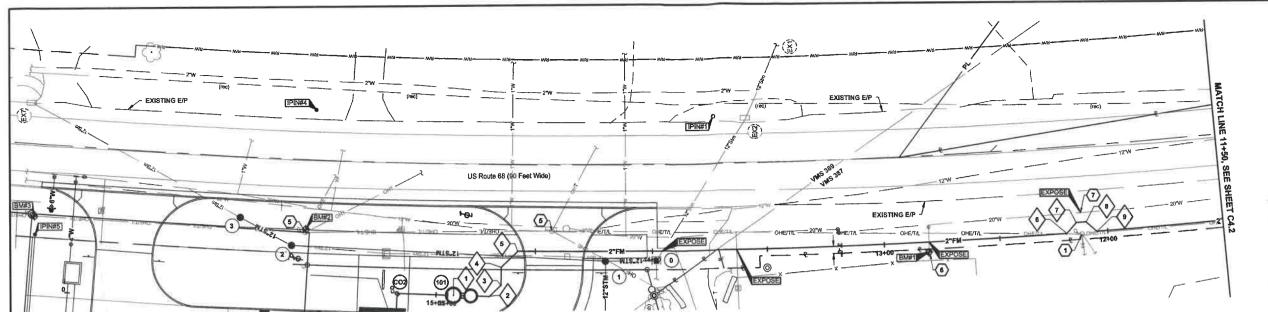PROPOSED

REFER TO SHEET TS1

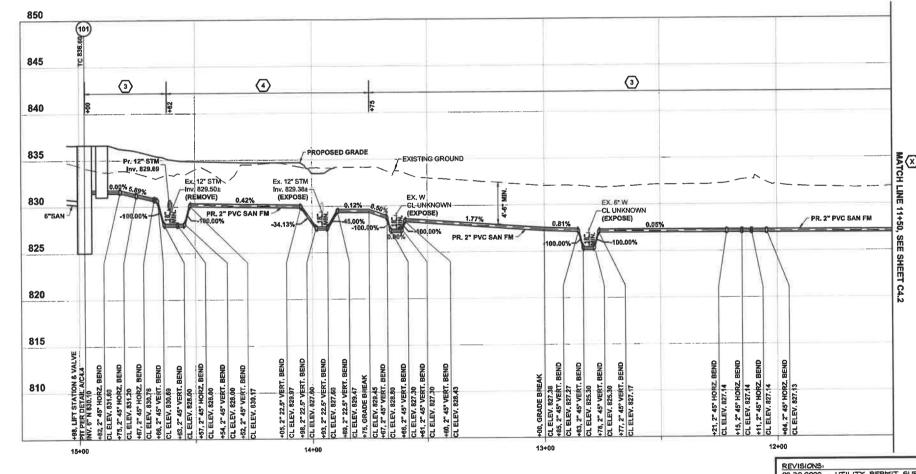SANITARY SEWER

00 LIFT STATION PER DETAIL A/C4.4

1 101

STRUCTURE NUMBER

GENERAL NOTES:

1. OBTAIN ALL PERMITS AND PAY ALL FEES NECESSARY TO


- OB JAIN ALL PERMITS AND PATALL FEES NECESSARY TO COMPLETE THE WORK SHOWN.

 MAINTAIN MINIMUM 18" VERTICAL CLEARANCE FROM THE OUTSIDE OF ANY WATERLINE PIPE TO THE OUTSIDE OF SANITARY SEWER.
- ROOF DRAINS, FOUNDATION DRAINS, AND OTHER CLEAN WATER
- ROOF DRAINS, FOUNDATION DRAINS, AND OTHER CLEAN WATER CONNECTIONS TO THE SANITARY SEWER ARE PROHIBITED. ALL COORDINATES AND ELEVATIONS BASED ON SURVEY PERFORMED BY KORDANEMETH ENGINEERING DATED 10/28/2021. REFER TO SHEET TS1. WHERE PLANS PROVIDE FOR A PROPOSED UTILITY TO BE CONNECTED TO, OR CROSS OVER, OR UNDER AN EXISTING UNDERGROUND UTILITY, THE CONTRACTOR SHALL LOCATE THE EXISTING PIPES OR UTILITIES, BOTH AS TO LINE AND GRADE DEFONDE STARTING TO LAY THE BROPOSED LITTLY. THESE BASING PIECE OF THE PROPOSED UTILITY. THESE LOCATIONS ARE NOTED THUS: EXPOSE, IF IT IS DETERMINED THAT THE ELEVATION OF THE EXPOSE UTILITY DIFFERS FROM THE PLAN ELEVATION, RESULTS IN A CHANGE IN THE PLAN SEWER SLOPE, OR WILL INTERSECT AN EXISTING UTILITY AS
- SEVER SLOPE, OR WILL INTERSECT AN EXISTING UTILITY AS SHOWN ON THE PLAN, THE ENGINEER SHALL BE NOTIFIED BEFORE STARTING CONSTRUCTION OF ANY PORTION OF THE PROPOSED UTILITY WHICH WILL BE AFFECTED BY THE VARIANCE IN THE EXISTING ELEVATIONS.
 SUPPORT AND PROTECT ALL UTILITIES EXPOSED DURING EXCAVATION AND TRENCHING.
 MAINTAIN MINIMUM 4'-6' COVER OVER SANITARY FORCE MAIN. PERFORM SANITARY WORK IN ACCORDANCE WITH CITY OF XENIA MATERIALS AND CONSTRUCTION SPECIFICATIONS AND STANDARD CONSTRUCTION DRAWNINGS. IN CASE OF DISCREPANCY BETWEEN CITY OF XENIA STANDARDS AND PROJECT SPECIFICATION, CITY OF XENIA STANDARDS SHALL GOVERN.
- GOVERN. PROVIDE MAINTENANCE OF TRAFFIC IN ACCORDANCE WITH THE OHIO MANUAL OF UNIFORM TRAFFIC CONTROL DEVICES (OMUTCD).

ŠX CODED NOTES:

SUPPORT EXISTING UTILITY POLE AS NECESSARY DURING INSTALLATION OF SANITARY SEWER. COORDINATE WITH POLE

- 2. SUPPORT AND PROTECT EXISTING HEADWALL TO REMAIN.
- 3. BACKFILL WITH COMPACTED BACKFILL TYPE D PER SPECIFICATION SECTION 31 00 00 AND 31 23 33.
- BACKFILL WITH COMPACTED GRANULAR BACKFILL TYPE A OR J PER SPECIFICATION SECTION 31 00 00 AND 31 23 33.
- 5. UTILITY POLE TO BE RELOCATED.
- 6. PROTECT AND SUPPORT EXISTING FIRE HYDRANT.
- 7. CONTRACTOR SHALL FIELD VERIFY HORIZONTAL LOCATION AND ELEVATION OF EXISTING 20" WATER MAIN PRIOR TO COMMENCING WORK ON SANITARY FORCE MAIN INSTALLATION. IMMEDIATELY NOTIFY THE ENGINEER IF WATER MAIN LOCATION OR ELEVATION DIFFERS FROM THOSE SHOWN ON THIS PLAN.

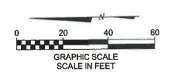

08.30.2022 - UTILITY PERMIT SUBMISSION
09.08.2022 - UTILITY PERMIT 2ND SUBMISSION KORDA KORDA NEMETH ENGINEERIN 1650 WATERMARK DRIV SUITE 200 COLUMBUS, OHIO 43215

CONSTRUCTION DOCUMENTS

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HISTORIC OLDTOWN **NEW INTERPRETIVE CENTER** 1575 US-68, XENIA, OHIO 45385

PROJECT NUMBER: 2021-00 DESIGNED BY: JOB NUMBER: DNR-210003 DRAWN BY: JDB SCALE: AS NOTED CMF PERMIT DATE: 02.25.2022 CHECKED BY: XX DRAWING DATE: APPROVED BY:

ORAWN BY: JDB DESIGNED BY: JDB

HECKED BY: CMF

SANITARY PLAN & PROFILE

C4.1



