

#5025

FED. RD. DIVISION	STATE	PROJECT
2	OHIO	STATE

1
4


SAN-590-(11.75-12.03)

STATE OF OHIO
DEPARTMENT OF HIGHWAYS
SAN-590-(11.75-12.03)
SANDUSKY COUNTY
VILLAGE OF LINDSEY

PART 1
FOR PART 2 SEE
SAN-600-(4.27-5.41)

CONVENTIONAL SIGNS

Center Line
Corporation Line
Property Line
Pole Line
Railroads

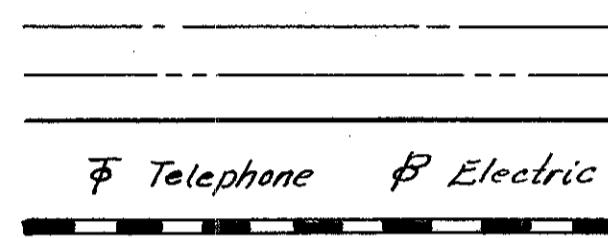

End Work Sta. 642+07
End Project Sta. 641+84

INDEX OF SHEETS


Title Sheet
Typical Sections
General Notes
General Summary
Plan & Profile
Pavement Computation

1
2
2
2
3-4
4

Begin Work Sta. 620+54.26
Begin Project Sta. 621+00

LINE DATA

Begin Work Sta. 620+54.26
Begin Project Sta. 621+00
End Project Sta. 641+84
End Work Sta. 642+07
Gross Length of Project = 2084.00 Lin.Ft.
Deduct for Railroad Crossing
Sta. 628+67.45 to Sta. 629+08.60 = 21.15 Lin.Ft.
Net Length of Project = 2062.85 Lin.Ft. = 0.391 Mile
Gross Length of Work = 2152.74 Lin.Ft.
Deduct for Railroad
21.15 Lin.Ft.
Net Length of Work = 2131.59 Lin.Ft. = 0.403 Miles

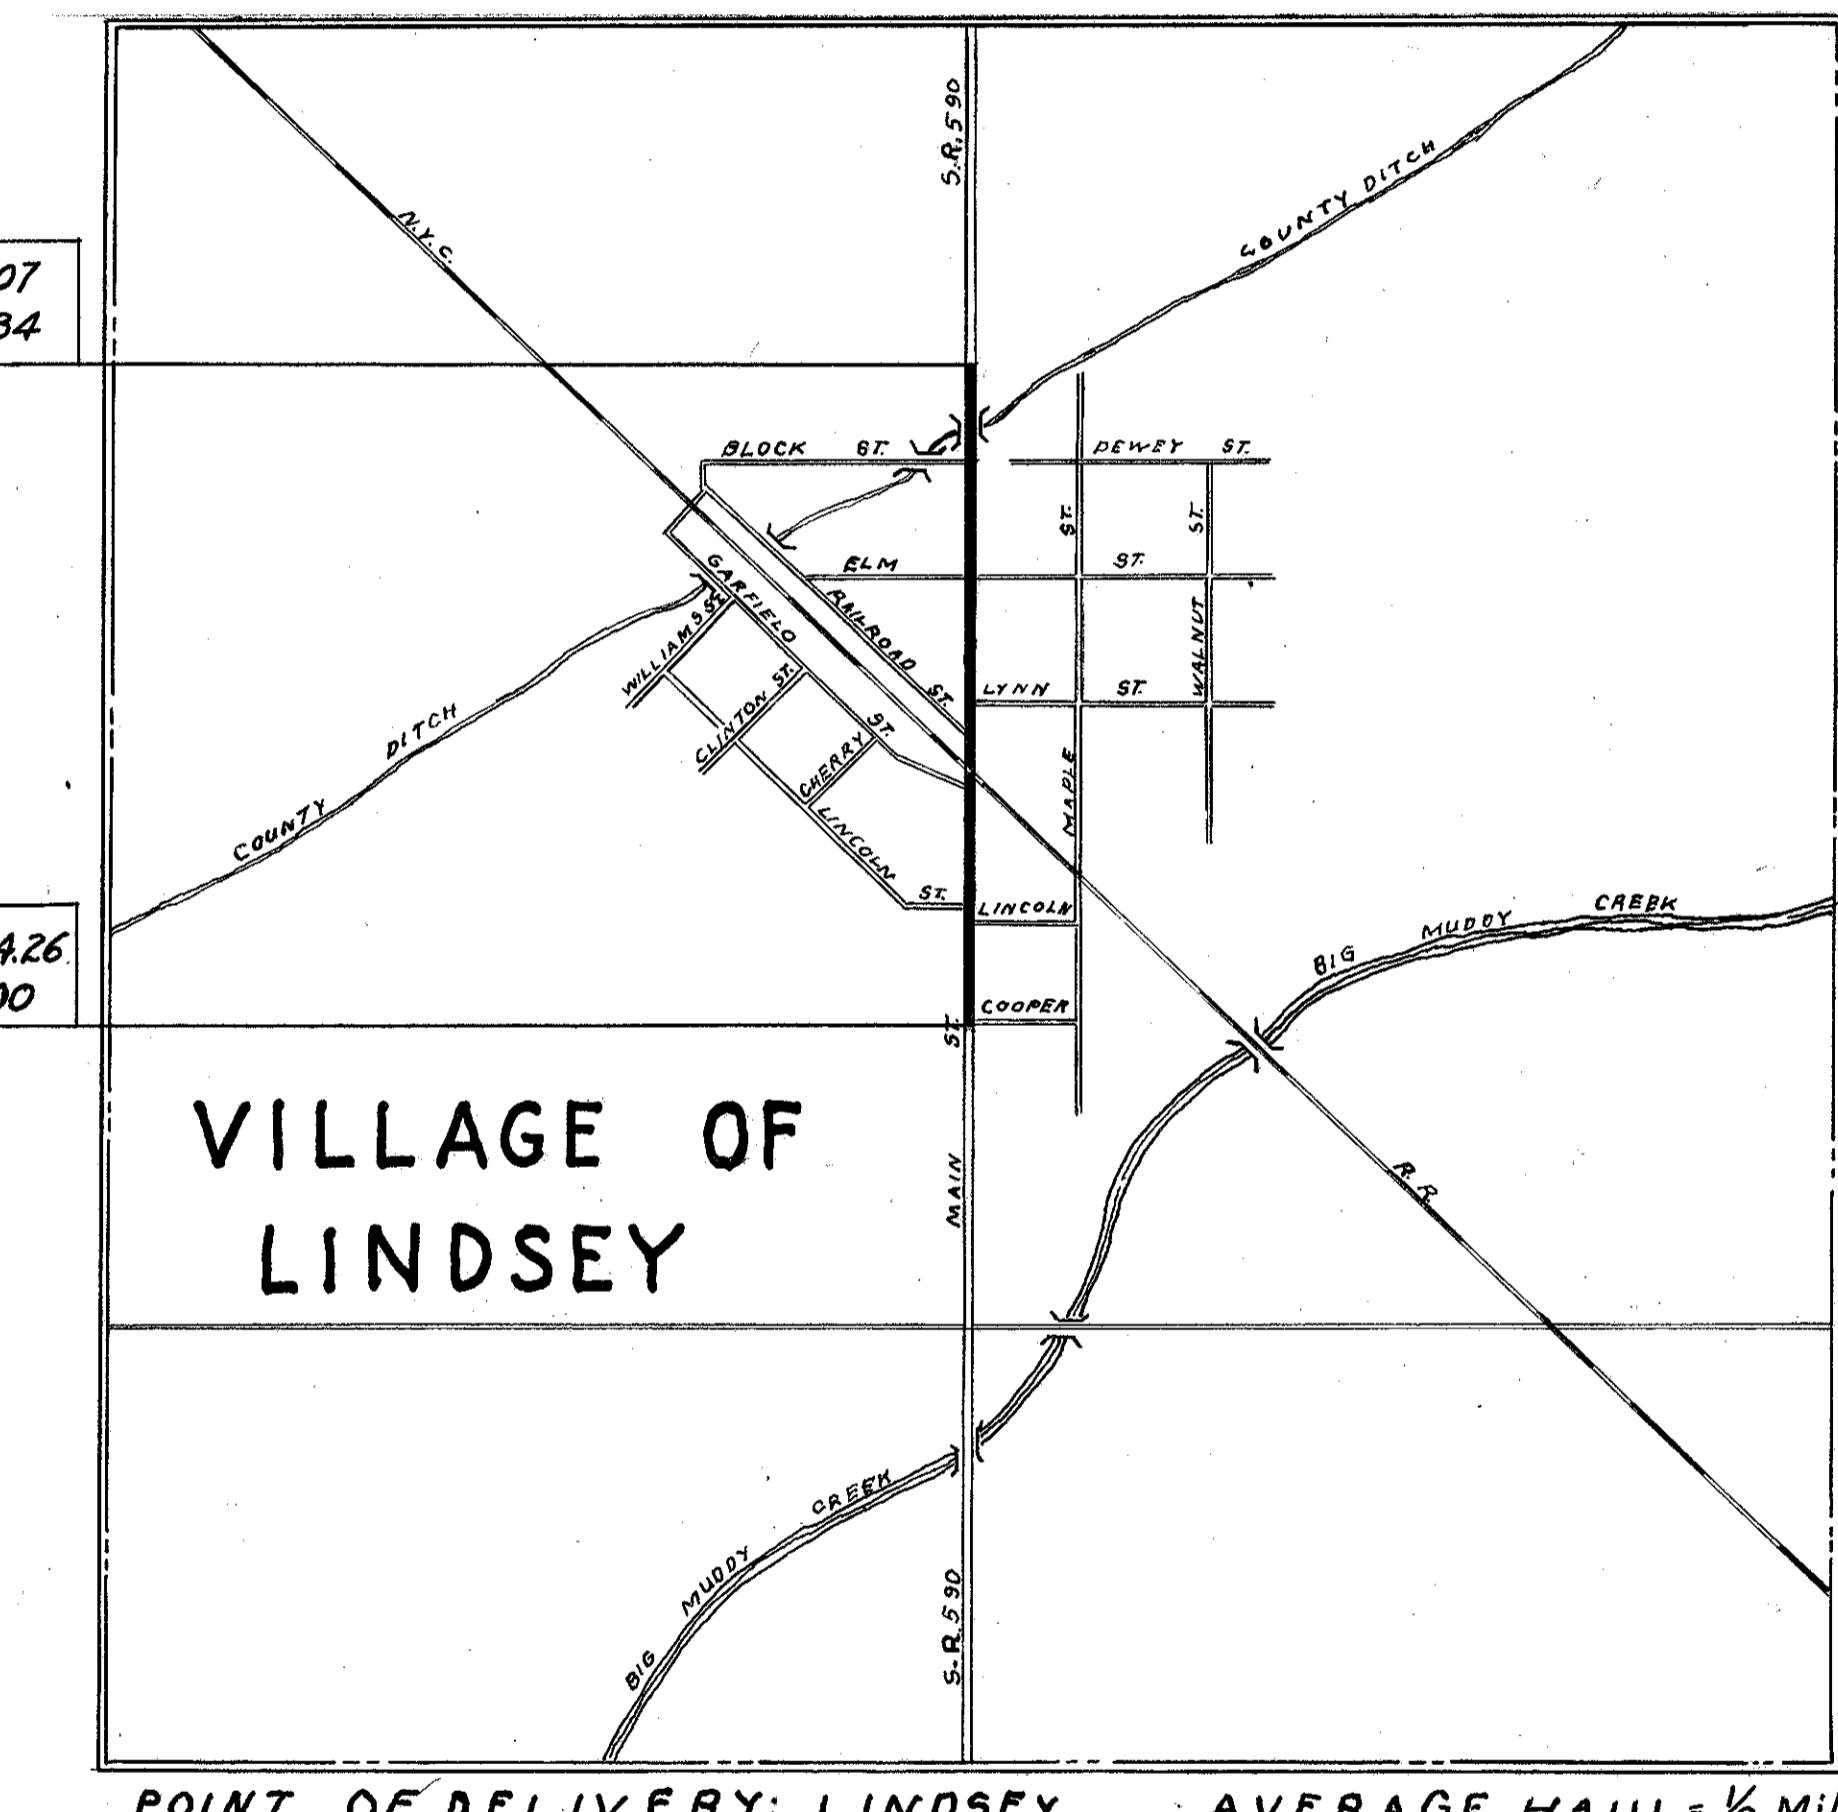**LOCATION PLAN**
Scale

0' 300' 600' 1200' 1800'

PORTION TO BE IMPROVED
STATE HIGHWAYS
OTHER ROADS
DETOUR
NONE

The Standard Specification of The State of Ohio,
Department of Highways, including changes and Supplemental
Specifications listed in proposal shall govern this improvement.

I hereby approve these plans and declare that the making of
this improvement will not require the closing to traffic of
the highway and that provisions for maintenance and safety
of traffic will be as set forth in these plans and estimates.

The right of way for this improvement will be provided by
The State of Ohio.

Approved George W. Reiter
Date June 20 1955 Division Deputy Director

Approved John J. Keller
Date 6-28-55 Deputy Director of Planning & Programming

Approved M. H. R. [Signature]
Date 6-27-55 Engineer of Location & Design

Approved Richard Orth
Date 6/24/55 Engineer of Bridges

Approved H. F. Gould
Date 6-27-55 Deputy Director of Design & Construction

Approved V. J. Schaeffer
Date 6-28-55 First Assistant Director

Approved J. G. Howell
Date 6-27-55 Director of Highways

Print Approved Paul G. Schneider
Date 6-21-55 Mayor of Lindsey

CONSTRUCTION
BUREAU
FEB 18 1957
GROUND PHOTOLAB

STANDARD DRAWINGS	
T-35	10-1-52

SUPPLEMENTAL SPECIFICATIONS	


FED. RD. DIVISION	STATE	PROJECT	
2	OHIO		

2
4

SAN-590-(11.75-12.03)

TYPICAL SECTION TYPE - T-35

Existing Pavement - Typical Section "A", "B", "C"
brick with sand filler.

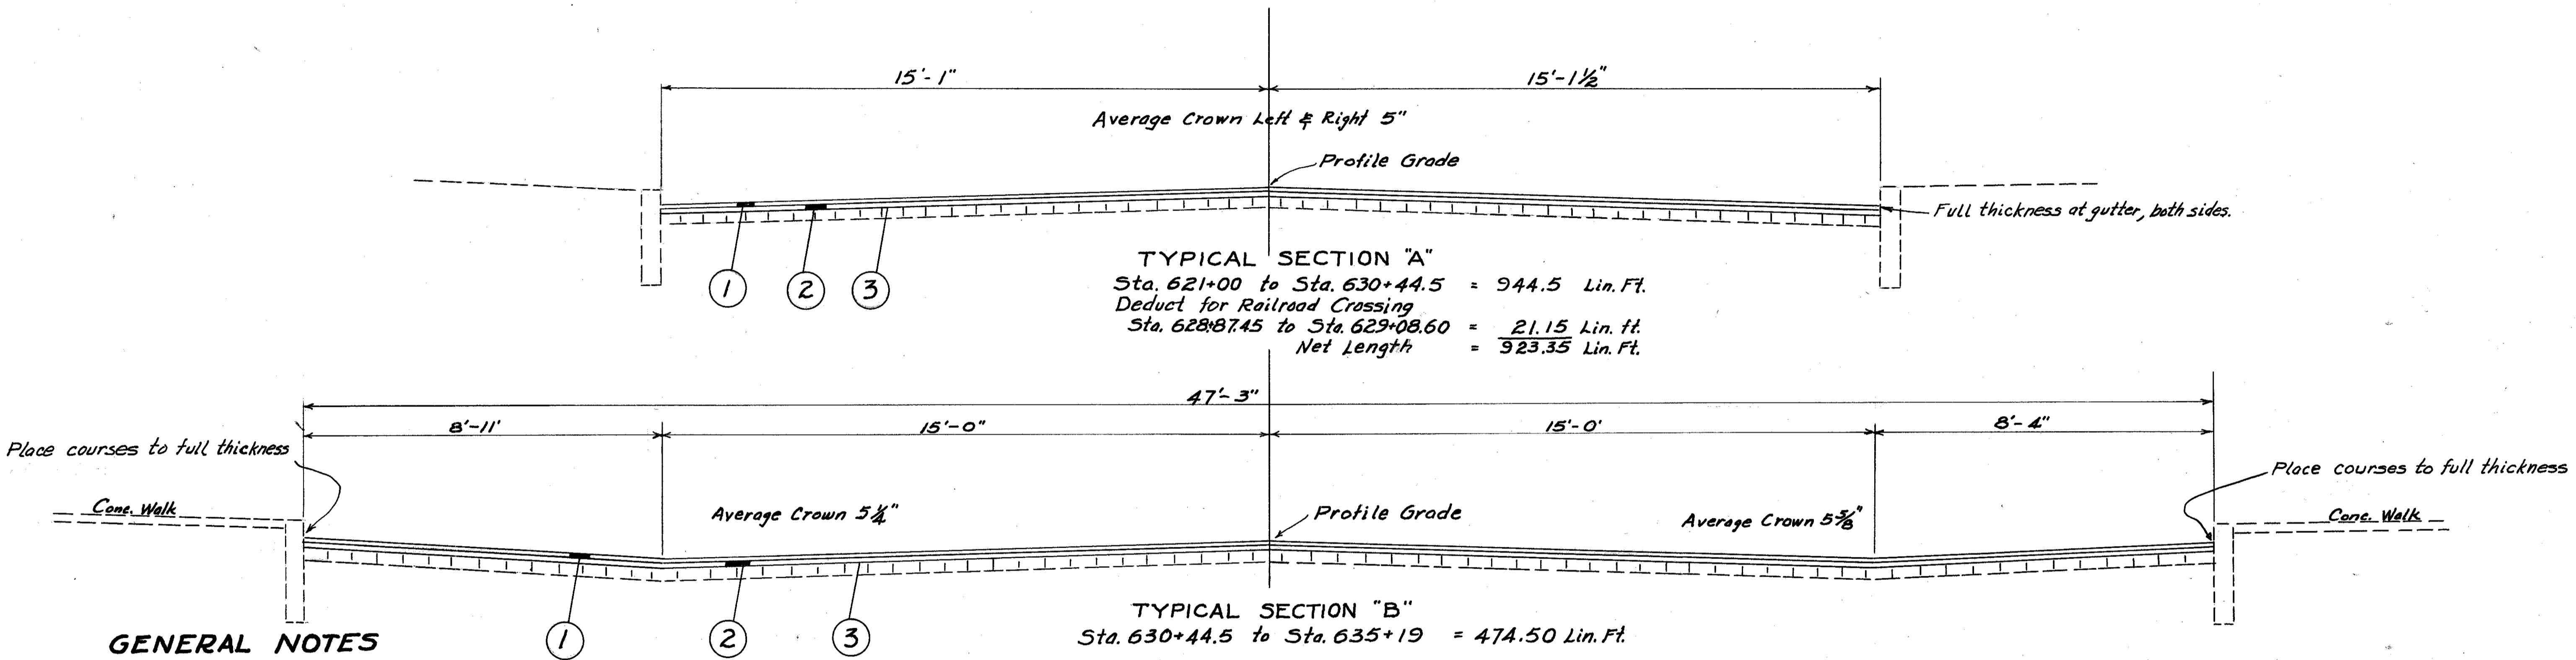

GENERAL NOTES

CONTROL POINTS: Before construction operations begin, the Engineer will reference all existing monuments, railroad spikes, iron bolts, etc on the survey line. Upon completion of the surface, the Engineer will reestablish all these control points in the new pavement.

ALIGNMENT & PROFILE: This Project proposes no change in the alignment of the existing construction on the length now proposed for resurfacing.

The profile of the proposed surface course shall be approximately 2 1/4 inches above that of the existing pavement.

UTILITIES: All work required to relocate and/or adjust, etc. all gas, telephone, electric, water and other services to conform to the new grade shall be done by the utilities in question.


TRAFFIC: Traffic shall be maintained at all times. The length of one-way traffic zone shall be kept to a minimum consistent with the specification requirements for the protection of the wearing course.

FILLING MAJOR DEPRESSIONS: Major depressions in the existing pavement shall be filled and compacted with bituminous concrete material in advance of placing the regular leveling course. These depressions shall be filled in layers not to exceed 3" in depth when compacted.

FEATHERING: The new surface course shall be feathered to meet existing catch basins, flume inlets, railroad crossings and at driveways, approach pavements and at beginning and end of work.

DRIVEWAYS: No work shall be done on resident or commercial driveways except where shown otherwise in the plan.

UTILITY OWNERSHIP:
 Electric Toledo Edison Co. - Toledo, Ohio.
 Telephone Ohio Bell Telephone Co - Fremont, Ohio.

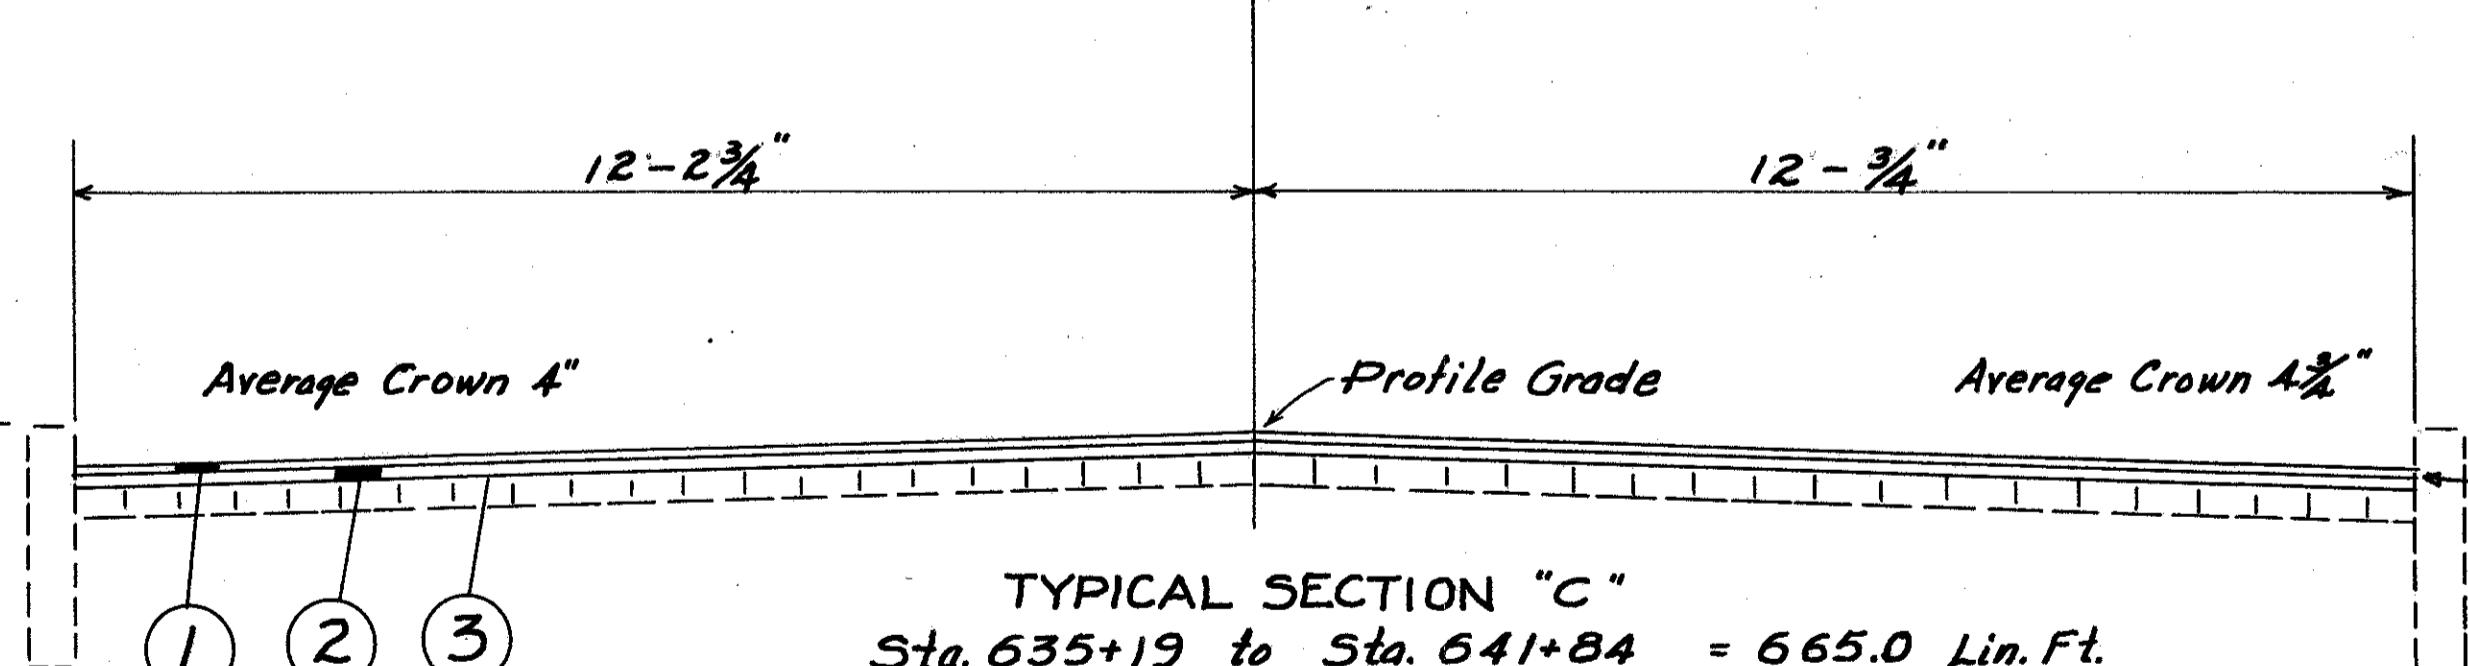


- (1) Item T-35, 1" Asphaltic Concrete Surface Course, Type "C" (70-80)
- (2) Item B-35, 1 1/4" Minimum Thickness Asphaltic Concrete Leveling Course, (70-80).
- (3) Item T-30, Bituminous Tack Coat, Sec. M-5.5 MS-2 or RS-1, or Sec. M-5.2 RC-1 or RC-2 applied at the rate of 0.10 gal per sq. yd.
See note in proposal

GENERAL SUMMARY

Item	Quantities	Unit	Description
Roadway & Pavement			
I-8	1	Each	Manhole adjusted to grade.
B-35	375	Cu. Yds.	Asphaltic Concrete Leveling Course (70-80)
T-35	227	Cu. Yds.	Asphaltic Concrete Surface Course, Type "C" (70-80)
T-30	822	Gals.	Bituminous Tack Coat, as per plan

Begin Sheet Sta. 636+00

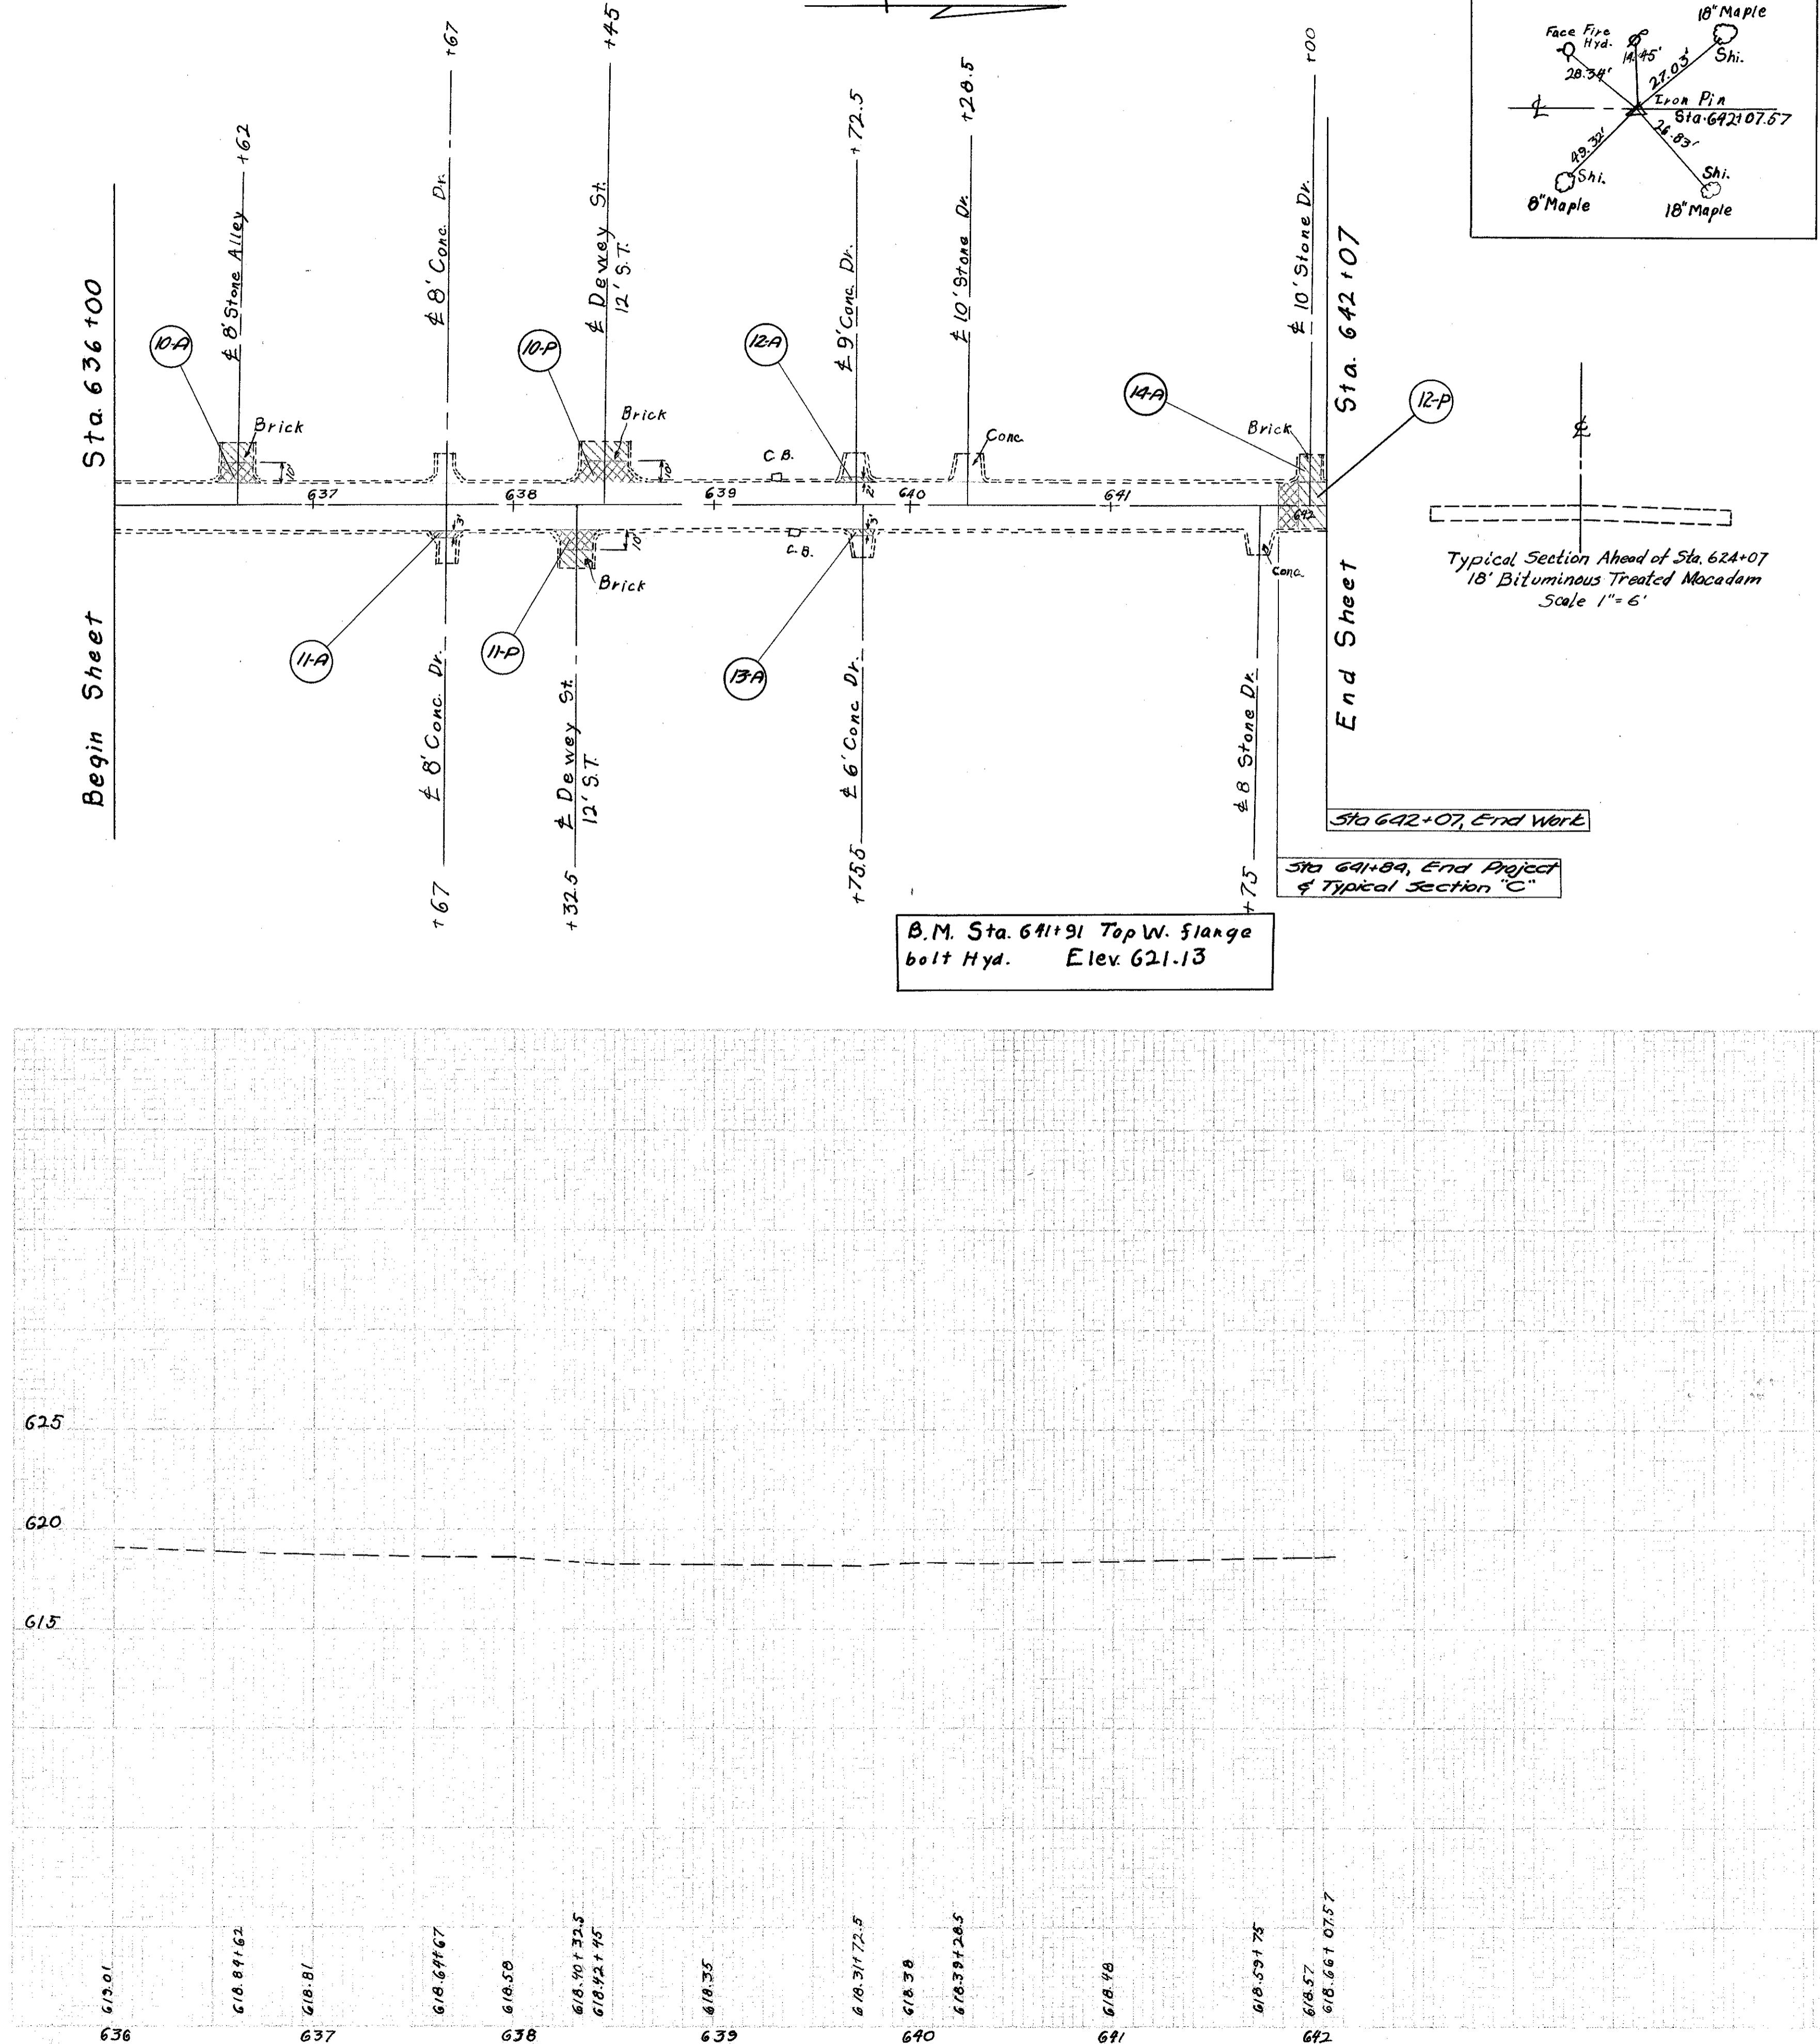

PAVEMENT COMPUTATION

Net Length from Typical Sections.
 Section "A" = 923.35 Ft.
 Section "B" = 474.50 Ft.
 Section "C" = 665.00 Ft.

SAN-590-(11.75-12.03)

44

Item T-35, Asphaltic Concrete Surface Course.
 Section "A"

$$\text{Width} = 15.08 + 15.12 = 30.20 \text{ Ft.}$$

$$\text{Area} = 923.35 \times 30.20 + 9 = 3098.35 \text{ sq.yds.}$$

$$(3098.35 + 36) / 9 = 86.06 \text{ cu.yds.}$$

Section "B"

$$\text{Width} = 47.25 \text{ Ft.}$$

$$\text{Area} = 474.50 \times 47.25 + 9 = 2491.02 \text{ sq.yds.}$$

$$(2491.02 + 36) / 9 = 69.20 \text{ cu.yds.}$$

Section "C"

$$\text{Width} = 12.22 + 12.06 = 24.28 \text{ Ft.}$$

$$\text{Area} = 665.00 \times 24.28 + 9 = 1794.05 \text{ sq.yds.}$$

$$(1794.05 + 36) / 9 = 49.83 \text{ cu.yds.}$$

Subtotal $\frac{205.09}{205.09} \text{ cu.yds.}$
 Add from Extra Pavement Item (1-P to 12-P) $\frac{17.07}{17.07} \text{ cu.yds.}$
 Add from Driveways (1-A to 14-A) $\frac{4.05}{4.05} \text{ cu.yds.}$
 Total $\frac{226.21}{226.21} \text{ cu.yds.}$

Use 227 cu.yds.

Item T-30, Bituminous Tack Coat

Section "A" Area = 3098.22 sq.yds.
 Section "B" Area = 2491.02 sq.yds.
 Section "C" Area = 1794.05 sq.yds.
 Total Area = 7383.42 sq.yds.

$$7383.42 \times 0.10 = 738.34 \text{ gals.}$$

Add from Extra Pavement (1-P to 12-P) $\frac{68.40}{68.40} \text{ gals.}$
 Add from Driveways (1-A to 14-A) $\frac{14.90}{14.90} \text{ gals.}$
 Total $\frac{821.64}{821.64} \text{ gals.}$

Use 822 gals.

Item B-35, Asphaltic Concrete Leveling Course.
 (Area same as for T-35 quantities)

Section "A" Area = 3098.35 sq.yds.
 $(3098.35 + 36) / 9 = 107.58 \text{ cu.yds.}$

Section "B"

Area = 2491.02 sq.yds.
 $(2491.02 + 36) / 9 = 86.50 \text{ cu.yds.}$

Section "C"

Area = 1794.05 sq.yds.
 $(1794.05 + 36) / 9 = 62.29 \text{ cu.yds.}$

Subtotal $\frac{256.37}{256.37} \text{ cu.yds.}$
 Add from Extra Pavement (1-P to 12-P) $\frac{13.54}{13.54} \text{ cu.yds.}$
 Add from Driveways (1-A to 14-A) $\frac{2.51}{2.51} \text{ cu.yds.}$
 Add for Surface irregularities $\frac{102.00}{102.00} \text{ cu.yds.}$
 Total $\frac{374.42}{374.42} \text{ cu.yds.}$

Use 375 cu.yds

10 OHIO

1939

SANDUSKY COUNTY
S.H. 931-SEC. GIBSONSBURG (PT.)

6

9

STREET

BEGIN

682.98
682.93
682.96
682.95

682.74

682.49

682.15

682.10
682.04
682.00

681.68

681.54

681.26

681.25
681.14
681.04

680.94

680.91

681.16


681.24

681.73


681.89

681.16

N

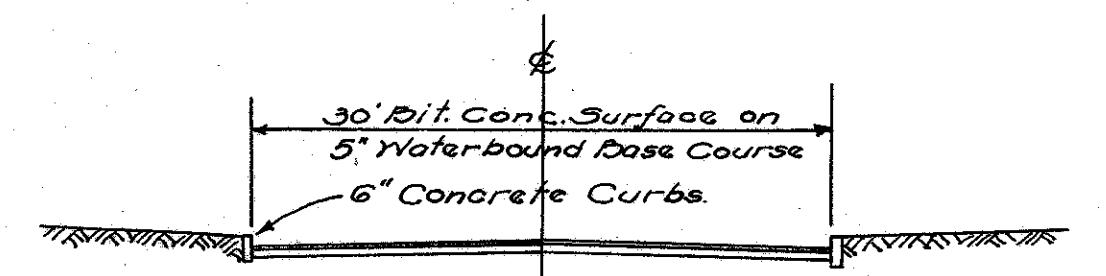Sta. 55+10.3
End of ProjectEnd of Existing 30'
Brick Pavement with
6" Raised Stone Curbs

TYPICAL SECTION OF ADJOINING PAVT.

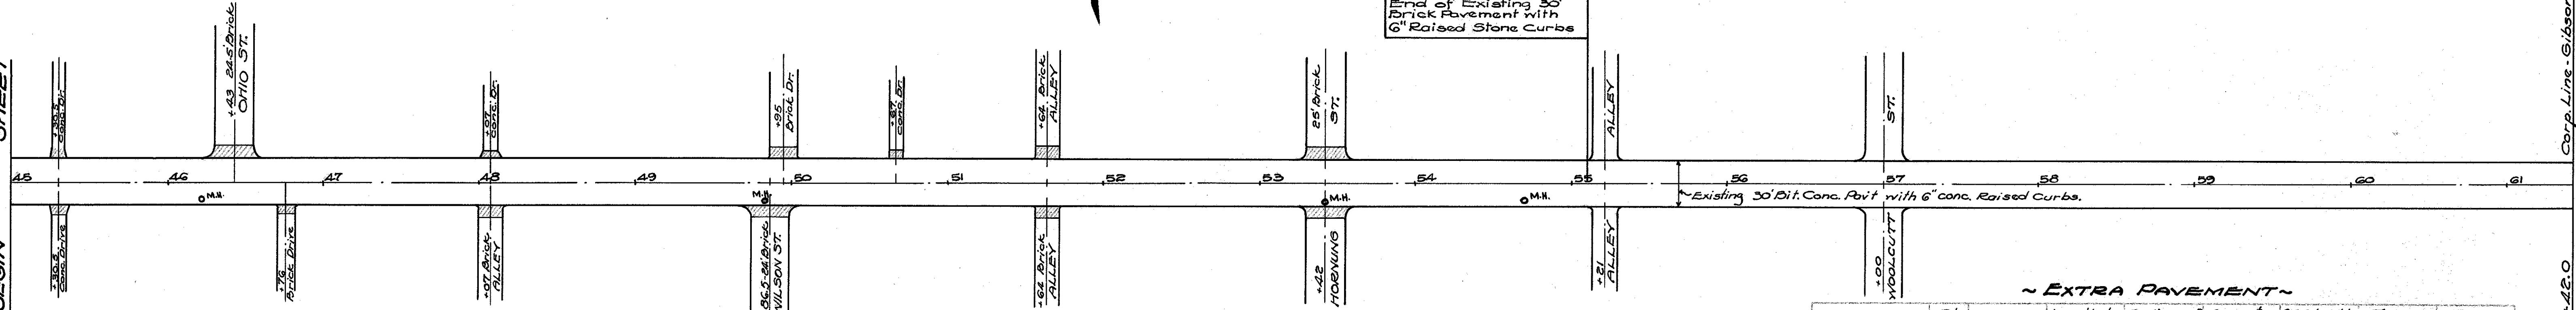MANHOLE TOPS AND POOL GRATE
INLETS ADJUSTED TO GRADE

Station	Rt. or Lt.	Existing M.H. Tops Adjusted	Existing Pool Grates Adjusted	to Grade-Each to Grade-Each
46+21	Rt.	1		
49+86	Rt.	1		
53+42	Rt.	1		
54+70	Rt.	1		
Total				4

B.M. N.E. Cor. 1st Step Residence #605 E. Madison St.
Elev. 682.35

685

680

675

670

685

680

675

670


Profile of Existing Pavement

Station	Rt. or Lt.	Width Lin.Ft.	Length to be Surfaced Lin.Ft.	Radius of Curved Curbs Lin.Ft.	Area to be Surfaced Sq.Yds.	T-35 Thicknes Course Cu.Yds.	T-35 Surface Course Cu.Yds.	T-30 Bituminous Prime Coat Cu.Yds.
45+30.5	Rt.	10.0	6	2	7.0	0.15	0.19	0.7
45+30.5	Lt.	8.0	6	1	5.6	0.10	0.16	0.6
46+43	Lt.	8.5	8	8	25.0	0.50	0.70	2.5
46+76	Rt.	10.5	6	2	7.0	0.15	0.19	0.7
48+07	Rt.	15.0	8	1	13.5	0.25	0.38	1.4
48+07	Lt.	12.0	4	1	5.5	0.10	0.16	0.6
49+86.5	Rt.	24.0	8	8	24.5	0.50	0.68	2.5
49+95	Lt.	17.5	6	1	11.5	0.20	0.32	1.2
50+67	Lt.	7.0	6	1	5.0	0.10	0.14	0.5
51+64	Rt.	15.0	8	1	13.5	0.25	0.38	1.4
51+64	Lt.	15.0	8	1	13.5	0.25	0.38	1.4
53+42	Rt.	25.0	8	8	25.5	0.50	0.71	2.6
53+42	Lt.	25.0	8	8	25.5	0.50	0.71	2.6
Total					182.5	3.55	5.10	18.7

Core Line-Gibsonburg

+42.0

10 OHIO 1939 9
SANDUSKY COUNTY
S.H. 931-SEC. GIBSONBURG(PT.)

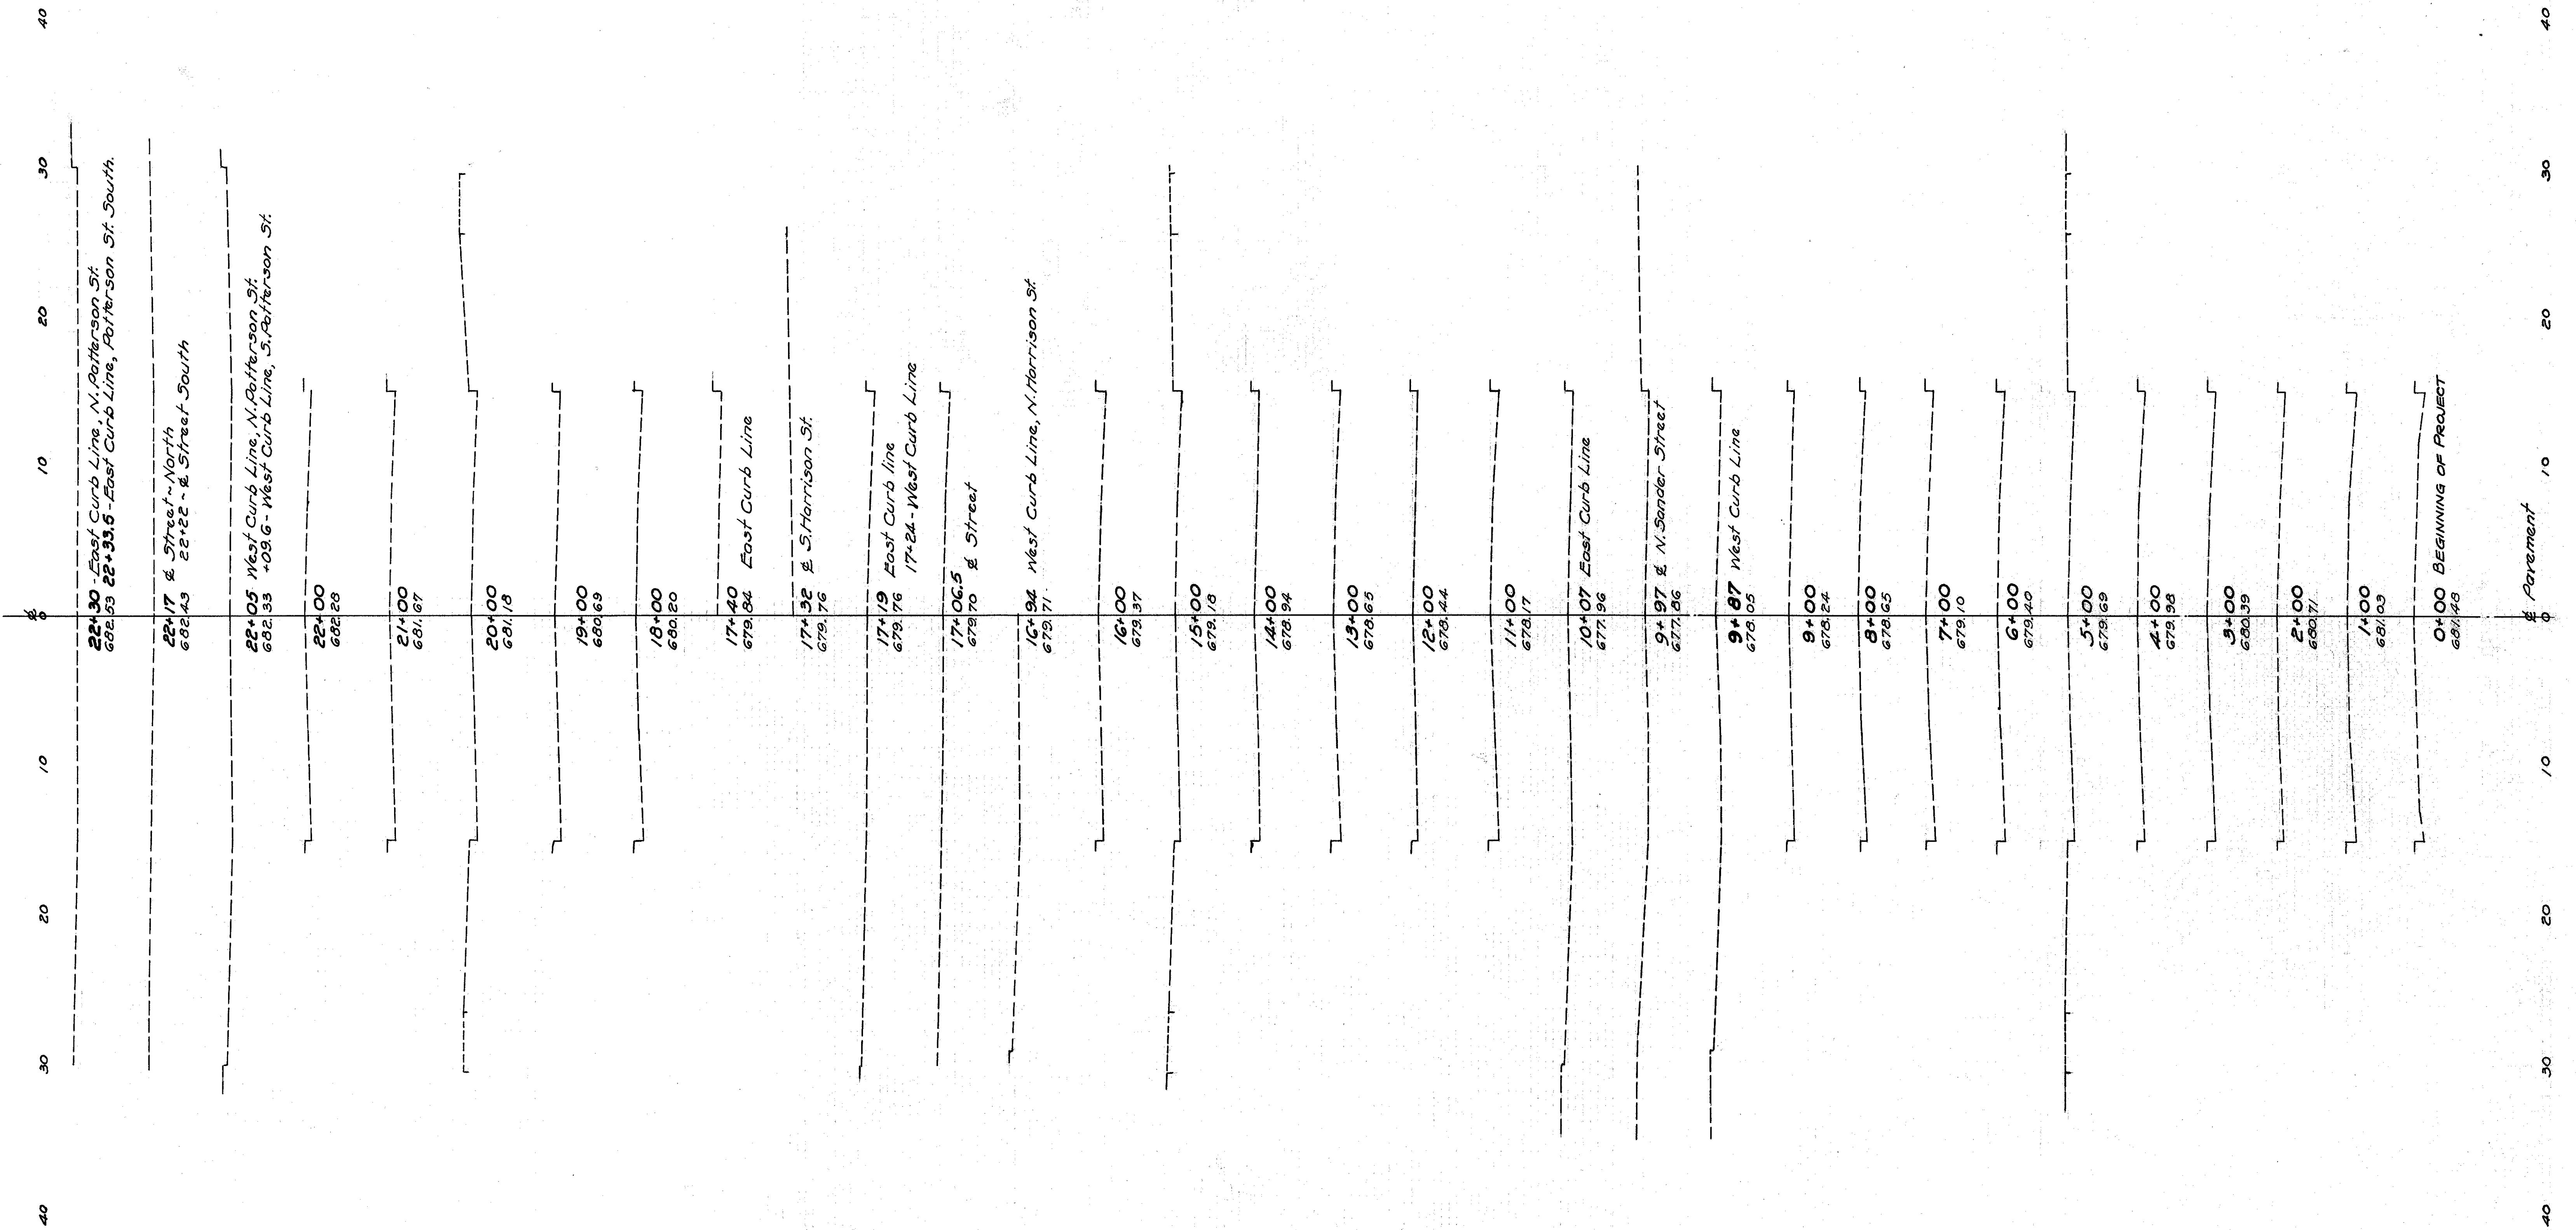

10 OHIO 1939 SANDUSKY COUNTY
S.H. 931-SEC. GIBSONBURG(PT.) 8 9

#5025



FED. RD. DIST. NO.	STATE	PROJECT	FISCAL YEAR
10 OHIO			1939 9

SANDUSKY COUNTY
S.H.931 SEC."GIBSONBURG"(PT.)

STATE OF OHIO
DEPARTMENT OF HIGHWAYS
HESSVILLE-GIBSONBURG-WEST ROAD
S.H.931 SEC. "GIBSONBURG"(PT.)
SANDUSKY COUNTY
VILLAGE OF GIBSONBURG

CONVENTIONAL SIGNS

Township Line
Section Line
City or Village Line
Property Line
Fence
Center Line
Steam Railroad
Pole Line-Electric
Pole Line-Telephone

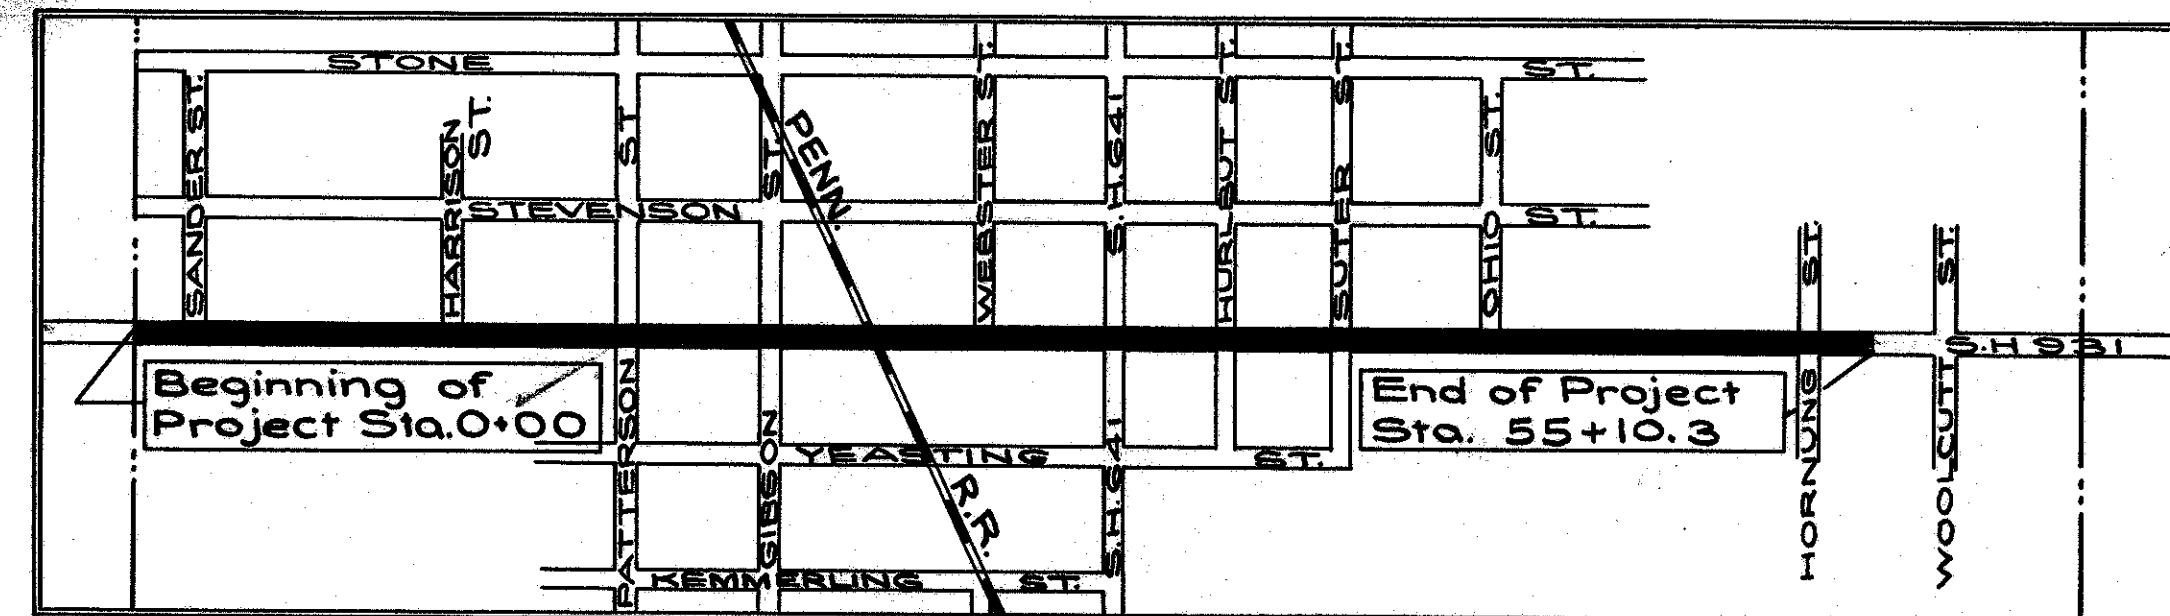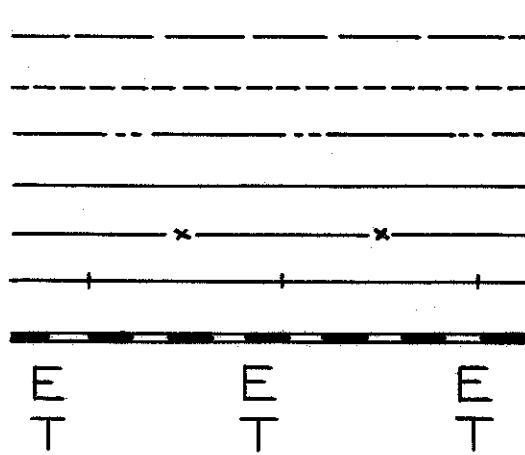

PART OF VILLAGE OF GIBSONBURG
Scale 1 inch = 500 ft.

INDEX OF SHEETS

TITLE SHEET
TYPICAL SECTION
PLAN AND PROFILE
CROSS-SECTIONS
SUMMARY

1
2
3-6
7-9
2

LINE DATA

Beginning of Project Sta. 0+00
End of Project Sta. 55+10.3
Gross Length of Project = 5510.3 Lin.Ft.
Deductions:-

Railroad Crossing (Sta. 28+29.5 to 28+52.5) = 23.0 Lin.Ft.
Railroad Crossing (Sta. 29+07 to 29+16.5) = 9.5 Lin.Ft.

Total Deduction = 32.5 Lin.Ft.


Net Length of Project = 5477.8 Lin. Ft. or 1.037 Miles.



Portion to be improved
State highways
Other roads

STANDARD Number	DRAWINGS Date
G-7.07	10-1933

SCALES
Plan 1" = 50'
Profile-Horizontal 1" = 50'
Vertical 1" = 5'
Cross Sections 1" = 5'

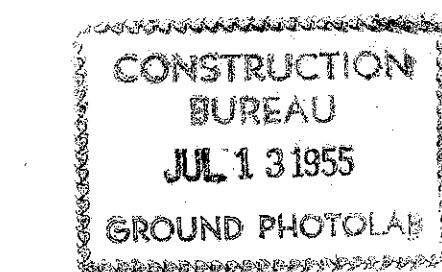

I hereby approve these plans and declare that the making of this improvement will not require the closing to traffic of the highway.

The Standard Specifications of the State of Ohio, Department of Highways, including changes and Supplemental Specifications listed in the proposal shall govern this improvement.

The right of way necessary for this improvement will be provided by the State of Ohio.

Approved _____
Date _____ Resident District Deputy Director

Approved *T.S. Adams*
Date 8/1/39 Resident Division Deputy Director

Approved _____
Date _____ Chief Engineer, Bureau of Maintenance

Approved *G. Blogue P.E. 25*
Date 8/18/39 Chief Engineer, Location and Right-of-Way

Approved *P. J. St. John*
Date 8/1/39 First Asst. Director & Chief Engineer


Approved *P. D. Beylette*
Date 8/19/39 Director of Highways

FED. RD. DIST. NO.	STATE	PROJECT	FISCAL YEAR
10	OHIO	1939	2 9


SANDUSKY COUNTY
SH.931-SEC.GIBSONBURG(PT.)

TYPIICAL SECTION

TYPE - T-35

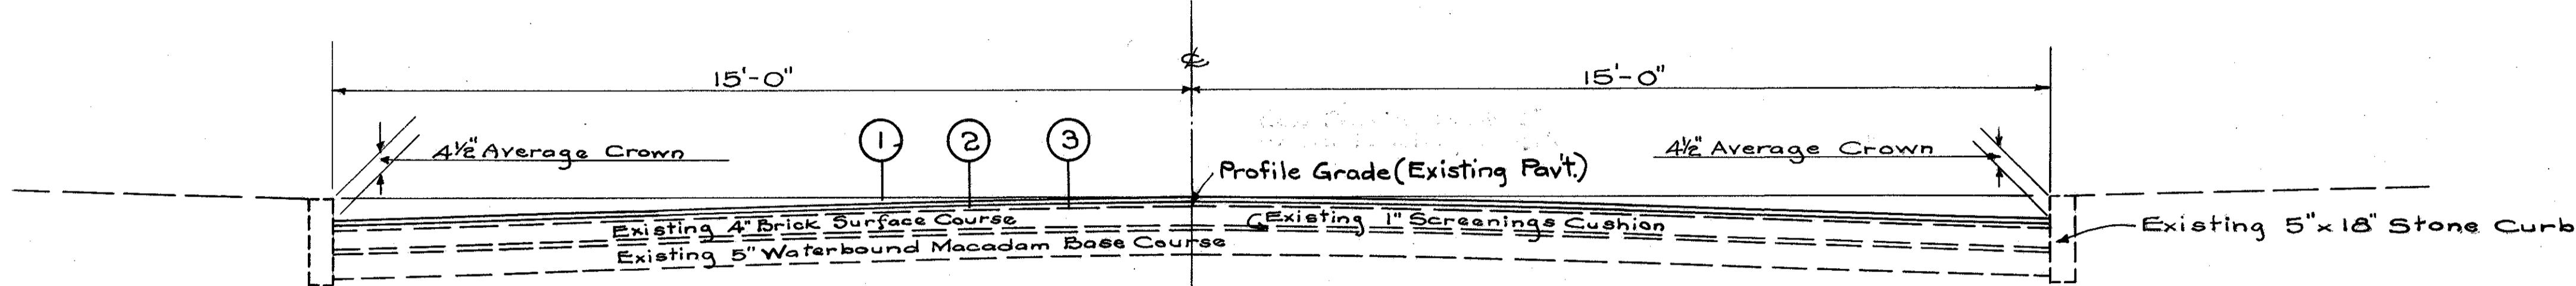

Typical Section:- Station 0+00 to Station 25+76 = 2576.0 Lin. Ft.
Station 36+40.5 to Station 55+10.3 = 1869.8 Lin. Ft.
Net Length = 4445.8 Lin. Ft.

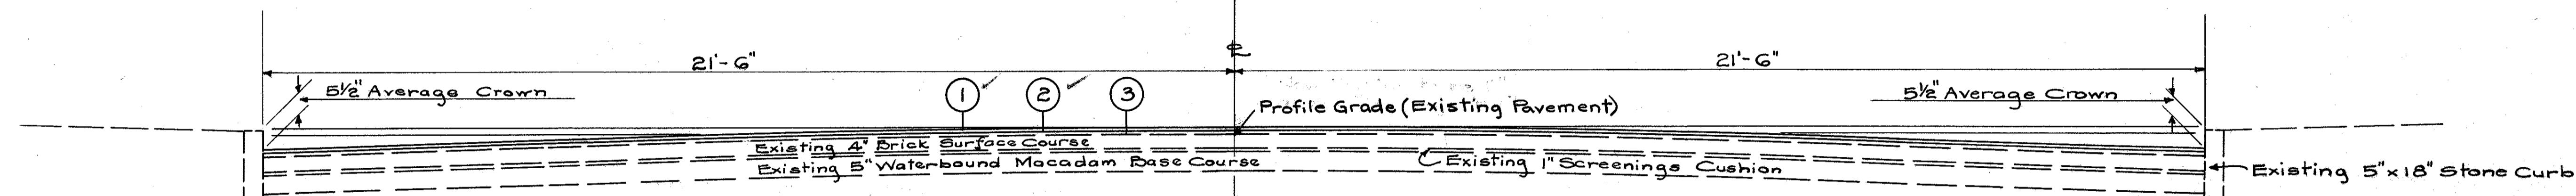

Typical Section:- Station 25+76 to Station 36+40.5 = 1064.5 Lin. Ft.

Deductions:- Double Railroad Tracks (Sta. 28+29.5 to 28+52.5) = 23.0 Lin. Ft.
Single Railroad Track (Sta. 29+07 to 29+16.5) = 9.5 Lin. Ft.
Total Deductions = 32.5 Lin. Ft.
Net Length of Typical Section as above = 1032.0 Lin. Ft.

- ① Item T-35, 1" Asphaltic Concrete Surface Course, Type "B"
- ② Item B-35, 1" Minimum Thickness Asphaltic Concrete Leveling Course
- ③ Item T-30, Bituminous Prime Coat using Bituminous Material, Sec. M-5.12 A.E. 3 applied at the rate of not more than 0.1 gal. per Sq. Yd. and Sand Cover, 4 to 7 lbs. per Sq. yd.

~ PAVEMENT COMPUTATIONS ~

Beginning of Project Sta. 0+00, End of Project Sta. 55+10.3

Gross Length of Project = 5510.3 Lin. Ft.

Deductions:-

Double Track Railroad Crossing (Sta. 28+29.5 to 28+52.5) = 23.0 Lin. Ft.
Single Track Railroad Crossing (Sta. 29+07 to 29+16.5) = 9.5 Lin. Ft.
Total Deductions = 32.5 Lin. Ft.

Net Length of Project = 5477.8 Lin. Ft. or 1.037 Miles.

Net Length of 30' Pavement (from Typical Section) = 4445.8 Lin. Ft.
Area of 30' Pavement = (4445.8 x 30) ÷ 9 = 14819.33 Sq. Yds.

Net Length of 43' Pavement (from Typical Section) = 1032.0 Lin. Ft.
Area of 43' Pavement = (1032.0 x 43) ÷ 9 = 4930.67 Sq. Yds.

Area of 30' Pavement + Area 43' Pavement = 19750.0 Sq. Yds.

Item T-30 Bituminous Prime Coat (0.10 Gal. per Sq.Yd.) applied only to area of Existing Pavement to be resurfaced =

$19750 \times 0.10 = 1,975.0$ Gals.
Add for Intersections and Drives (From Summary) = 94.0 Gals.
Total T-30 = 2069.0 Gals.

Item B-35 Variable Thickness Leveling Course (1" Minimum Thickness).

$(19750 \times 1) \div 36 = 548.61$ Cu.Yds.

Estimated Volume of Extra Leveling Course Material required to shape up from existing crown to new crown, to fill depressions in existing pavement, etc. = 125.0 Cu.Yds.

Estimated Volume of Extra Leveling Course Material required at intersections and drives (From Summary) = 18.31 Cu.Yds.
Total Variable Thickness, B-35 = 691.92 Cu.Yds.
Use 692 Cu.Yds.

Item T-35 1" Surface Course, Type "B"

$(19750 \times 1) \div 36 = 548.61$ Cu.Yds.

Add for Intersections and Drives (Summary) = 25.78 Cu.Yds.

Total T-35 = 574.39 Cu.Yds.

Use 575 Cu.Yds.

~ GENERAL NOTES ~

TRAFFIC ~ Traffic shall be maintained at all times to the satisfaction of the Division Engineer. The item of maintaining shall include furnishing lights, signs, barricades and watchmen necessary to secure the unimpeded flow of traffic twenty-four (24) hours daily.

SANDING ~ Bituminous Prime Coat, Item T-30, of Bituminous Material Sec. M-5.12 A.E. 3, applied by Distributor or by Brooms at the rate of not more than 0.1 Gal. per Sq. Yd. and Sand Cover applied at the rate of 4 to 7 lbs. per Sq. Yd. After the Bituminous Material has been applied any material not required to give a uniform coating to the surface shall be swept into all open joints before the Sand Cover is placed. Payment for Sand Cover is included in the price bid per gallon for Bituminous Material.

Note:- T-35 Surface Course is to be feathered out at Railroad Crossings and at junction with existing pavements at beginning and end of project and at intersecting streets and private drives in the manner directed by the Engineer in Charge.

UTILITIES ~ Water Valve Boxes in the resurfaced areas shall be adjusted to the new grade by the Village of Gibsonburg.

MANHOLE & POOL GRATE CASTINGS ~ Existing Manhole and Pool Grate Castings within the pavement area shall be adjusted to the surface level of the new Asphaltic Concrete Surface in a manner approved by the Engineer in charge. Average adjustment equals approximately two (2) inches. The unit price bid per "Existing Manhole and Pool Grate Castings Adjusted to Grade" includes the payment for the necessary removal and reconstruction of existing pavement adjacent to the Manhole or Pool Grate Castings.

SUMMARY OF EXTRA PAVEMENT

Sheet No.	Area to be Surfaced Sq. Yds.	B35 Variable Leveling Course Cu.Yds.	T-35 1" Surface Bituminous Prime Coat Cu.Yds.	T-30 Gals.
3	163.5	3.32	4.58	16.8
4	242.5	4.86	6.76	24.7
5	334.5	6.58	9.34	33.9
6	182.5	3.55	5.10	18.7
Totals	923.0	18.31	25.78	94.1

SUMMARY OF PAVEMENT REMOVAL

Sheet No.	Removal of Existing Bituminous Macadam Surface Course Sq. Yds.
3	16
4	1
5	7
6	4
Total	12
Totals	12
	8

SUMMARY OF MANHOLE TOPS & POOL GRATES ADJUSTED TO GRADE


Sheet No.	Existing Manhole Tops Adjusted to Grade Each	Existing Pool Grates Adjusted to Grade Each
3	16	2
4	1	
5	7	6
6	4	
Total	12	8

~ GENERAL SUMMARY ~


Item	Description	Quantity	Unit
E-8	Roadway Removal of Existing Bituminous Macadam Surface Course 15 Sq.Yds.		
I-8	Existing Pool Grate Inlet Castings Adjusted to Grade 8 Each		
I-8	Existing Manhole Castings Adjusted to Grade 12 Each		
	Pavement		
T-30	Bituminous Prime Coat (Sec. M-5.12, A.E. 3) including sand cover 2069 Gal.		
B-35	1" Minimum Thickness Asphaltic Concrete Leveling Course 692 Cu.Yds.		
T-35	1" Asphaltic Concrete Surface Course, Type "B" 575 Cu.Yds.		

10 OHIO 1939
SANDUSKY COUNTY
S.H. 931 SEC. GIBSONBURG (PT.)

3
9

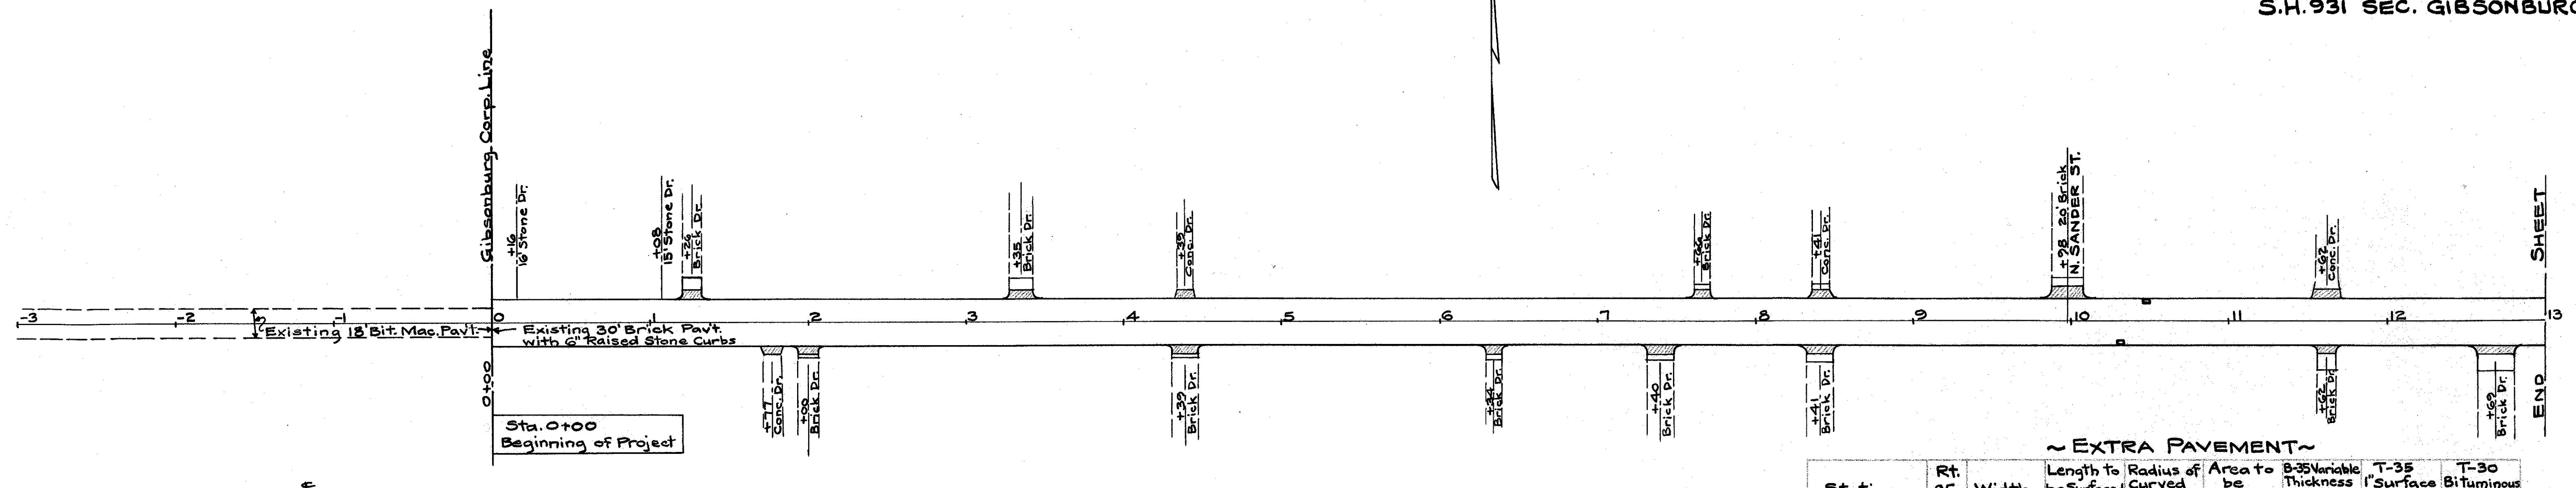

TYPICAL SECTION ADJOINING PAVEMENT

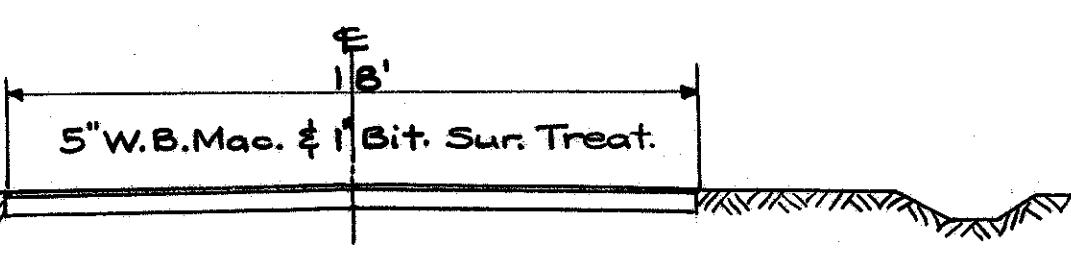

B.M. North Bolt Hydrant, Lt. of Sta. 0+55
Elev. 683.73

PAVEMENT REMOVAL


Station	Removal of Existing Bit. Mac. Surface Course Sq.Yds.
From 0+00	To 0+04.5
Total	15

POOL GRATE INLETS ADJUSTED TO GRADE

Station	Rt. or Lt.	Existing Pool Grates Adjusted to Grade~Each
10+39	Rt.	1
10+49	Lt.	
Total		2

Station	Rt. or Lt.	Width Lin.Ft.	Length to be Surfaced Lin.Ft.	Radius of Curved Curb Lin.Ft.	Area to be Surfaced Sq.Yds.	B-35 Variable Thickness Cu.Yds.	T-35 Surface Course Cu.Yds.	T-30 Bituminous Prime Coat Gals.
0+16	Lt.				0	0	0.27	1.0
1+08	Lt.				0	0	0.27	1.0
1+26	Lt.	12.5	6	6	9.5	0.20	0.27	1.0
1+77	Rt.	8.0	6	6	5.5	0.10	0.16	0.6
2+00	Rt.	12.0	6	6	9.5	0.20	0.27	1.0
3+35	Lt.	15.0	6	6	11.5	0.25	0.32	1.2
4+39	Rt.	17.0	6	6	12.5	0.25	0.35	1.3
4+39	Lt.	8.0	6	6	5.5	0.10	0.16	0.6
6+34	Rt.	10.0	6	6	8.0	0.18	0.22	0.8
7+40	Rt.	17.0	6	6	12.5	0.25	0.35	1.3
7+66	Lt.	10.0	6	6	8.0	0.18	0.22	0.8
8+41	Lt.	10.0	6	6	8.0	0.18	0.22	0.8
8+41	Rt.	17.0	6	6	12.5	0.25	0.35	1.3
9+98	Lt.	20.0	6	6	21.0	0.40	0.59	2.1
11+62	Rt.	11.5	6	6	8.0	0.18	0.22	0.8
11+62	Lt.	18.0	6	6	12.5	0.25	0.35	1.3
12+69	Rt.	24.0	6	6	19.0	0.35	0.53	1.9
Totals					163.5	3.32	4.58	16.8

Profile of Existing Pavement

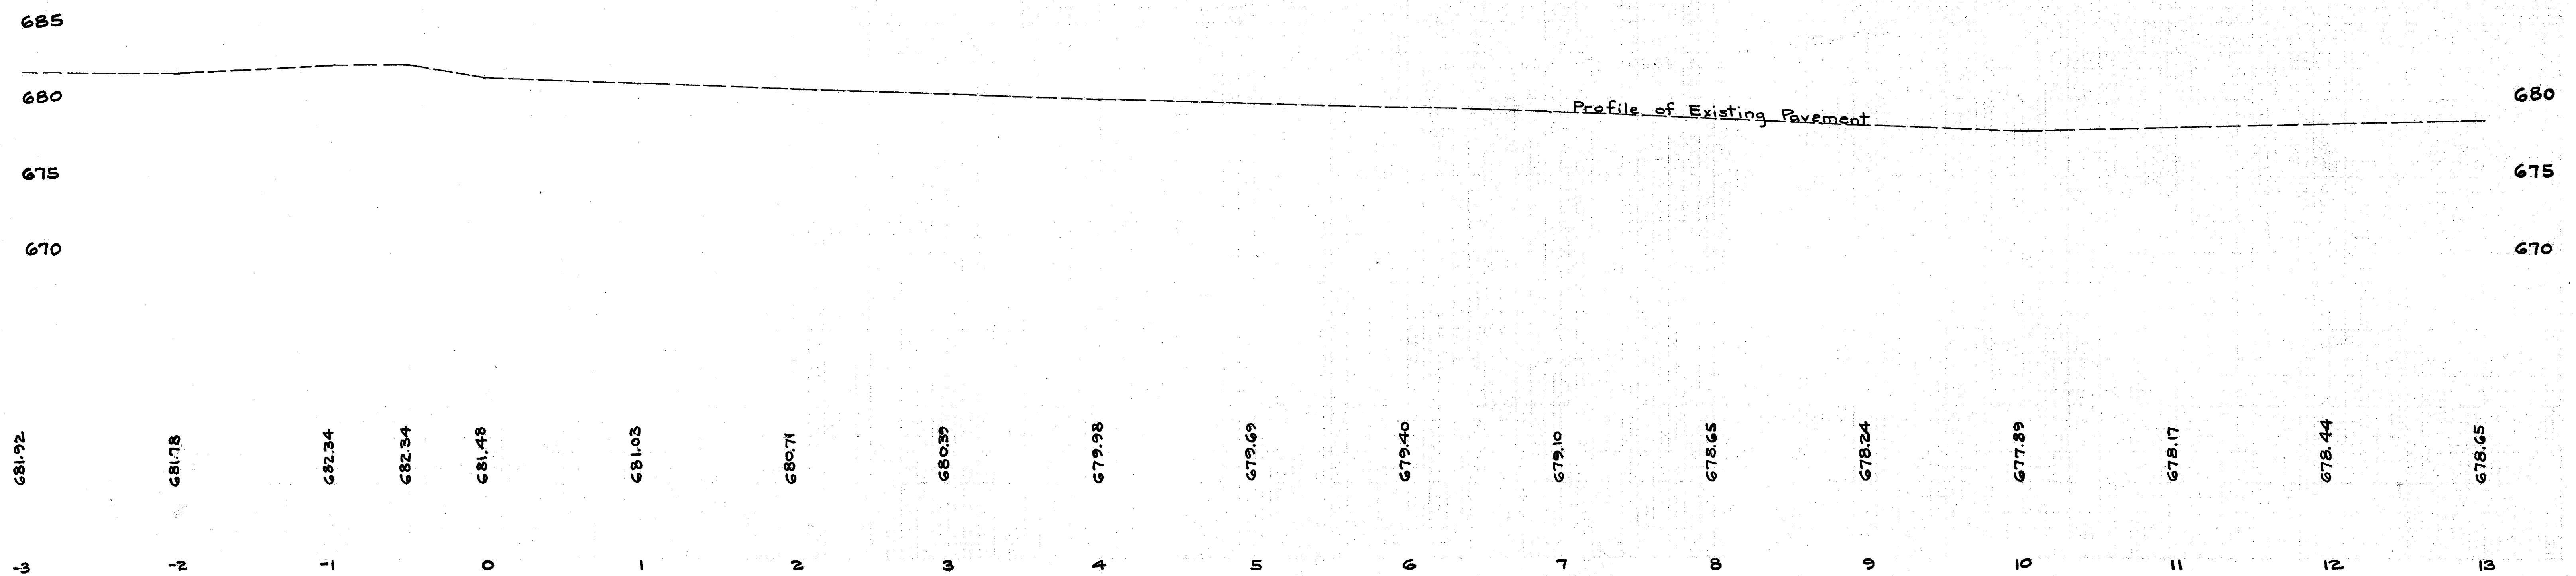

10 OHIO

1939

SANDUSKY COUNTY
S.H. 931 SEC. GIBSONBURG (PT.)

